



State of California – The Natural Resources Agency
DEPARTMENT OF FISH AND WILDLIFE
Bay Delta Region
2825 Cordelia Road, Suite 100
Fairfield, CA 94534
(707) 428-2002
www.wildlife.ca.gov

EDMUND G. BROWN JR., Governor
CHARLTON H. BONHAM, Director



rec'd
10/29/18

October 12, 2018

Mr. Johannes Hoevertsz
Sonoma County Department of Transportation and Public Works
2300 County Center Drive, B100
Santa Rosa, CA 95403

Dear Mr. Hoevertsz:

Subject: Incidental Take Permit for Little Wohler Bridge Replacement, Sonoma County,
2081-2018-007-03

Enclosed you will find two originals of the Incidental Take Permit for the above referenced project, which have been signed by the California Department of Fish and Wildlife (CDFW). Please read the permit carefully, sign the acknowledgement on both copies of the permit, and return one original no later than 30 days from CDFW signature and prior to initiation of ground-disturbing activities to:

Habitat Conservation Planning Branch
California Department of Fish and Wildlife
Attention: CESA Permitting Program
Post Office Box 944209
Sacramento, CA 94244-2090

You are advised to keep the other original signature permit in a secure location and distribute copies to appropriate project staff responsible for ensuring compliance with the conditions of the permit. Note that you are required to comply with certain conditions of approval prior to initiation of ground-disturbing activities. Additionally, a copy of the permit must be maintained at the project work site and made available for inspection by CDFW staff when requested.

The permit will not take effect until the signed acknowledgment is received by CDFW. If you wish to discuss these instructions or have questions regarding the permit, please contact Mr. James Hansen, Environmental Scientist, at (707) 576-2869; or Ms. Karen Weiss, Senior Environmental Scientist (Supervisory), at (707) 944-5525.

Sincerely,

Gregg Erickson
Regional Manager
Bay Delta Region

Enclosures

cc: California Department of Fish and Wildlife
Ryan Mathis – Habitat Conservation Planning Branch, Sacramento
James Hansen – Bay Delta Region, Napa
Karen Weiss – Bay Delta Region, Napa
Craig Weightman – Bay Delta Region, Napa

Conserving California's Wildlife Since 1870



California Department of Fish and Wildlife
Bay Delta Region
2825 CORDELIA ROAD, SUITE 100
FAIRFIELD, CA 94534

California Endangered Species Act
Incidental Take Permit No. 2081-2018-007-03

LITTLE WOHLER BRIDGE REPLACEMENT

Authority: This California Endangered Species Act (CESA) incidental take permit (ITP) is issued by the California Department of Fish and Wildlife (CDFW) pursuant to Fish and Game Code section 2081, subdivisions (b) and (c), and California Code of Regulations, Title 14, section 783.0 et seq. CESA prohibits the take¹ of any species of wildlife designated by the California Fish and Game Commission as an endangered, threatened, or candidate species.² CDFW may authorize the take of any such species by permit if the conditions set forth in Fish and Game Code section 2081, subdivisions (b) and (c) are met. (See Cal. Code Regs., tit. 14, § 783.4).

Permittee:	Sonoma County Department of Transportation and Public Works
Principal Officer:	Johannes Hoevertsz
Contact Person:	Mary Nicholl, (707) 565-1367
Mailing Address:	2300 County Center Drive, B100 Santa Rosa, CA 95403

Effective Date and Expiration Date of this ITP:

This ITP shall be executed in duplicate original form and shall become effective once a duplicate original is acknowledged by signature of the Permittee on the last page of this ITP and returned to CDFW's Habitat Conservation Planning Branch at the address listed in the Notices section of this ITP. Unless renewed by CDFW, this ITP's authorization to take the Covered Species shall expire on **December 31, 2022**.

Notwithstanding the expiration date on the take authorization provided by this ITP, Permittee's obligations pursuant to this ITP do not end until CDFW accepts as complete the Permittee's Final Mitigation Report required by Condition of Approval 7.7 of this ITP.

¹ Pursuant to Fish and Game Code section 86, "'take' means hunt, pursue, catch, capture, or kill, or attempt to hunt, pursue, catch, capture, or kill." (See also *Environmental Protection Information Center v. California Department of Forestry and Fire Protection* (2008) 44 Cal.4th 459, 507 [for purposes of incidental take permitting under Fish and Game Code section 2081, subdivision (b), "'take' ... means to catch, capture or kill".])

² "The definition of an endangered, threatened, and candidate species for purposes of CESA are found in Fish and Game Code sections 2062, 2067, and 2068, respectively.

Project Location:

The Little Wohler Bridge Replacement project (Project) is located on Mark West Creek where Wohler Road crosses the creek, within the City of Forestville, County of Sonoma, State of California (See Figure 1). The Project is located approximately 650 feet north of the Intersection of Wohler Road and River Road, at approximately 38.492400 N, -122.883417 W.

Project Description:

The Project includes the removal of an existing seven-span reinforced concrete girder bridge measuring 134 feet long and 20 feet wide. This includes removal of 15 piles within the channel over 30 square feet and 22 piles within the banks over 45 square feet. The replacement bridge will be just upstream with a new three-span concrete slab bridge measuring 125 feet long and 40 feet wide; all new piles will be cast in Drilled Hole piers and within the banks of the channel (Figure 2). This Project will occur over two years. The first construction season will include placement of approximately 70 linear feet of K-rails on the creek bank, cutting of upstream benches for cranes, and construction of abutment piles and abutment walls. The second construction season will include extended placement of K-rails along the creek bank (approximately 190 linear feet total), cutting of downstream benches for cranes, construction of the new the bridge, placement of rock slope protection, removal of the existing bridge, placement of K-rails in an approximately 100-linear foot section of the creek, dewatering that section, and removal of piles, revegetation, habitat restoration, and mitigation plantings will occur immediately after the second construction season (Figure 3). Project activities will temporarily impact 100 linear feet, approximately 3,500 square feet of the creek from dewatering, permanently impact approximately 0.11 acres (4,777 square feet) of existing upland riparian area from the placement of the new bridge abutments and associated rock slope protection, and will temporarily impact approximately 0.34 acres (15,000 square feet) of existing riparian area from vegetation removal for project access. The Project will restore approximately 0.34 acres (15,000 square feet) of temporarily impacted riparian habitat, restore and enhance 0.52 acres (22,500 square feet) of riparian habitat, remove 15 piles in the channel over 30 square feet, and will install a single large rootwad habitat feature (Figure 4).

Construction activities within the channel will be completed in approximately 12 days, and the entire Project will be completed within approximately 18 months.

Covered Species Subject to Take Authorization Provided by this ITP:

This ITP covers the following species:

Name	CESA Status
1. Coho salmon, south of Punta Gorda, (<i>Oncorhynchus kisutch</i>)	Endangered ³

This species and only this species is the "Covered Species" for the purposes of this ITP.

Impacts of the Taking on Covered Species:

Project activities and their resulting impacts are expected to result in the incidental take of individuals of the Covered Species. The activities described above expected to result in incidental take of individuals of the Covered Species include approximately 12 days of temporary dewatering an

³ See Cal. Code Regs. tit. 14 § 670.5, subd. (a)(2)(N)

approximately 100-foot long channel reach (3,500 square feet) for an entire construction season (Covered Activities) (Figure 3). Temporarily dewatering the 100-foot long channel is necessary to remove 15 pier pilings, which will permanently provide additional instream coho habitat.

Incidental take of individuals of the Covered Species in the form of mortality ("kill") may occur as a result of Covered Activities such as in-channel construction, dewatering and Project-related habitat loss. Incidental take of individuals of the Covered Species may also occur from the Covered Activities in the form of catch and capture of the Covered Species during temporary dewatering, fish rescue operations, and monitoring. Additional indirect impacts may occur due to minor changes in local drainage patterns, reducing water quality due to increased turbidity, inhibiting movement and potential changes in flow velocities. Removal of trees in the riparian habitat will temporarily affect perennial stream habitat by reducing overstory shade, which may reduce habitat quality by increasing water temperatures, and lowering dissolved oxygen levels. The areas where authorized take of the Covered Species is expected to occur are within the wetted channel throughout the Project site (collectively, the Project Area).

The Project is expected to cause the temporary loss of approximately 100 linear feet of in-stream habitat as a result of dewatering. Impacts of the authorized taking also include adverse impacts to the Covered Species related to temporal losses, increased habitat fragmentation and edge effects, and the Project's incremental contribution to cumulative impacts (indirect impacts). These impacts include: capture and relocation, harassment resulting from noise and ground vibration during heavy equipment operation, long-term effects due to increased rock substrate, and increased vulnerability to predation and displacement from preferred habitat.

Incidental Take Authorization of Covered Species:

This ITP authorizes incidental take of the Covered Species and only the Covered Species. With respect to incidental take of the Covered Species, CDFW authorizes the Permittee, its employees, contractors, and agents to take Covered Species incidentally in carrying out the Covered Activities, subject to the limitations described in this section and the Conditions of Approval identified below. This ITP does not authorize take of Covered Species from activities outside the scope of the Covered Activities, take of Covered Species outside of the Project Area, take of Covered Species resulting from violation of this ITP, or intentional take of Covered Species except for capture and relocation of Covered Species as authorized by this ITP.

Conditions of Approval:

Unless specified otherwise, the following measures apply to all Covered Activities within the Project Area, including river access areas used for equipment that may cause take. CDFW's issuance of this ITP and Permittee's authorization to take the Covered Species are subject to Permittee's compliance with and implementation of the following Conditions of Approval:

- 1. Legal Compliance:** Permittee shall comply with all applicable federal, state, and local laws in existence on the effective date of this ITP or adopted thereafter.
- 2. CEQA Compliance:** Permittee shall implement and adhere to the mitigation measures related to the Covered Species in the Biological Resources section of the Mitigated Negative Declaration and Initial Study (SCH No.:2007042060) adopted by Sonoma County on June 5, 2007, as lead agency for the Project pursuant to the California Environmental Quality Act (CEQA) (Pub. Resources Code, § 21000 et seq.).

3. **LSA Agreement Compliance:** Permittee shall implement and adhere to the mitigation measures and conditions related to the Covered Species in the Lake and Streambed Alteration Agreement (LSAA) (Notification No. 1600-2018-0034-R3) for the Project executed by CDFW pursuant to Fish and Game Code section 1600 et seq.
4. **ESA Compliance:** Permittee shall implement and adhere to the terms and conditions related to the Covered Species in federal Endangered Species Act (ESA) Section 7(a)(2) Biological Opinion for the Wohler Road Bridge Replacement, National Marine Fisheries Service Consultation Number WCR-2017-8205, for the Project pursuant to ESA. For purposes of this ITP, where the terms and conditions for the Covered Species in the federal authorization are less protective of the Covered Species or otherwise conflict with this ITP, the conditions of approval set forth in this ITP shall control.
5. **ITP Time Frame Compliance:** Permittee shall fully implement and adhere to the conditions of this ITP within the time frames set forth below and as set forth in the Mitigation Monitoring and Reporting Program (MMRP), which is included as Attachment 1 to this ITP.
6. **General Provisions:**
 - 6.1. Designated Representative. Before starting Covered Activities, Permittee shall designate a representative (Designated Representative) responsible for communications with CDFW and overseeing compliance with this ITP. Permittee shall notify CDFW in writing before starting Covered Activities of the Designated Representative's name, business address, and contact information, and shall notify CDFW in writing if a substitute Designated Representative is selected or identified at any time during the term of this ITP. Permittee shall obtain CDFW approval of the Designated Biologist in writing before starting Covered Activities, and shall also obtain approval in advance in writing if the Designated Biologist must be changed.
 - 6.2. Designated Biologist. Permittee shall submit to CDFW in writing the name, qualifications, business address, and contact information of a biological monitor (Designated Biologist) at least 30 days before starting Covered Activities. Permittee shall ensure that the Designated Biologist is knowledgeable and experienced in the biology, natural history, including collecting and handling of the Covered Species. The Designated Biologist shall be responsible for monitoring Covered Activities to help minimize and fully mitigate or avoid the incidental take of individual Covered Species and to minimize disturbance of Covered
 - 6.3. Designated Biologist Authority. To ensure compliance with the Conditions of Approval of this ITP, the Designated Biologist shall have authority to immediately stop any activity that does not comply with this ITP, and/or to order any reasonable measure to avoid the unauthorized take of an individual of the Covered Species in consultation with CDFW.
 - 6.4. Education Program. Permittee shall conduct an education program for all persons employed or otherwise working in the Project Area before performing any work. The program shall consist of a presentation from the Designated Biologist that includes a discussion of the biology and general behavior of the Covered Species, information about the distribution and habitat needs of the Covered Species, sensitivity of the Covered Species to human activities, its status pursuant to CESA including legal protection, recovery efforts, penalties

for violations and Project-specific protective measures described in this ITP. Permittee shall provide interpretation for non-English speaking workers, and the same instruction shall be provided to any new workers before they are authorized to perform work in the Project Area. Permittee shall prepare and distribute wallet-sized cards or a fact sheet handout containing this information for workers to carry in the Project Area. Upon completion of the program, employees shall sign a form stating they attended the program and understand all protection measures. This training shall be repeated at least once annually for long-term and/or permanent employees that will be conducting work in the Project Area.

- 6.5. Construction Monitoring Notebook. The Designated Biologist shall maintain a construction-monitoring notebook on-site throughout the construction period, which shall include a copy of this ITP with attachments and a list of signatures of all personnel who have successfully completed the education program. Permittee shall ensure a copy of the construction-monitoring notebook is available for review at the Project site upon request by CDFW.
- 6.6. Trash Abatement. Permittee shall initiate a trash abatement program before starting Covered Activities and shall continue the program for the duration of the Project. Permittee shall ensure that trash and food items are contained in animal-proof containers and removed at least once a week to avoid attracting opportunistic predators such as ravens, coyotes, and feral dogs.
- 6.7. Dust Control. Permittee shall implement dust control measures during Covered Activities to facilitate visibility for monitoring of the Covered Species by the Designated Biologist. Permittee shall keep the amount of water used to the minimum amount needed, and shall not allow water to form puddles.
- 6.8. Erosion Control Materials. Permittee shall prohibit use of erosion control materials potentially harmful to Covered Species and other species, such as monofilament netting (erosion control matting) or similar material, in potential Covered Species' habitat.
- 6.9. Delineation of Property Boundaries. Before starting Covered Activities, Permittee shall clearly delineate the boundaries of the Project Area with fencing, stakes, or flags. Permittee shall restrict all Covered Activities to within the fenced, staked, or flagged areas. Permittee shall maintain all fencing, stakes, and flags until the completion of Covered Activities in that area.
- 6.10. Delineation of Habitat. Permittee shall clearly delineate habitat of the Covered Species within the Project Area with posted signs, posting stakes, flags, and/or rope or cord, and place fencing as necessary to minimize the disturbance of Covered Species' habitat.
- 6.11. Project Access. Project-related personnel shall access the Project Area using existing routes, or routes identified in the Project Description and shall not cross Covered Species' habitat outside of or en route to the Project Area. Permittee shall restrict Project-related vehicle traffic to established roads, staging, and parking areas. If Permittee determines construction of routes for travel are necessary outside of the Project Area, the Designated Representative shall contact CDFW for written approval before carrying out such an activity. CDFW may require an amendment to this ITP, among other reasons, if additional take of Covered Species will occur as a result of the Project modification.

- 6.12. Staging Areas. Permittee shall confine all Project-related parking, storage areas, laydown sites, equipment storage, and any other surface-disturbing activities to the Project Area using, to the extent possible, previously disturbed areas. Additionally, Permittee shall not use or cross Covered Species' habitat outside of the marked Project Area unless provided for as described in Condition of Approval 6.11 of this ITP.
- 6.13. Hazardous Waste. Permittee shall immediately stop and, pursuant to pertinent state and federal statutes and regulations, arrange for repair and clean up by qualified individuals of any fuel or hazardous waste leaks or spills at the time of occurrence, or as soon as it is safe to do so. Permittee shall exclude the storage and handling of hazardous materials from the Project Area and shall properly contain and dispose of any unused or leftover hazardous products off-site.
- 6.14. CDFW Access. Permittee shall provide CDFW staff with reasonable access to the Project and mitigation lands under Permittee control, and shall otherwise fully cooperate with CDFW efforts to verify compliance with or effectiveness of mitigation measures set forth in this ITP.
- 6.15. Refuse Removal. Upon completion of Covered Activities, Permittee shall remove from the Project Area and properly dispose of all temporary fill and construction refuse, including, but not limited to, broken equipment parts, wrapping material, cords, cables, wire, rope, strapping, twine, buckets, metal or plastic containers, and boxes.

7. Monitoring, Notification and Reporting Provisions:

- 7.1. Notification Before Commencement. The Designated Representative shall notify CDFW 14 calendar days before starting Covered Activities and shall document compliance with all pre-Project Conditions of Approval before starting Covered Activities.
- 7.2. Notification of Non-compliance. The Designated Representative shall immediately notify CDFW in writing if it determines that the Permittee is not in compliance with any Condition of Approval of this ITP, including but not limited to any actual or anticipated failure to implement measures within the time periods indicated in this ITP and/or the MMRP. The Designated Representative shall report any non-compliance with this ITP to CDFW within 24 hours.
- 7.3. Compliance Monitoring. The Designated Biologist shall be on-site daily when Covered Activities occur. The Designated Biologist shall conduct compliance inspections to (1) minimize incidental take of the Covered Species; (2) prevent unlawful take of species; (3) check for compliance with all measures of this ITP; (4) check all exclusion zones; and (5) ensure that signs, stakes, and fencing are intact, and that Covered Activities are only occurring in the Project Area. The Designated Representative or Designated Biologist shall prepare daily written observation and inspection records summarizing: oversight activities and compliance inspections, observations of Covered Species and their sign, survey results, and monitoring activities required by this ITP. The Designated Biologist shall conduct compliance inspections a minimum of once a week during periods of inactivity and after de-watering and riparian vegetation removal are completed.

- 7.4. Quarterly Compliance Report. The Designated Representative or Designated Biologist shall compile the observation and inspection records identified in Condition of Approval 7.3 into a Quarterly Compliance Report and submit it to CDFW along with a copy of the MMRP table with notes showing the current implementation status of each mitigation measure. Quarterly Compliance Reports shall be submitted to the CDFW offices listed in the Notices section of this ITP and via e-mail to CDFW's Regional Representative and Headquarters CESA Program. At the time of this ITP's approval, the CDFW Regional Representative is James Hansen (James.Hansen@wildlife.ca.gov) and Headquarters CESA Program email is CESA@wildlife.ca.gov. CDFW may at any time increase the timing and number of compliance inspections and reports required under this provision depending upon the results of previous compliance inspections. If CDFW determines the reporting schedule must be changed, CDFW will notify Permittee in writing of the new reporting schedule.
- 7.5. Annual Status Report. Permittee shall provide CDFW with an Annual Status Report (ASR) no later than January 31 of every year beginning with issuance of this ITP and continuing until CDFW accepts the Final Mitigation Report identified below. Each ASR shall include, at a minimum: (1) a summary of all Quarterly Compliance Reports for that year identified in Condition of Approval 7.4; (2) a general description of the status of the Project Area and Covered Activities, including actual or projected completion dates, if known; (3) a copy of the table in the MMRP with notes showing the current implementation status of each mitigation measure; (4) an assessment of the effectiveness of each completed or partially completed mitigation measure in avoiding, minimizing and mitigating Project impacts; (5) all available information about Project-related incidental take of the Covered Species; (6) an accounting of the number of acres subject to both temporary and permanent disturbance, both for the prior calendar year, and a total since ITP issuance; and (7) information about other Project impacts on the Covered Species.
- 7.6. CNDDDB Observations. The Designated Biologist shall submit all observations of Covered Species to CDFW's California Natural Diversity Database (CNDDDB) within 60 calendar days of the observation and the Designated Biologist shall include copies of the submitted forms with the next Quarterly Compliance Report or ASR, whichever is submitted first relative to the observation.
- 7.7. Final Mitigation Report. No later than 45 days after completion of all mitigation measures, Permittee shall provide CDFW with a Final Mitigation Report. The Designated Biologist shall prepare the Final Mitigation Report which shall include, at a minimum: (1) a summary of all Quarterly Compliance Reports and all ASRs; (2) a copy of the table in the MMRP with notes showing when each of the mitigation measures was implemented; (3) all available information about Project-related incidental take of the Covered Species; (4) information about other Project impacts on the Covered Species; (5) beginning and ending dates of Covered Activities; (6) an assessment of the effectiveness of this ITP's Conditions of Approval in minimizing and fully mitigating Project impacts of the taking on Covered Species; (7) recommendations on how mitigation measures might be changed to more effectively minimize take and mitigate the impacts of future projects on the Covered Species; and (8) any other pertinent information.

7.8. Notification of Take or Injury. Permittee shall immediately notify the Designated Biologist if a Covered Species is taken or injured by a Project-related activity, or if a Covered Species is otherwise found dead or injured within the vicinity of the Project. The Designated Biologist or Designated Representative shall provide initial notification to CDFW by calling the Regional Office at (707) 428-2002. The initial notification to CDFW shall include information regarding the location, species, and number of animals taken or injured and the ITP Number. Following initial notification, Permittee shall send CDFW a written report within two calendar days. The report shall include the date and time of the finding or incident, location of the animal or carcass, and if possible provide a photograph, explanation as to cause of take or injury, and any other pertinent information.

8. Take Minimization Measures:

The following requirements are intended to ensure the minimization of incidental take of Covered Species in the Project Area during Covered Activities. Permittee shall implement and adhere to the following conditions to minimize take of Covered Species:

- 8.1. Work Window. Permittee shall conduct Covered Activities between June 15 and October 15 of any year.
- 8.2. Work Period. Work within the Project Area shall be confined to the period of June 15 to October 15. Any extension of the work period will require an amendment to this ITP. The amendment request for a work period extension shall: 1) describe the extent of work already completed; 2) detail the activities that remain to be completed; 3) detail the time required to complete each of the remaining activities; 4) provide photographs of both the current work completed and the proposed site for continued work; and 5) include an assessment of the impacts of the work extension of Covered Species.
- 8.3. Work in Isolation from Flowing Water. All in-water work within Mark West Creek shall be conducted inside cofferdams or leak proof K-rails and in isolation from flowing water.
- 8.4. Work According to Plans. All Covered Species habitat enhancement work shall be completed according to 'construction ready' plans. *Wohler Road Bridge at Mark West Creek Replacement*, prepared by Biggs Cardosa Associates INC., dated May, 2018 (Figure 2); *Dewatering Plan Figures* prepared by Sonoma County Department of Transportation and Public Works (DTPW), dated April 2018 (Figure 3); and *Environmental Exhibit*, prepared by BKF Engineers, dated April 2018 (Figure 4), where further detailed plans shall be reviewed and accepted by CDFW within 60 days of final ITP issuance. The Permittee shall notify CDFW if modifications are made to any Attachment listed in this ITP prior to construction. At the discretion of CDFW, minor plan modifications may require an amendment to this ITP.
- 8.5. Covered Species Entrainment. Permittee shall minimize the potential for Covered Species to be entrained during de-watering activities. The Permittee shall implement the use of a screen in accordance with the National Marine Fisheries Service 1996 Juvenile Fish Screen Criteria for Pump Intakes. Screen material may be constructed of any rigid woven, perforated, or slotted material that provides water passage while physically excluding fish. Round openings in the screen shall not exceed 3/32-inch diameter, square openings shall not exceed 3/32-inch measured diagonally, and slotted openings shall not exceed 0.069

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SONOMA COUNTY DEPARTMENT OF TRANSPORTATION AND PUBLIC WORKS
LITTLE WOHLER BRIDGE REPLACEMENT

inches in width. Approach velocity shall not exceed 0.33 feet per second.

- 8.6. Covered Species Dewatering and Rescue Plan. The Permittee shall implement a detailed Dewatering and Covered Species Rescue Plan to include, at a minimum, the following measures:
- a) Only a CDFW-approved biologist with experience in Covered Species capture and handling shall participate in the capture, handling, and monitoring of Covered Species.
 - b) Relocation activities shall be performed during the morning when temperatures are coolest. Hourly air and water temperatures shall be measured and recorded.
 - c) Before removal and relocation of Covered Species, the Designated Biologist shall identify the most appropriate release location(s). Release locations shall provide suitable habitat for Covered Species and shall be selected to minimize the likelihood of reentering the work area. Suitable habitat is defined as creek sections that will remain wet over the summer.
 - d) Following installation of water diversion structures, and prior to Project activities, a CDFW-approved biologist shall perform surveys for Covered Species in the Project Area, collect, and relocate them to the nearest predetermined suitable habitat. During holding and transportation, Covered Species shall be held in stream water collected from the site.
 - e) Prior to fully dewatering the Project Area, remaining Covered Species in the work area shall be rescued. Dewatering efforts shall be monitored by the Designated Biologist at all times. The Designated Biologist shall reduce the rate of diversion if it appears that Covered Species may be stranded.
 - f) Efforts shall be made to reduce collecting and handling stress, minimize the time that Covered Species are held in buckets, and minimize handling stress during processing and release. Covered Species shall not be held in containers with other species. If not immediately released, buckets must be kept in the shade and water temperatures monitored to be consistent with the temperature in the creek. Immediately after collection, Covered Species shall be identified and counted. Capture methods may include dip nets. All nets shall be made of a soft braded nylon material that is non-abrasive. Mesh sizing shall be matched to species and the life stages likely encountered.
 - g) No employee or contractor shall remove any Covered Species, dead or alive, from the site for personal use. All efforts to reduce the time that live Covered Species are out of the water shall be made to reduce the chances of incidental take during the rescue. All Covered Species are to be promptly returned to the water with the exception of mortality.
 - h) Covered Species shall be processed first and released as soon as possible. Species name and length data will be recorded on data sheets, as well as time, date, location, gear type, water temperature, and any other pertinent observations of the Covered Species.

- i) Rescue operations may result in Covered Species mortality. If Covered Species suffer mortality, the Permittee shall preserve individuals by freezing or placing in a sealed container with 10 percent formalin solution. Information on time and exact location of any incidental take, method of take, length of time from death to preservation, water temperature, and any other relevant information will be recorded in writing. Permittee shall contact the CDFW regional representative for instructions on transmitting preserved individuals.
- j) After completing the rescue, a brief documentation report shall be prepared. The report shall include information on the personnel conducting the Covered Species rescue, methods used, numbers of Covered Species collected and relocated, length data, and estimate of the survival of Covered Species immediately after release. Photographs of the site and rescue operations shall be included. Any take of non-Covered Species shall be documented. The report shall be provided by the Permittee to CDFW in the next Quarterly Compliance Report required by Condition of Approval 7.4.
- k) After the Covered Species rescue effort is completed, if additional Covered Species are observed, Project activities shall cease until those individuals have been relocated. The Designated Biologist shall remain at the site during dewatering to rescue additional Covered Species as necessary.
- l) Reintroduction of stream flows shall be gradual to the isolated work area, so as to prevent stranding, channel instability, or excessive scour. The Designated Biologist shall monitor upstream and downstream reaches to ensure no Covered Species are stranded or in distress during reintroduction of flows. If conditions causing or contributing to stress and/or injury are observed, the Permittee shall take immediate remedial actions directed at lessening sources of stress. This may include a more gradual reintroduction of flows, to avoid abrupt water surface elevation changes both downstream and upstream of the Project Area.

9. Habitat Creation, Restoration and Management:

CDFW has determined that habitat restoration, enhancement and long-term management of compensatory habitat is necessary and required pursuant to CESA to fully mitigate Project-related impacts of the taking on the Covered Species that will result with implementation of the Covered Activities. This determination is based on factors including an assessment of the importance of the habitat in the Project Area, the extent to which the Covered Activities will impact the habitat, and CDFW's estimate of the acreage required to provide for adequate compensation.

To meet this requirement, the Permittee shall restore approximately 15,000 square feet of temporary riparian habitat disturbance on-site, enhance and restore approximately 22,500 square feet of riparian habitat on-site that is contiguous with other Covered Species habitat adjacent to the Project site, restore 30 square feet of creek channel, and install a Covered Species Rootwad Habitat Feature, and manage the Habitat Management (HM) pursuant to Conditions of Approval 9.1 and 9.2 below. Long-term funding for monitoring and management of created Covered Species habitat must be complete before starting Covered Activities or within 18 months of the effective date of this ITP if Security is provided pursuant to Condition of Approval 10 below for all uncompleted obligations.

9.1. Cost Estimates. CDFW has estimated the cost of habitat creation, restoration, enhancement, and interim management of riparian vegetation enhancement and restoration as follows:

- 9.1.1. Habitat improvement costs for restoration of 30 square feet of creek channel, estimated at \$55,000.
- 9.1.2. Habitat restoration and enhancement costs for a total of 37,500 square feet of riparian habitat, and habitat creation costs for a large rootwad habitat feature, estimated at \$56,902.50.
- 9.1.3. Long-term management funding as described in Condition of Approval 9.2, estimated at \$144,500. Management funding is estimated initially for the purpose of providing Security to ensure implementation of habitat creation, restoration, monitoring and management.

9.2. Habitat Enhancement and Long-Term Management Plan. The Permittee shall prepare a Habitat Enhancement and Long-Term Management Plan (Plan) for CDFW review and acceptance within 60 days of finalizing this ITP. The Plan shall outline restoration of approximately 15,000 square feet of temporary riparian habitat disturbance, enhancement and restoration of approximately 22,500 square feet of riparian habitat on-site that is contiguous with other Covered Species habitat adjacent to the Project site, restoration of 30 square feet of creek channel and installation of a Covered Species Rootwad Habitat Feature. The Plan shall include detailed specifications for restoring all temporarily disturbed areas and a minimum of ten years monitoring unless otherwise approved by CDFW. The Plan shall include a description of how all future management of the project area shall be conducted to enhance existing habitat:

- 1) Construction level designs for the Covered Species Rootwad Habitat feature to be located along the downstream left bank of the Project Area. The feature will be composed of a single large rootwad keyed into the rock slope protection to establish habitat complexity and refuge for juvenile and migrating salmonids.
- 2) Detailed Riparian Restoration Planting Plan including a map to scale, installation specifications for RSP pole plantings, seed mixes and application methods, species, quantity, size, and spacing.
- 3) A 10-year Long-Term Management Plan to ensure the long-term viability of the on-site mitigation, which includes a description of how all future management of the riparian enhancement and restoration will be conducted to enhance and maintain habitat for the benefit of the Covered Species. At a minimum, the Plan shall record annually: a) location and alignment of the habitat feature, b) density of plantings, c) dated photographs, d) survival of riparian restoration plantings, e) vegetation viability with success criteria, and g) recommendations for on-going adaptive management of the habitat feature and vegetation.

9.3. Management Fund. The Permittee shall ensure that HM lands are managed, maintained, and monitored as described in this ITP. After obtaining CDFW approval of the HM lands,

Permittee shall provide ten years of monitoring and management funding for activities outlined in the final accepted Plan consistent with Measure 9.2 above.

10. Performance Security

The Permittee may proceed with Covered Activities only after the Permittee has ensured funding (Security) to complete any activity required by Condition of Approval 9 that has not been completed before Covered Activities begin. Permittee shall provide Security as follows:

- 10.1. Security Amount. The Security shall be in the amount of **\$256,402.50**. This amount is based on the cost estimates identified in Condition of Approval 9.1 above.
- 10.2. Security Form. The Security shall be in the form of an irrevocable letter of credit (see Attachment 2) or another form of Security approved in advance in writing by CDFW's Office of the General Counsel.
- 10.3. Security Timeline. The Security shall be provided to CDFW before Covered Activities begin or within 30 days after the effective date of this ITP, whichever occurs first.
- 10.4. Security Holder. The Security shall be held by CDFW or in a manner approved in advance in writing by CDFW.
- 10.5. Security Transmittal. If CDFW holds the Security, Permittee shall transmit it to CDFW with a completed Mitigation Payment Transmittal Form (see Attachment 3) or by way of an approved instrument such as escrow, irrevocable letter of credit, or other.
- 10.6. Security Drawing. The Security shall allow CDFW to draw on the principal sum if CDFW, in its sole discretion, determines that the Permittee has failed to comply with the Conditions of Approval of this ITP.
- 10.7. Security Release. The Security (or any portion of the Security then remaining) shall be released to the Permittee after CDFW has conducted an on-site inspection and received confirmation that all secured requirements have been satisfied, as evidenced by:
 - Timely submission of all required reports.

Amendment:

This ITP may be amended as provided by California Code of Regulations, Title 14, section 783.6, subdivision (c), and other applicable law. This ITP may be amended without the concurrence of the Permittee as required by law, including if CDFW determines that continued implementation of the Project as authorized under this ITP would jeopardize the continued existence of the Covered Species or where Project changes or changed biological conditions necessitate an ITP amendment to ensure that all Project-related impacts of the taking to the Covered Species are minimized and fully mitigated.

Stop-Work Order:

CDFW may issue Permittee a written stop-work order requiring Permittee to suspend any Covered Activity for an initial period of up to 25 days to prevent or remedy a violation of this ITP, including but not limited to the failure to comply with reporting or monitoring obligations, or to prevent the

unauthorized take of any CESA endangered, threatened, or candidate species. Permittee shall stop work immediately as directed by CDFW upon receipt of any such stop-work order. Upon written notice to Permittee, CDFW may extend any stop-work order issued to Permittee for a period not to exceed 25 additional days. Suspension and revocation of this ITP shall be governed by California Code of Regulations, Title 14, section 783.7, and any other applicable law. Neither the Designated Biologist nor CDFW shall be liable for any costs incurred in complying with stop-work orders.

Compliance with Other Laws:

This ITP sets forth CDFW's requirements for the Permittee to implement the Project pursuant to CESA. This ITP does not necessarily create an entitlement to proceed with the Project. Permittee is responsible for complying with all other applicable federal, state, and local law.

Notices:

The Permittee shall deliver a fully executed duplicate original ITP by registered first class mail or overnight delivery to the following address:

Habitat Conservation Planning Branch
California Department of Fish and Wildlife
Attention: CESA Permitting Program
Post Office Box 944209
Sacramento, CA 94244-2090

Written notices, reports and other communications relating to this ITP shall be delivered to CDFW by registered first class mail at the following address, or at addresses CDFW may subsequently provide the Permittee. Notices, reports, and other communications shall reference the Project name, Permittee, and ITP Number (2081-2018-007-03) in a cover letter and on any other associated documents.

Original cover with attachment(s) to:

Gregg Erickson, Regional Manager
California Department of Fish and Wildlife
2825 Cordelia Rd, Suite 100
Fairfield, CA 94534
Telephone (707) 428-2002

and a copy to:

Habitat Conservation Planning Branch
California Department of Fish and Wildlife
Attention: CESA Permitting Program
Post Office Box 944209
Sacramento, CA 94244-2090

Unless Permittee is notified otherwise, CDFW's Regional Representative for purposes of addressing issues that arise during implementation of this ITP is:

Incidental Take Permit
No. 2081-2018-007-03
SONOMA COUNTY DEPARTMENT OF TRANSPORTATION AND PUBLIC WORKS
LITTLE WOHLER BRIDGE REPLACEMENT

James Hansen
California Department of Fish and Wildlife
2825 Cordelia Road, Suite 100
Fairfield, CA 94534
Telephone (707) 576-2869

Compliance with CEQA:

CDFW's issuance of this ITP is subject to CEQA. CDFW is a responsible agency pursuant to CEQA with respect to this ITP because of prior environmental review of the Project by the lead agency, Sonoma County. (See generally Pub. Resources Code, §§ 21067, 21069). The lead agency's prior environmental review of the Project is set forth in the Mitigated Negative Declaration and Initial Study (SCH No.:2007042060), dated March 2007 that Sonoma County adopted for Little Wohler Bridge Replacement on June 5, 2007. At the time the lead agency adopted the Mitigated Negative Declaration and approved the Project, it also adopted various mitigation measures for the Covered Species as conditions of Project approval.

This ITP, along with CDFW's related CEQA findings, which are available as a separate document, provide evidence of CDFW's consideration of the lead agency's Mitigated Negative Declaration for the Project and the environmental effects related to issuance of this ITP [CEQA Guidelines, § 15096, subd. (f)]. CDFW finds that issuance of this ITP will not result in any previously undisclosed potentially significant effects on the environment or a substantial increase in the severity of any potentially significant environmental effects previously disclosed by the lead agency. Furthermore, to the extent the potential for such effects exists, CDFW finds adherence to and implementation of the Conditions of Project Approval adopted by the lead agency, and that adherence to and implementation of the Conditions of Approval imposed by CDFW through the issuance of this ITP, will avoid or reduce to below a level of significance any such potential effects. CDFW consequently finds that issuance of this ITP will not result in any significant, adverse impacts on the environment.

Findings Pursuant to CESA:

These findings are intended to document CDFW's compliance with the specific findings requirements set forth in CESA and related regulations. [Fish and Game Code § 2081, subs. (b)-(c); Cal. Code Regs., tit. 14, §§ 783.4, subs. (a)-(b), 783.5, subd. (c)(2)].

CDFW finds based on substantial evidence in the ITP application, Mitigated Negative Declaration and Initial Study for Wohler Road Over Mark West creek Bridge Replacement Project, the results of site visits and consultations, and the administrative record of proceedings, that issuance of this ITP complies and is consistent with the criteria governing the issuance of ITPs pursuant to CESA:

- (1) Take of Covered Species as defined in this ITP will be incidental to the otherwise lawful activities covered under this ITP;
- (2) Impacts of the taking on Covered Species will be minimized and fully mitigated through the implementation of measures required by this ITP and as described in the MMRP. Measures include: (1) long-term habitat creation and restoration; (2) establishment of avoidance zones; (3) worker education; and (4) Quarterly Compliance Reports. CDFW evaluated factors including an assessment of the importance of the habitat in the Project Area, the extent to which the Covered Activities will impact the habitat, and CDFW's estimate of the acreage

Incidental Take Permit
No. 2081-2018-007-03

SONOMA COUNTY DEPARTMENT OF TRANSPORTATION AND PUBLIC WORKS
LITTLE WOHLER BRIDGE REPLACEMENT

required to provide for adequate compensation. Based on this evaluation, CDFW determined that restoration of 15,000 square feet of temporarily impacted riparian habitat and enhancement of 22,500 square feet of riparian habitat on-site that is contiguous with other Covered Species habitat adjacent to the Project site, installation of a Covered Species Rootwad Habitat Feature, and removal of 30 square feet of piers within the channel along with the minimization, monitoring, reporting, and funding requirements of this ITP minimizes and fully mitigates the impacts of the taking caused by the Project;


- (3) The take avoidance and mitigation measures required pursuant to the conditions of this ITP and its attachments are roughly proportional in extent to the impacts of the taking authorized by this ITP;
- (4) The measures required by this ITP maintain Permittee's objectives to the greatest extent possible;
- (5) All required measures are capable of successful implementation;
- (6) This ITP is consistent with any regulations adopted pursuant to Fish and Game Code sections 2112 and 2114;
- (7) Permittee has ensured adequate funding to implement the measures required by this ITP as well as for monitoring compliance with, and the effectiveness of, those measures for the Project; and
- (8) Issuance of this ITP will not jeopardize the continued existence of the Covered Species based on the best scientific and other information reasonably available, and this finding includes consideration of the species' capability to survive and reproduce, and any adverse impacts of the taking on those abilities in light of (1) known population trends; (2) known threats to the species; and (3) reasonably foreseeable impacts on the species from other related projects and activities. Moreover, CDFW's finding is based, in part, on CDFW's express authority to amend the terms and conditions of this ITP without concurrence of the Permittee as necessary to avoid jeopardy and as required by law.

Attachments:

FIGURE 1	<i>Project Location</i> , prepared by Sonoma County DTPW, signed May 3, 2017
FIGURE 2	<i>Wohler Road Bridge at Mark West Creek Replacement</i> prepared by Biggs Cardosa Associates INC., dated May 4, 2018
FIGURE 3	<i>Dewatering Plan Figures</i> , prepared by Sonoma County DTPW, dated April 2018
FIGURE 4	<i>Environmental Exhibit</i> , prepared by BKF Engineers, dated April 2018
ATTACHMENT 1	Mitigation Monitoring and Reporting Program
ATTACHMENT 2	Letter of Credit Form
ATTACHMENT 3	Mitigation Payment Transmittal Form

ISSUED BY THE CALIFORNIA DEPARTMENT OF FISH AND WILDLIFE

on 10-12-18.

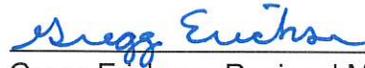

Gregg Erickson, Regional Manager
BAY DELTA REGION

ACKNOWLEDGMENT

The undersigned: (1) warrants that he or she is acting as a duly authorized representative of the Permittee, (2) acknowledges receipt of this ITP, and (3) agrees on behalf of the Permittee to comply with all terms and conditions



By: 

Date: 11-5-2018


Printed Name: Johannes J. Hoeverstz

Title: Director

Incidental Take Permit
No. 2081-2018-007-03
SONOMA COUNTY DEPARTMENT OF TRANSPORTATION AND PUBLIC WORKS
LITTLE WOHLER BRIDGE REPLACEMENT

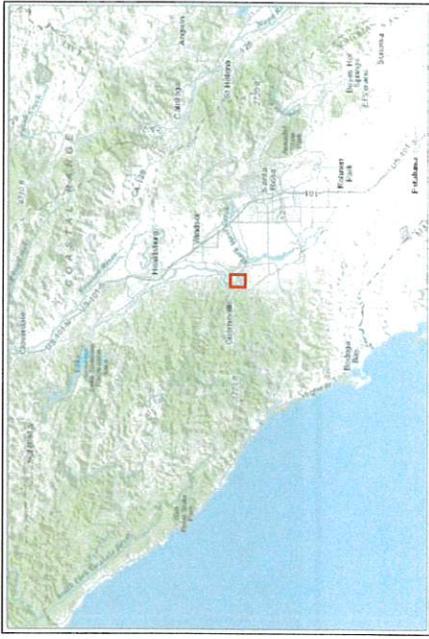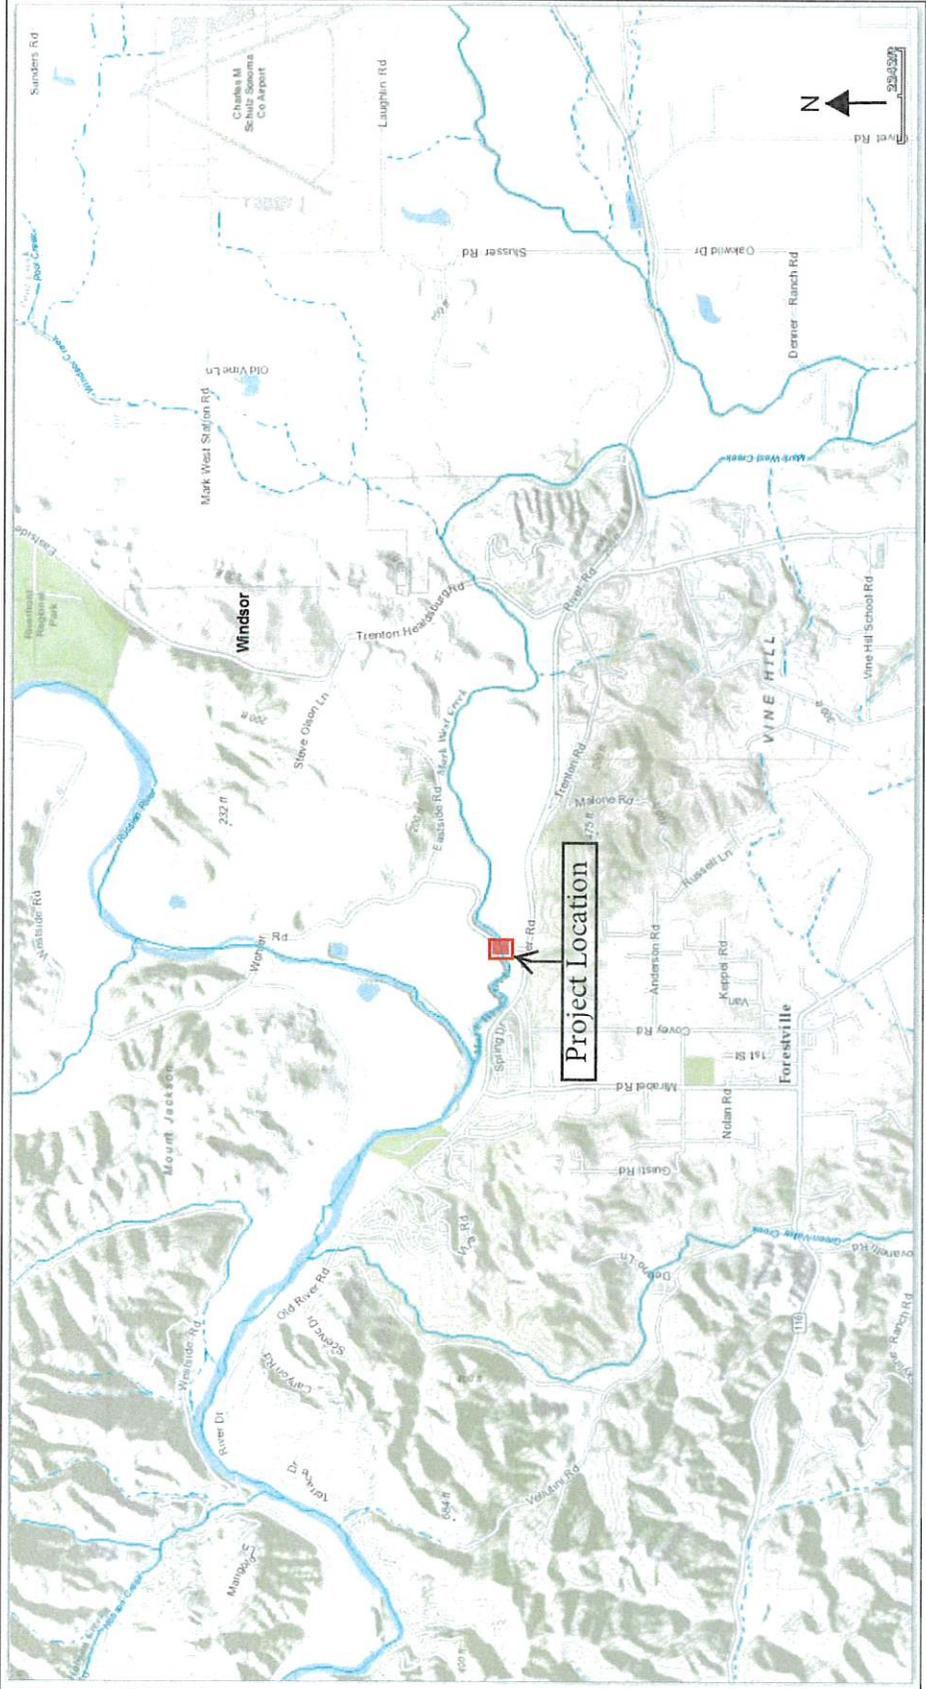

Project Location Map

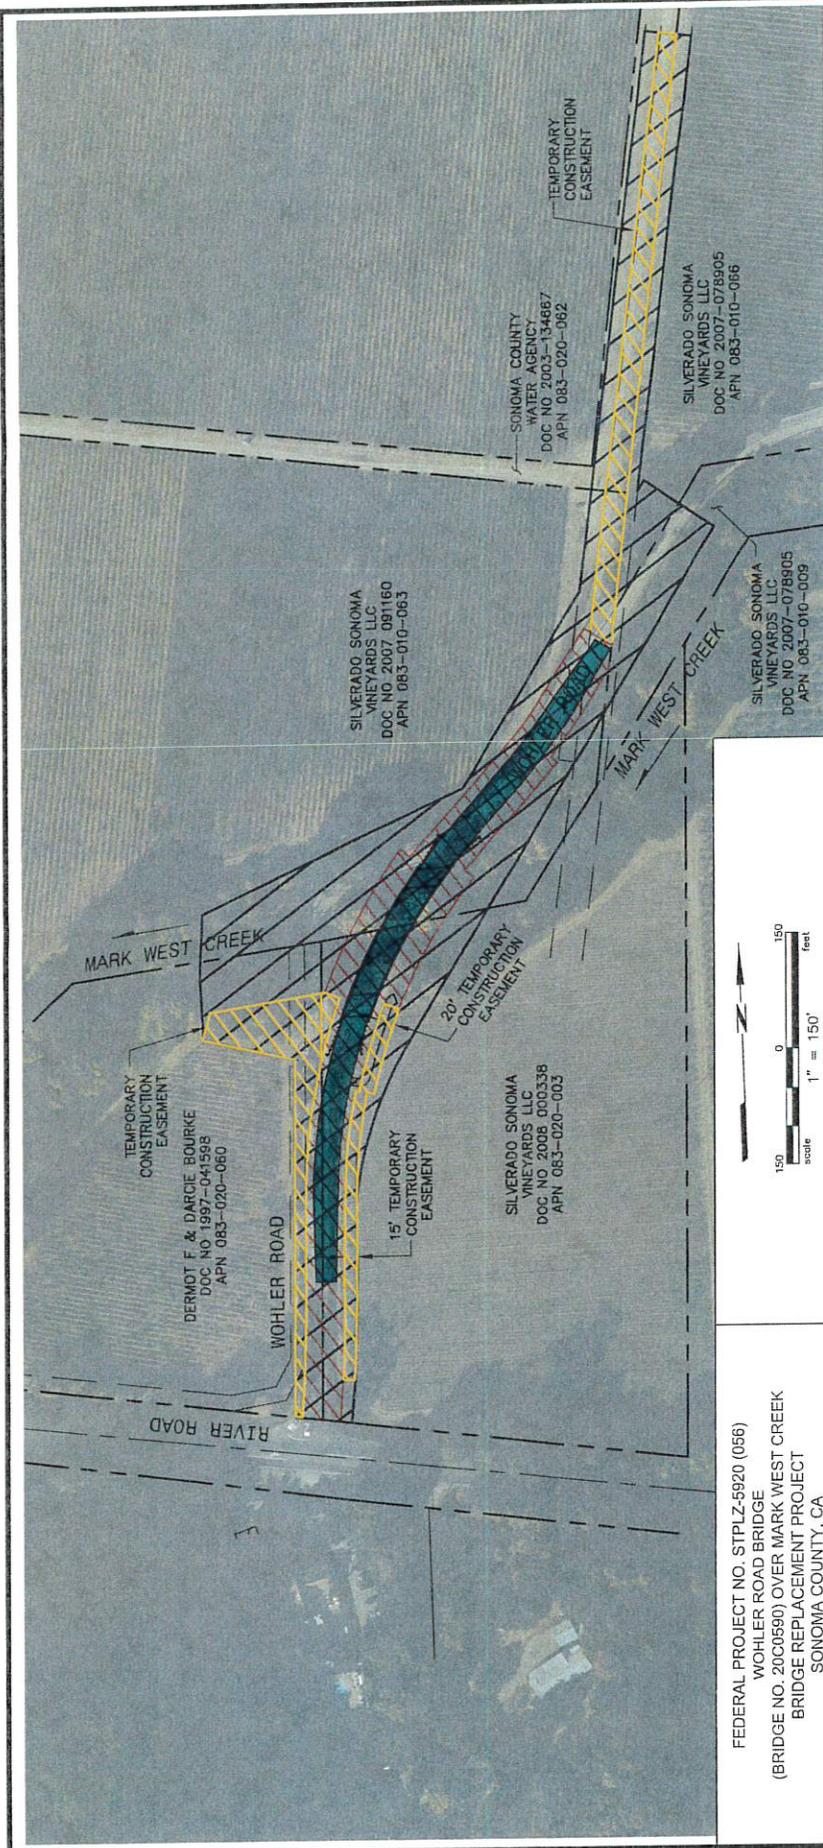

FEDERAL PROJECT NO. STPLZ-5920 (056)
 WOHLER ROAD BRIDGE
 (BRIDGE NO. 20C0590) OVER MARK WEST CREEK
 BRIDGE REPLACEMENT PROJECT
 SONOMA COUNTY, CA

Area of Potential Effects Map


 Local Assistance Project Engineer
 Office of Local Assistance, CALTRANS


 Local Agency Project Engineer
 Sonoma County Department of Transportation and Public Works

Date: 06/09/2017
 Date: June 12, 2017
 Date: 5-3-2017

LEGEND	
	PROPERTY BOUNDARY LINE
	EASEMENT
	ACCESS ROAD
	VINEYARD
	ARCHAEOLOGY AND ARCHITECTURAL HISTORY AREA OF POTENTIAL EFFECTS
	NEW ROAD RIGHT OF WAY
	TEMPORARY CONSTRUCTION EASEMENT
	BRIDGE AND NEW ROAD AREA


INDEX TO PLANS

SHEET No.	DWG No.	TITLE
1	T1	TITLE SHEET
ROAD PLANS		
SHEET No.	DWG No.	TITLE
2	CN-1	CONSTRUCTION NOTES
3	SC-1	SURVEY CONTROL
4	D-1	DEMOLITION PLAN
5	L-1	LAYOUT PLAN
6	L-2	LAYOUT PLAN
7	L-3	LAYOUT PLAN
8	C-1	PLAN AND PROFILE
9	C-2	PLAN AND PROFILE
10	C-3	CONSTRUCTION DETAILS
11	CD-1	EROSION CONTROL PLAN
12	EC-1	EROSION CONTROL PLAN
13	TH-1	TRAFFIC HANDLING PLAN


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BRIDGE PLANS		
SHEET No.	DWG No.	TITLE
14	S1	GENERAL PLAN
15	S2	INDEX TO BRIDGE PLANS
16	S3	DECK CONTOURS
17	S4	FOUNDATION PLAN
18	S5	ABUTMENT 1 LAYOUT
19	S6	ABUTMENT 4 LAYOUT
20	S7	ABUTMENT DETAILS No. 1
21	S8	BENT LAYOUT
22	S9	BENT LAYOUT
23	S10	BENT DETAILS No. 1
24	S11	BENT DETAILS No. 2
25	S12	TYPICAL SECTION No. 1
26	S13	TYPICAL SECTION No. 2
27	S14	SLAB DETAILS No. 1
28	S15	SLAB DETAILS No. 2
29	S16	STRUCTURE APPROACH DRAINAGE DETAILS
30	S17	LOG OF TEST BORINGS No. 1 OF 2
31	S18	LOG OF TEST BORINGS No. 1 OF 2
32	S19	LOG OF TEST BORINGS No. 2 OF 2

COUNTY OF SONOMA
DEPARTMENT OF TRANSPORTATION
AND PUBLIC WORKS
 PROJECT PLANS FOR CONSTRUCTION OF
WOHLER ROAD BRIDGE AT MARK WEST CREEK (REPLACE)
 (EXISTING COUNTY BRIDGE No. 20C-0138)
 (NEW COUNTY BRIDGE No. 20C-058D)
 FEDERAL PROJECT No. STPLZ-6820(059)

FROM P.M. 10:11 TO P.M. 10:14
 NET LENGTH
 0.17 MILES

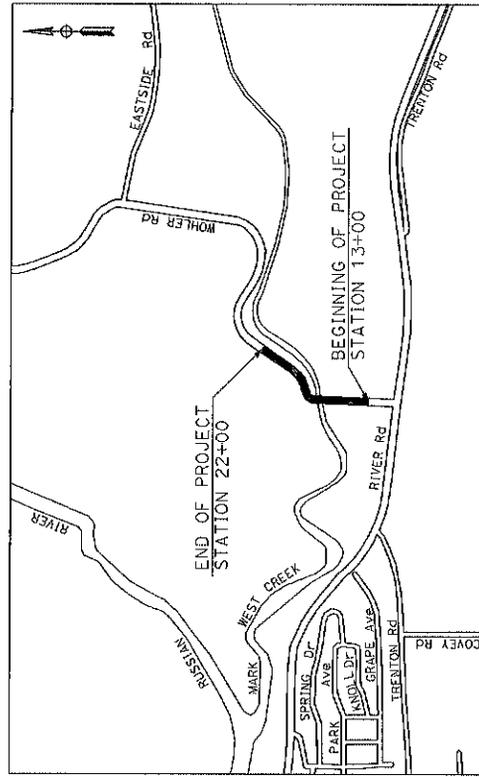

VICINITY MAP
 NO SCALE

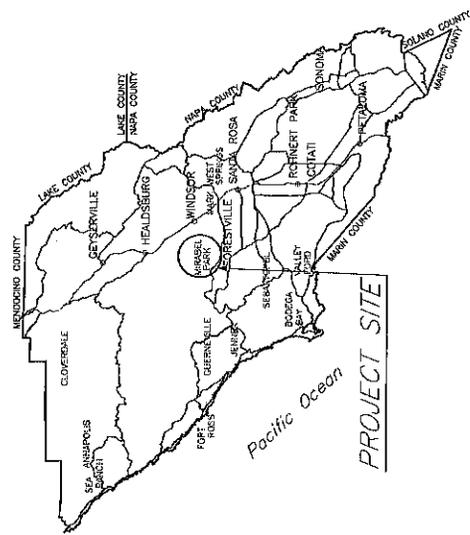

VERTICAL DATUM
 NAVD 88

BASIS OF BEARINGS:
 CALIFORNIA COORDINATE SYSTEM OF 1983, ZONE 11 (BASED ON CALIFORNIA SURVEYING AND DRAFTING VERN, BASED ON CSFC CORP POSITIONS, EPOCH 2011.001). DISTANCE AND STATIONING ARE GROUND DISTANCES. MULTIPLY BY 0.99996312 TO OBTAIN GRID DISTANCES.

RIGHT OF WAY DETERMINATION:
 FOR ROAD RIGHT OF WAY DETERMINATION, SEE RECORD OF SURVEY RECORDED IN BOOK XX OF MAPS AT PAGE XX.

NOTES:
 THE CONTRACTOR SHALL POSSESS CLASS A LICENSE AND HAZARDOUS SUBSTANCE REMOVAL CERTIFICATION AT THE TIME OF AWARD.

APPROVED FOR CONSTRUCTION:

JOHANNES J. HOVERTZ, P.E., DIRECTOR
 DEPARTMENT OF TRANSPORTATION AND PUBLIC WORKS
 R.C.E. 07489

OLESA TRIMBAIT, P.E., DEPUTY DIRECTOR
 R.C.E. 70846

SAMUEL BALMAGARDER, SENIOR CIVIL ENGINEER, P.E. DATE
 R.C.E. 01230

PLAN CHECK SET/NOT FOR CONSTRUCTION (5/4/18)


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DRAWING BY	SM4	AS BUILT MODIFICATION TO AS COMPLETED AFTER CONSTRUCTION	 COUNTY OF SONOMA DEPARTMENT OF TRANSPORTATION AND PUBLIC WORKS JOSHUA KLASSEN, P.E. DIRECTOR	1718	171
CHECKED BY	JWA	DATE		FISCAL YEAR	SHEET NUMBER
		DATE	2018	1	2

BER
 BIGGS CARDOBA
 STRUCTURAL ENGINEERS
 1000 10th St, Suite 200
 Ukiah, CA 95501
 Tel: 707-461-0070
 Fax: 707-461-0070

BENCHMARK AND DATUM			
MONUMENT	COORDINATES		
	EASTING	NORTHING	CONVERSION/COMMENT
1	1944443.28	6306608.59	54.47 MAG. MAG. IN ADJ. AT THE INTERSECTION OF WHEELER ROAD AND TRICE ROAD
2	1944711.04	6306603.32	74.52 MAG. MAG. IN ADJ. AT THE INTERSECTION OF WHEELER ROAD AND TRICE ROAD
3	1945000.14	6306575.47	58.37 MAG. MAG. IN ADJ. AT THE INTERSECTION OF WHEELER ROAD
4	1945227.48	6306577.84	61.52 MAG. MAG. IN ADJ. AT THE INTERSECTION OF WHEELER ROAD
5	1945557.21	6306581.32	59.24 MAG. MAG. IN ADJ. AT THE INTERSECTION OF WHEELER ROAD

BASIS OF BEARINGS:

CALIFORNIA COORDINATE SYSTEM OF 1983, ZONE II BASED ON CALIFORNIA SUBSTANTIAL AND DRAFTING VNM, BASED ON CSRS COORDINATES, EPOCH 2011.000. DISTANCE AND BEARING ARE GROUND DISTANCES. MULTIPLY BY 0.99983212 TO OBTAIN GRID DISTANCES.

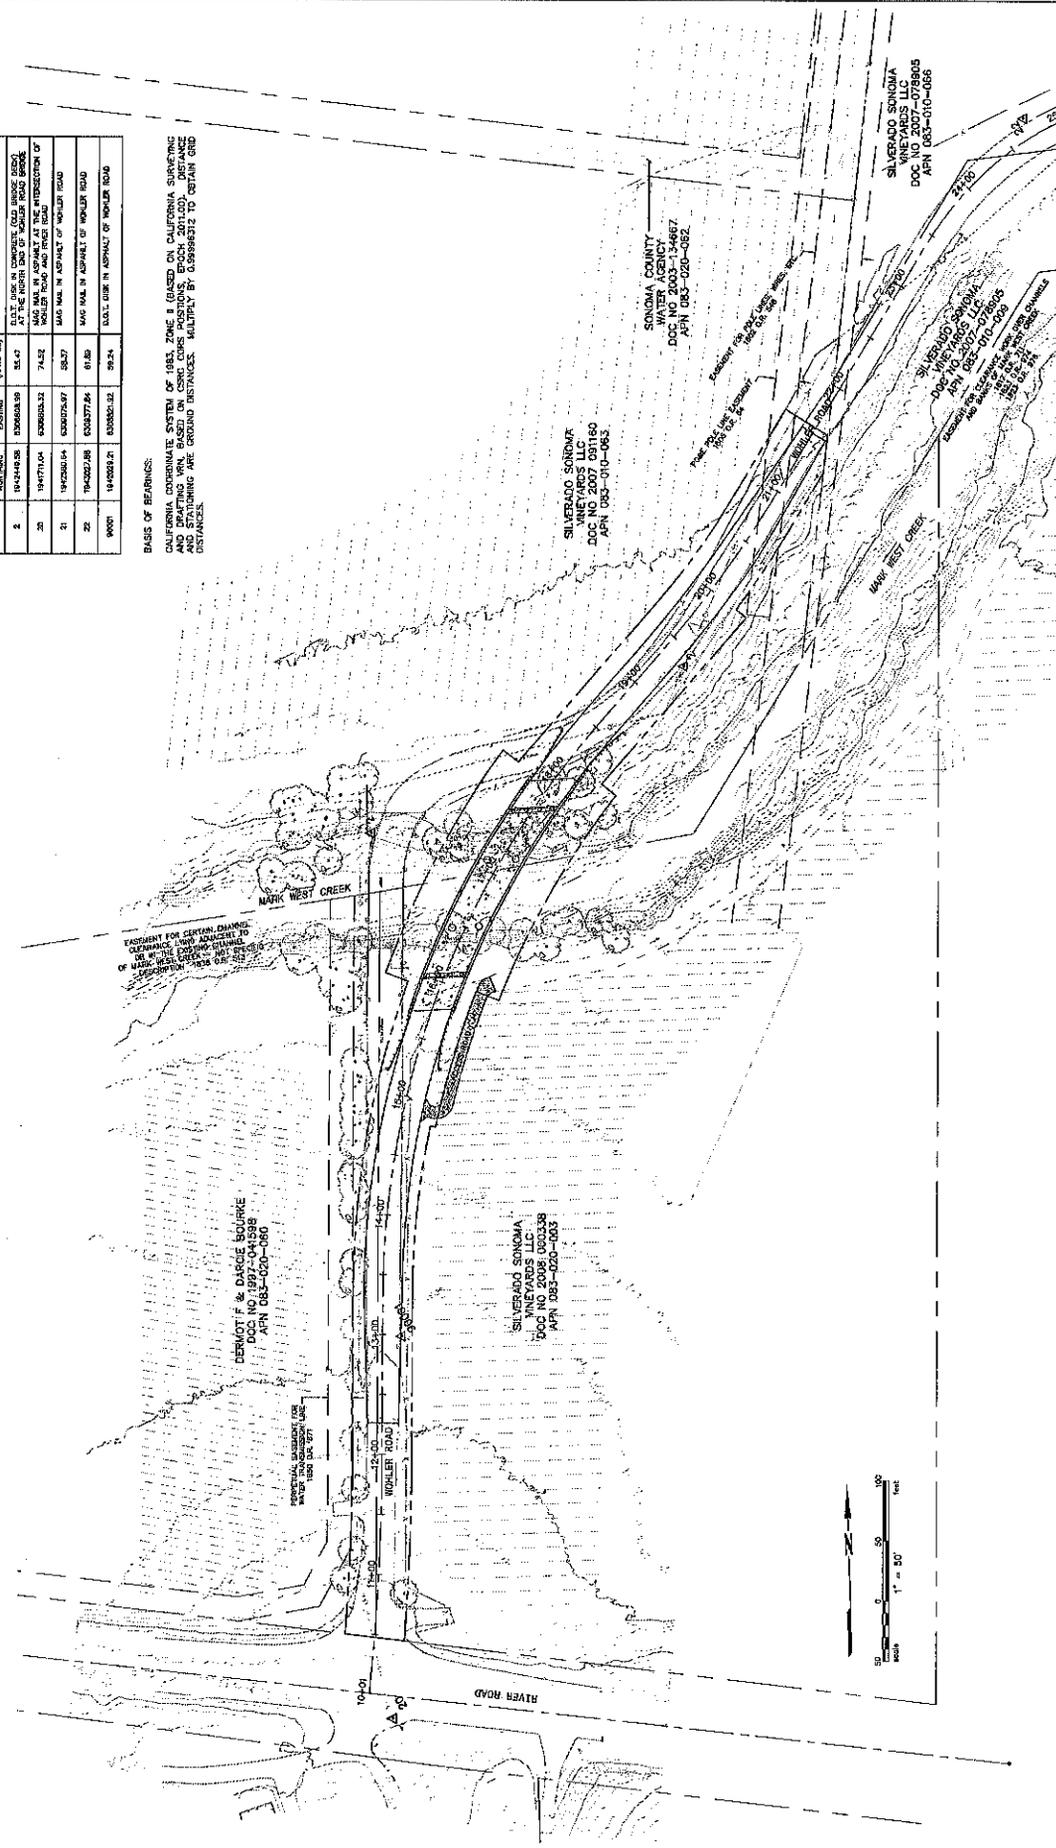

EASEMENT FOR CERTAIN CHANGES IN ELEVATION AND BEARING TO BE MADE TO THE BRIDGE STRUCTURE OF MARK WEST CREEK AS SHOWN ON THESE PLANS. SEE SHEET 083-010-063.

DERMOTT & DARCE BOURKE
REGISTERED PROFESSIONAL ENGINEER
NO. 44888
APR 083-020-080

SILVERADO SONOMA
VINEYARDS LLC
DOC NO 2008 090338
APR 083-020-085

SILVERADO SONOMA
WATER AGENCY
DOC NO 2003-134667
APR 083-020-082




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DRAWING BY	BR	DATE	5/6/18	DATE	5/6/18	DATE	5/6/18	DATE	5/6/18
CHECKED BY	GRH	DATE	5/6/18	DATE	5/6/18	DATE	5/6/18	DATE	5/6/18

PRELIMINARY
REGISTERED PROFESSIONAL ENGINEER
DATE: 05/04/2018
SIGNED: [Signature]
IN: SONOMA COUNTY, CALIFORNIA


BKF
BER

SURVEY CONTROL
WOHLER ROAD BRIDGE
AT MARK WEST CREEK REPLACEMENT

FORM NUMBER: 800-0040
PROJECT NUMBER: 000000
FISCAL YEAR: 2018
SHEET NUMBER: 3
TOTAL SHEETS: 32

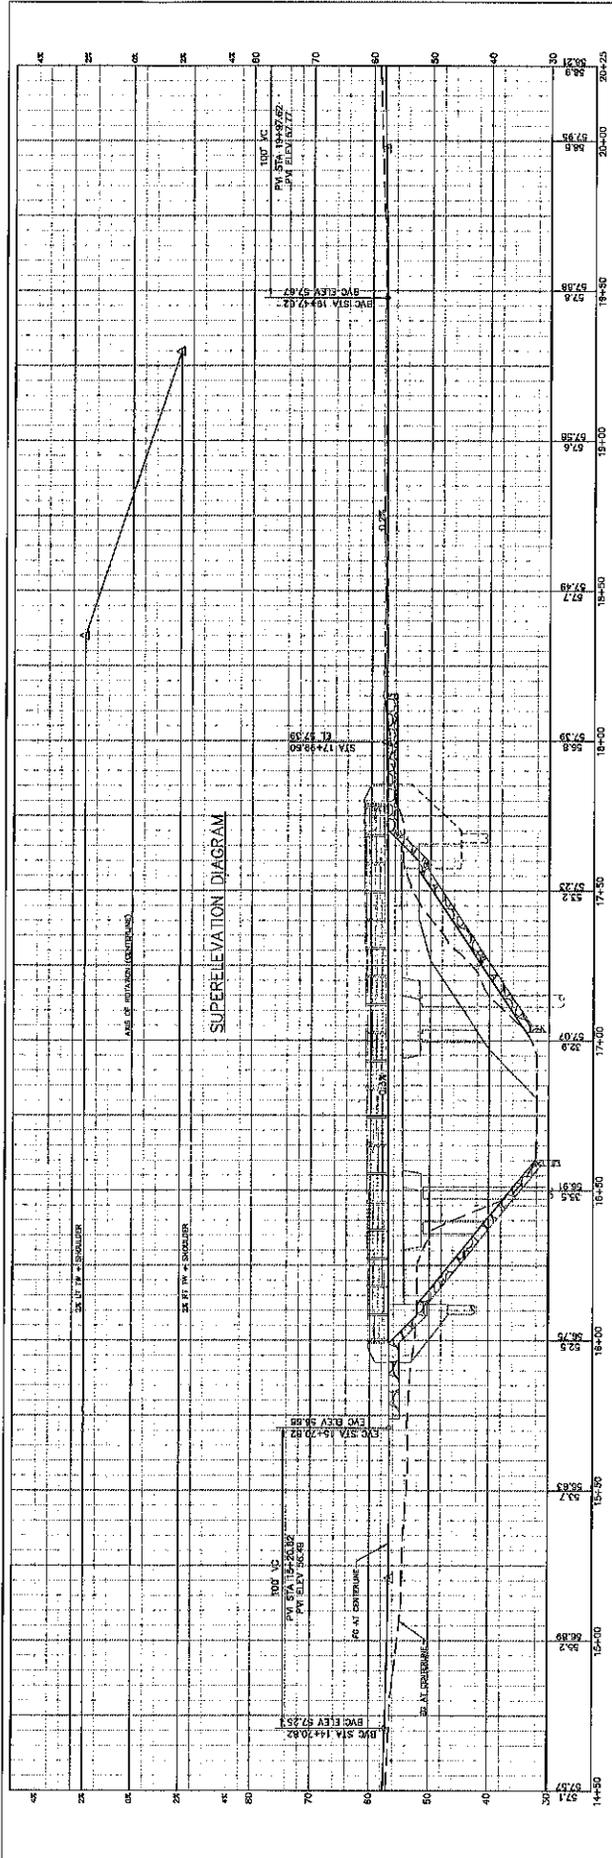

WOHLER ROAD CENTERLINE PROFILE
 H: 1"=20'
 V: 1"=10'

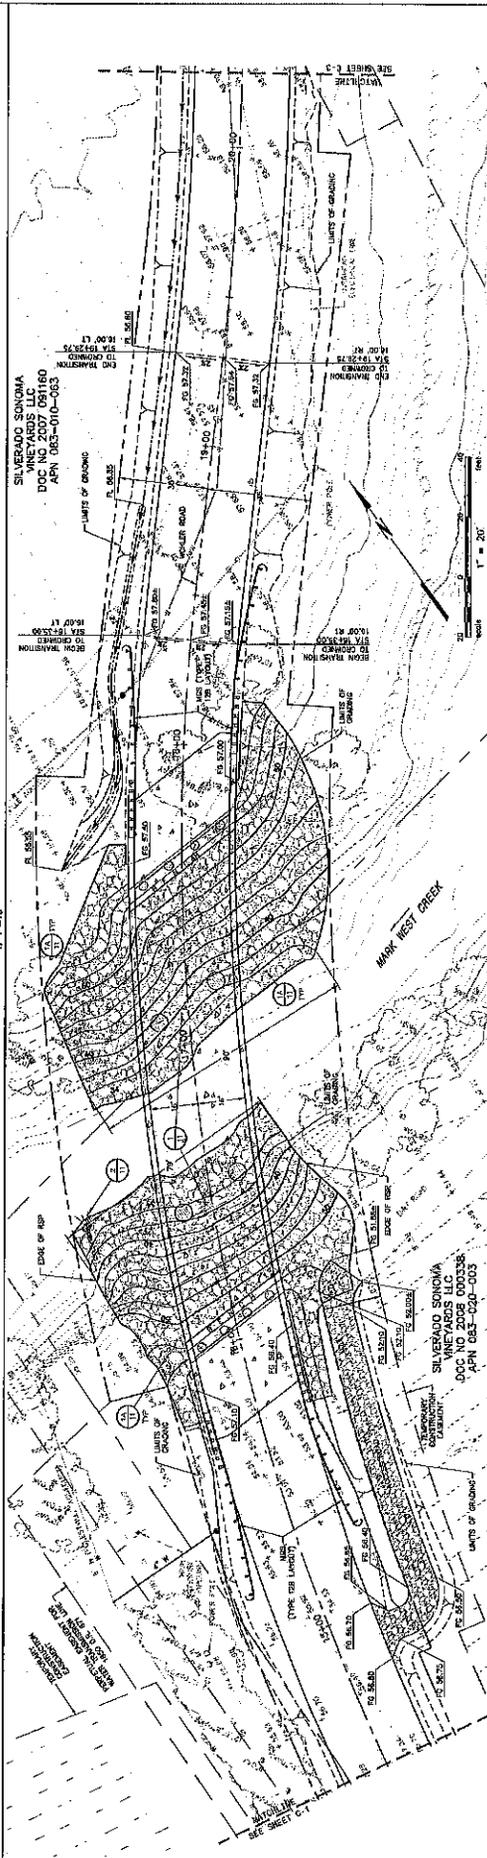


DESIGN BY	JAK	ROAD MARKET	200-080
DRAWING BY	SKL	BUDGET NUMBER	07135
CHECKED BY	GNH	TOTAL PAGES	9
		SHEET NUMBER	9
		TOTAL SHEETS	22


PRELIMINARY REGISTERED PROFESSIONAL ENGINEER DATE: 05/04/2018 PROJECT: WOHLEH ROAD BRIDGE REPLACEMENT AT MARK WEST CREEK		COUNTY OF SONOMA DEPARTMENT OF TRANSPORTATION PUBLIC WORKS SHERIFF: KENNETH P. H. WILSON	BKT BER
CONSTRUCTION COMPLETED: RESIDENT ENGINEER: [Signature] AS BUILT DRAWING BY: [Signature]			

PROJECT NUMBER: 200 DATE: 1/27/18 50% SUBMITTAL 5/24/18 85% SUBMITTAL	COUNTY OF SONOMA PROJECT NO. 200 DATE: 1/27/18 50% SUBMITTAL 5/24/18 85% SUBMITTAL
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ROAD MARKET: 200-080 BUDGET NUMBER: 07135 TOTAL PAGES: 9 SHEET NUMBER: 9 TOTAL SHEETS: 22	PLANNING AND PROFILE WOHLER ROAD BRIDGE REPLACEMENT AT MARK WEST CREEK
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WOHLER ROAD CENTERLINE PROFILE
 H: 1"=20'
 V: 1"=10'

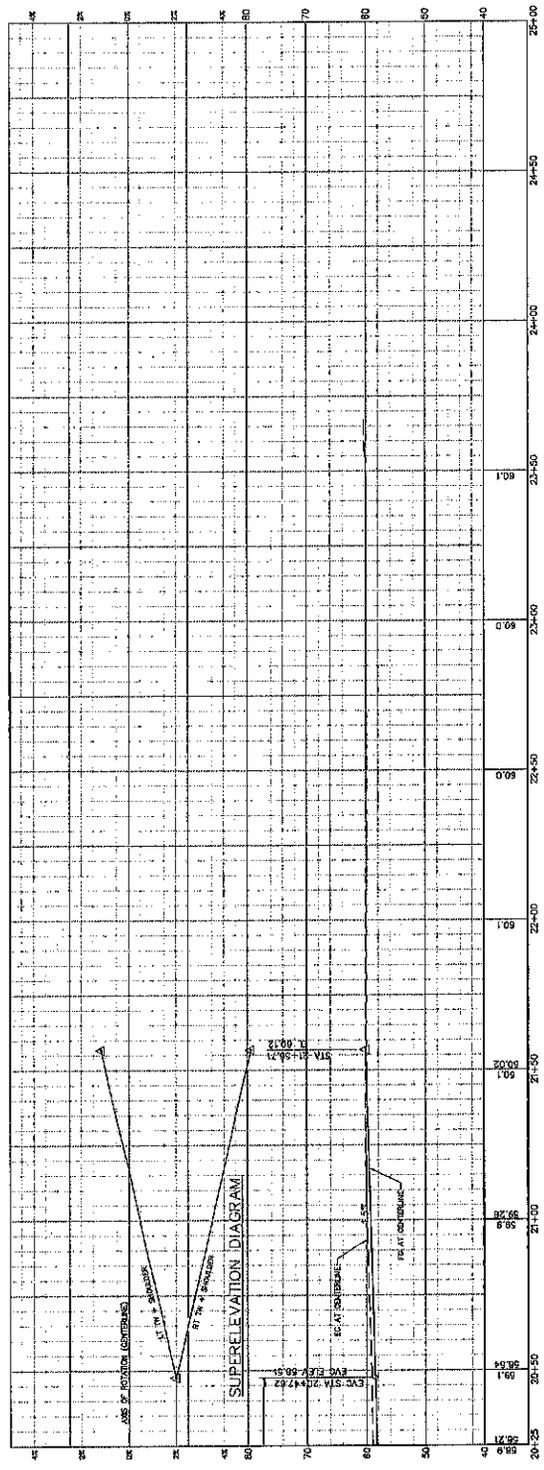

DESIGN BY	JAK	CONSTRUCTION COMPLETED	AS BEST APPROXIMATION TO BE COMPLETED WITH CONSTRUCTION	DATE	4/27/15	DATE SUBMITTAL	5/22/15	DATE SUBMITTAL	5/22/15
DRAWING BY	DEL	DESIGNED BY	DEL	APPROVED BY	DEL	APPROVED BY	DEL	APPROVED BY	DEL
CHECKED BY	GRH	CHECKED BY	GRH	CHECKED BY	GRH	CHECKED BY	GRH	CHECKED BY	GRH
PRELIMINARY REVISIONS FOR CONSTRUCTION 05/04/2018 K. SANDY (360) 536-1300 FAX (360) 536-5444 P. SANDY (360) 536-1300 FAX (360) 536-5444		COUNTY OF SONOMA DEPARTMENT OF PUBLIC WORKS BRUNNEN & ALANSON P.E. REGISTERED		BKF BER		200 SOUTH BAY STREET, SUITE 300 SAN RAFAEL, CA 94903 TEL: (415) 452-3300 BRUNNEN & ALANSON ASSOCIATES INC. 1000 W. 10TH AVENUE, SUITE 1000 DENVER, CO 80202 TEL: (303) 733-8800 FAX: (303) 733-8801		ROAD NUMBER: 200-088 SHEET NUMBER: 001130 PROJECT YEAR: 10 SHEET NUMBER: 10 TOTAL SHEETS: 33	
SILVERADO SONOMA VINEYARDS LLC DOC NO 2007-078805 APN 083-010-088 SILVERADO SONOMA VINEYARDS LLC DOC NO 2007-078905 APN 083-010-009 PROJECT TITLE: WOHLER ROAD BRIDGE AT MARK WEST CREEK REPLACEMENT									

EROSION PREVENTION AND SEDIMENT CONTROL NOTES


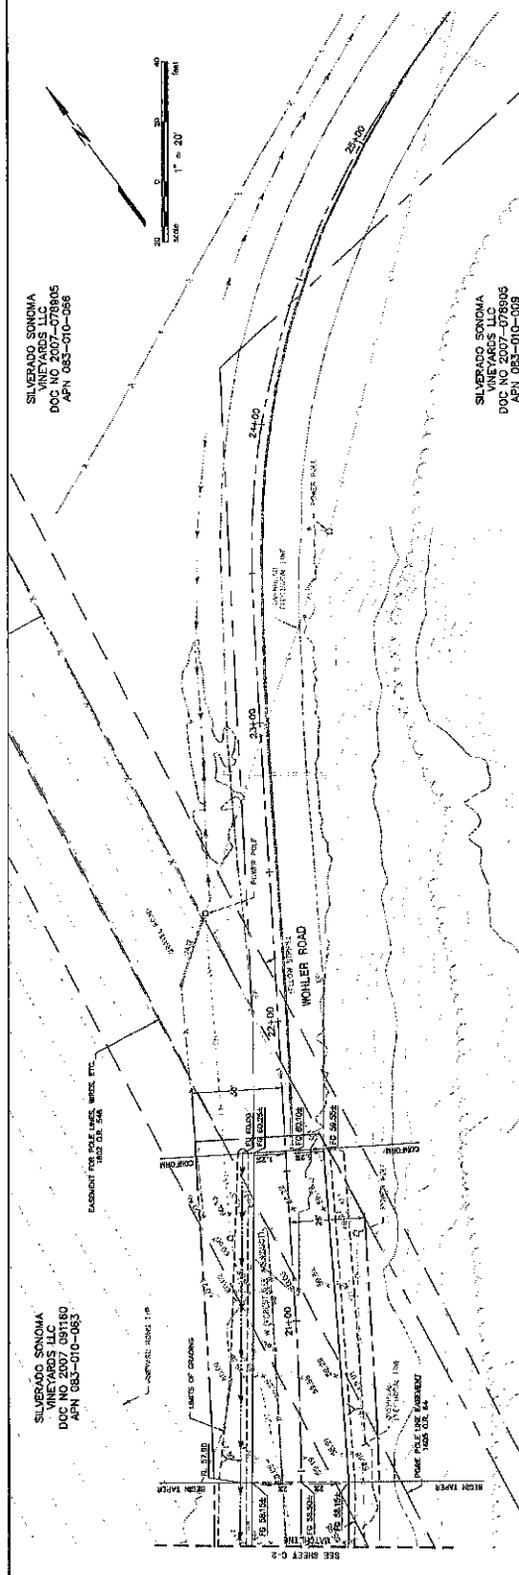
1. PERFORM EROSION PREVENTION AND SEDIMENT CONTROL IN ACCORDANCE WITH THE SONOMA COUNTY CODE, CHAPTER 22.1, ARTICLE 10, AND THE CALIFORNIA WATER QUALITY CONTROL REGULATIONS, AND SECTION 20 OF THE CALTRANS STANDARD SPECIFICATIONS.
2. THE APPROVED PLANS SHALL CONFORM WITH THE EROSION PREVENTION AND SEDIMENT CONTROL MANUAL, AND THE LATEST EDITIONS OF THE FOLLOWING PUBLICATIONS OR AN EQUIVALENT BEST MANAGEMENT PRACTICE:
 - EROSION AND SEDIMENT CONTROL FIELD MANUAL BY THE SAN FRANCISCO BAY REGIONAL WATER QUALITY CONTROL BOARD.
 - CONSTRUCTION EROSION PREVENTION AND SEDIMENT CONTROL MANUAL BY THE ASSOCIATION OF WEST AREA SUPERVISORS.
 - CONSTRUCTION SITE BEST MANAGEMENT PRACTICES MANUAL BY THE CALIFORNIA SUSTAINABLE QUALITY ASSOCIATION.
3. IF DISCREPANCIES OCCUR BETWEEN THESE NOTES, MATERIAL SPECIFICATIONS, AND THE CONTRACTOR'S RECOMMENDATIONS, THEN THE MOST PROTECTIVE SHALL APPLY.

4. THE OWNER IS RESPONSIBLE FOR OBTAINING AND COMPLYING WITH ALL NECESSARY PERMITS AND REGULATIONS FOR EROSION PREVENTION AND SEDIMENT CONTROL. THE SONOMA COUNTY CODE, CHAPTER 22.1, ARTICLE 10, AND THE CALIFORNIA WATER QUALITY CONTROL REGULATIONS, AND SECTION 20 OF THE CALTRANS STANDARD SPECIFICATIONS, APPLY TO THIS PROJECT.
5. PRESERVATION OF EXISTING VEGETATION SHALL OCCUR TO THE MAXIMUM EXTENT PRACTICABLE.
6. THE OWNER IS RESPONSIBLE FOR PREVENTING STORED WATER FROM GENERATING POLLUTANTS IN EXCESSIVE QUANTITIES OF EROSION PREVENTION AND SEDIMENT CONTROL ON ALL DISTURBED AREAS YEAR ROUND.
7. EROSION PREVENTION AND SEDIMENT CONTROL MEASURES SHALL BE MAINTAINED THROUGHOUT THE CONSTRUCTION PERIOD AND AFTER ACTUAL STORM EVENTS TO ENSURE MEASURES ARE FUNCTIONING PROPERLY. STORM EVENTS OCCURRING AT LEAST PREVIOUS TO THE COMMENCEMENT OF CONSTRUCTION SHALL BE MAINTAINED THROUGHOUT THE CONSTRUCTION PERIOD.
8. CHANGES TO THE EROSION PREVENTION AND SEDIMENT CONTROL PLAN MAY BE MADE TO RETURN TO FIELD CONDITIONS. CHANGES SHALL BE NOTED ON THE PLAN SHEET.
9. DRAINAGE OF EXISTING AND NEW CONSTRUCTION AREAS SHALL BE MAINTAINED THROUGHOUT THE CONSTRUCTION PERIOD TO THE MAXIMUM EXTENT PRACTICABLE. POTENTIAL POLLUTANTS INCLUDE BUT ARE NOT LIMITED TO: FERTILIZERS, PESTICIDES, PAINTS, OILS, GREASES, AND OTHER HAZARDOUS MATERIALS. CONCRETE CURING, PAINT, STAINS, GLUES, WOOD PRODUCTS, RESTROOMS, RESTROOMS, AND EQUIPMENT WASH WATER AND CHALKMOUNTED WATER.
10. ENTRANCES TO THE CONSTRUCTION SITE SHALL BE MAINTAINED IN A CONDITION THAT WILL PREVENT TRACKING OR FLOODING OF POLLUTANTS ON PAVED AREAS WITHIN THE COUNTY RIGHT-OF-WAY. SUCH AS DRIVEWAYS AND DRIVEWAYS SHALL BE PROPERLY WASHED UP AT THE END OF EACH WORKING DAY ON THESE PROPERTIES AS NECESSARY.
11. PROPER CLOSURE SHALL BE MAINTAINED THROUGHOUT THE EROSION PREVENTION AND SEDIMENT CONTROL PERIOD TO PREVENT POLLUTANTS AS ESTABLISHING THE OBSERVATION CORNER, INTERSECTIONS, STORM DRAIN, BOTTLING, PLASTIC DIVERTERS, BLANKETS OR MATS.
12. WHETHER IT IS NOT POSSIBLE TO UTILIZE EROSION PREVENTION AND SEDIMENT CONTROL MEASURES, SUCH AS FIBER ROLLS AND SILT FENCES, FIBER ROLL DIVERTERS, SUCH AS FIBER ROLLS AND SILT FENCES, FIBER ROLL DIVERTERS, SHALL BE REDESIGNED AND VERIFIED INTO THE SOIL APPROPRIATELY AT 2 TO 3 FEET FROM THE TOP OF SLOPE.

APPLICATION RATE (POUNDS PER ACRE)

SEED MIX	40
BROOK MILLIS (BLANDY BONE)	20
FERTILIZER (15-15-15) (HYDROLYZED)	500
18-20-0 5 1/2% SULPHUR	4000
MIXED GRAIN STRAW	75-100
HYDROLYZED FERTILIZER	PER MANUFACTURER
EQUIVALENT MATERIAL	PER MANUFACTURER

13. HYDROSEEDING SHALL BE COMPLETED IN A THREE STEP PROCESS. STEP ONE SHALL BE THE APPLICATION OF SEED MIX OVER THE SLOPE. SECOND, STABILIZE MULCH OVER THE SEED AND FERTILIZER. THIRD, STABILIZE THE MULCH IN PLACE. APPLICATIONS SHALL BE BROADCAST MANUALLY OR MANUALLY AT THE RATE OF 100 LBS PER ACRE. MULCH SHALL BE APPLIED AS BLENDED STRAW SHALL BE DERIVED FROM WHEAT, RICE OR BARLEY OR EQUIVALENT. MULCH SHALL BE APPLIED TO THE ENTIRE SLOPE OR EQUIVALENTLY BY CHIPPING OR PUNCHING THE MULCH INTO THE SLOPE. MULCH SHALL BE APPLIED TO THE ENTIRE SLOPE OR EQUIVALENTLY BY CHIPPING OR PUNCHING THE MULCH INTO THE SLOPE. MULCH SHALL BE APPLIED TO THE ENTIRE SLOPE OR EQUIVALENTLY BY CHIPPING OR PUNCHING THE MULCH INTO THE SLOPE.
14. THE OWNER SHALL PROTECT STORM DRAIN INLETS FROM POTENTIAL POLLUTANTS UNTIL DRAINAGE COVERAGE SYSTEMS ARE FUNCTIONAL AND CONSTRUCTION HAS BEEN COMPLETED.
15. ENERGY DISSIPATORS SHALL BE INSTALLED AT STORM DRAIN OUTLETS WHICH MAY CARRY STORM WATER FROM LEADING TO SOIL EROSION.
16. SOIL AND MATERIAL STOCKPILES SHALL BE PROPERLY PROTECTED TO PREVENT EROSION AND POLLUTANT TRANSPORT FROM THE CONSTRUCTION SITE.
17. SOLID WASTE, SUCH AS TRASH, DISCARDED BUILDING MATERIALS AND DEBRIS, SHALL BE PLACED IN DESIGNATED COLLECTION AREAS AND NOT ALLOWED TO ACCUMULATE ON THE CONSTRUCTION SITE. SOLID WASTE SHALL BE REMOVED DAILY OR AS NECESSARY, AND REGULAR REMOVAL AND PROPER DISPOSAL SHALL BE ARRANGED.
18. A CONCRETE WORKOUT AREA, SUCH AS A TEMPORARY PIT, SHALL BE DESIGNED TO CLEAN CONCRETE MIXERS AND TRUCKS AT THE END OF EACH WORKING DAY. CONCRETE MIXERS AND TRUCKS SHALL BE WASHED IN THIS AREA DAILY OR AS NECESSARY, AND REGULAR REMOVAL AND PROPER DISPOSAL SHALL BE ARRANGED.
19. PROPER APPLICATION, CLEANING AND STORAGE OF POTENTIALLY HAZARDOUS MATERIALS, SUCH AS PAINTS AND CHEMICALS, SHALL BE CONDUCTED TO PREVENT THE ESCAPE OF POLLUTANTS.
20. WHEN UTILIZED, TEMPORARY SEDIMENT AND SANITARY FACILITIES SHALL BE MAINTAINED AND MAINTAINED TO PREVENT THE ESCAPE OF POLLUTANTS.
21. APPROPRIATE VEHICLE STORAGE, FUELING, MAINTENANCE AND CLEANING AREAS SHALL BE DESIGNATED AND MAINTAINED TO PREVENT DISCHARGE OF POLLUTANTS.

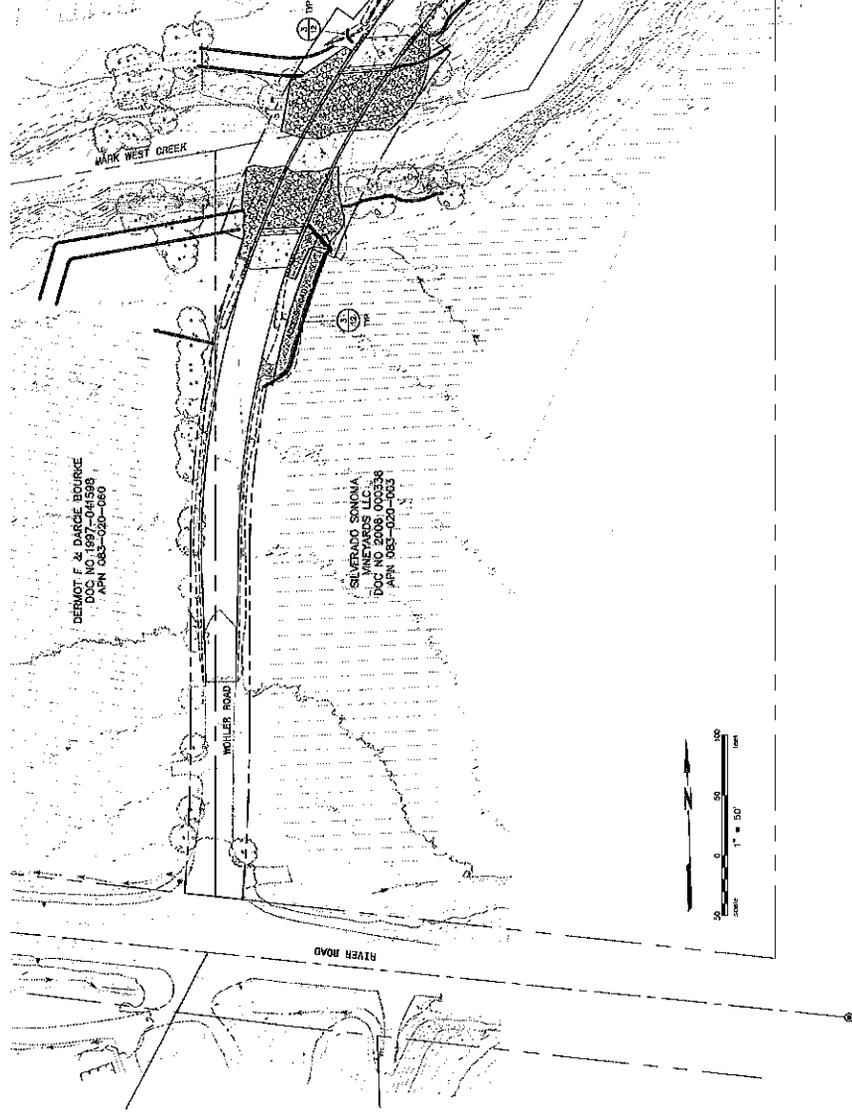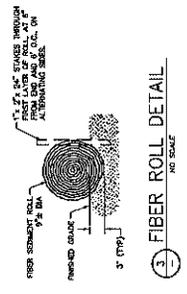


<p>PRELIMINARY REGISTERED PROFESSIONAL ENGINEER DATE: 05/04/2018 BY: K. J. JONES</p>	<p>CONSTRUCTION COMPLETED: AS BUILT DRAWINGS BY: [Signature] DATE: 5/22/18 DATE SUBMITTED: 5/22/18</p>	<p>NO. OF SHEETS: 20 SHEET NO.: 001 SHEET TOTAL: 20</p>
<p>DESIGN BY: JJK DRAWING BY: RRL CHECKED BY: GRH</p>	<p>AS BUILT INFORMATION IS BE COMPLETED WITH CONSTRUCTION</p>	<p>NO. OF SHEETS: 20 SHEET NO.: 001 SHEET TOTAL: 20</p>
<p>PROJECT: WOLLER ROAD BRIDGE AT MARK WEST CREEK REPLACEMENT</p>	<p>DATE: 5/22/18</p>	<p>NO. OF SHEETS: 20 SHEET NO.: 001 SHEET TOTAL: 20</p>
<p>PROJECT: WOLLER ROAD BRIDGE AT MARK WEST CREEK REPLACEMENT</p>	<p>DATE: 5/22/18</p>	<p>NO. OF SHEETS: 20 SHEET NO.: 001 SHEET TOTAL: 20</p>
<p>PROJECT: WOLLER ROAD BRIDGE AT MARK WEST CREEK REPLACEMENT</p>	<p>DATE: 5/22/18</p>	<p>NO. OF SHEETS: 20 SHEET NO.: 001 SHEET TOTAL: 20</p>
<p>PROJECT: WOLLER ROAD BRIDGE AT MARK WEST CREEK REPLACEMENT</p>	<p>DATE: 5/22/18</p>	<p>NO. OF SHEETS: 20 SHEET NO.: 001 SHEET TOTAL: 20</p>


FOR ACCURATE RIGHT OF WAY AND ACCESS DATA, SEE "ROADWAY PLANS"

SVC 14770.82
Elev 51.181X
100.00' VC
R/C = 2.31X/574

PROFILE GRADE
NO SCALE

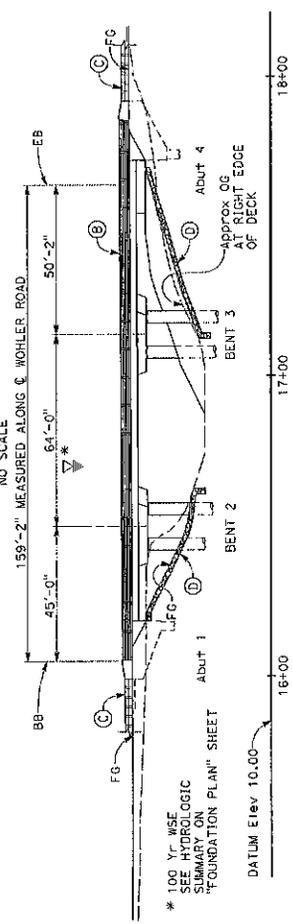

ELEVATION
1" = 20'

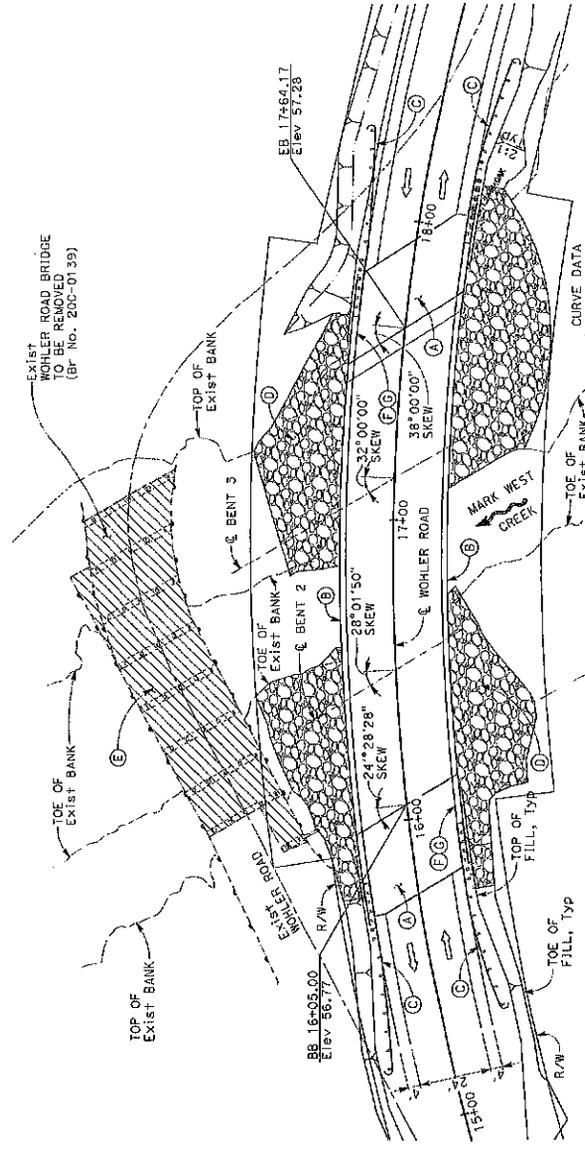

NOTE:
THE CONTRACTOR MUST VERIFY ALL CONTROLLING FIELD DIMENSIONS BEFORE ORDERING OR FABRICATING ANY MATERIAL


DESIGN BY	SEN	REGISTERED STRUCTURAL ENGINEER	DATE	3/4/2018
DRAWING BY	RLG	REGISTERED ENGINEER	DATE	3/4/2018
CHECKED BY	JAA	REGISTERED ENGINEER	DATE	3/4/2018

BIGGS CARDOSO ASSOCIATES, INC.
STRUCTURAL ENGINEERS
1000 N. GARDNER ST. SUITE 200
MESA, AZ 85201
PH: 480-987-0000
WWW.BIGGS-CARDOSO.COM



COUNTY OF SONOMA
DEPARTMENT OF TRANSPORTATION & PUBLIC WORKS
SUSAN A. KLASSEY, P.E. DIRECTOR

INDEX NUMBER	000
BUDGET NUMBER	0000
FISCAL YEAR	18
SHEET NUMBER	13
TOTAL SHEETS	28

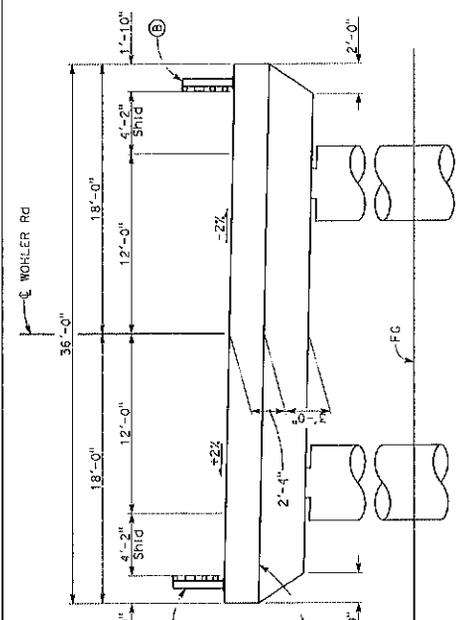

TYPICAL SECTION
1/4" = 1'-0"

- LEGEND:**
- ZZZZZ Indicates Bridge Removal
 - Indicates Existing Structure
 - Indicates Traffic Direction
 - Indicates Direction of Creek Flow

- NOTES:**
- (A) Approach Slab Type N (30S) (Mod)
 - (B) Railing Type ST-40 (Mod)
 - (C) Midwest Guard Rail (MGS), see "Roadway Plans"
 - (D) Rock Slope Protection, see "Roadway Plans"
 - (E) Remove Existing Bridge, Bridge No. 20C-0139
 - (F) Paint "WOHLER ROAD BRIDGE AT MARK WEST CREEK"
 - (G) Paint "BRIDGE No. 20C-0590"
1. For Index to Bridge Plans and General Notes, see "INDEX TO BRIDGE PLANS" envelope.
2. For Bench Mark and Datum, File Data Table and Hydrologic Summary, see "FOUNDATION PLAN".
3. See "Roadway Plans" for grading.

PLAN CHECK SET/NOT FOR CONSTRUCTION (5/4/18)

GENERAL PLAN
WOHLER ROAD BRIDGE
AT MARK WEST CREEK REPLACEMENT

INDEX TO BRIDGE PLANS

DRAWING No.	TITLE
S1	GENERAL PLAN
S2	INDEX TO BRIDGE PLANS
S3	DECK CONTOURS
S4	FOUNDATION PLAN
S5	ABUTMENT 1 LAYOUT
S6	ABUTMENT 2 LAYOUT
S7	ABUTMENT DETAILS No. 1
S8	ABUTMENT DETAILS No. 2
S9	BENT LAYOUT
S10	BENT DETAILS No. 1
S11	BENT DETAILS No. 2
S12	TYPICAL SECTION No. 1
S13	TYPICAL SECTION No. 2
S14	SLAB DETAILS No. 1
S15	SLAB DETAILS No. 2
S16	STRUCTURE APPROACH DRAINAGE DETAILS
S17	LOG OF TEST BORINGS No. 1 OF 2
S18	LOG OF TEST BORINGS No. 2 OF 2

LOAD & RESISTANCE FACTOR DESIGN


DESIGN: AASHTO LRFD Bridge Design Specifications, 6th Edition and Caltrans Amendments, preface dated Nov. 2014
 SEISMIC DESIGN: Caltrans Seismic Design Criteria (SDC) Version 1.7 dated April 2013
 DEAD LOAD: Includes 30 psf for future wearing surface and 95 plf for future utility allowance
 LIVE LOAD: HL93 with Low-Boys and permit design load
 CONCRETE: $f_c = 60,000$ psi
 $f_y = 60,000$ psi at 28 days (except as shown on "DECK CONTOURS" sheet)
 $n = 8$

CONSTRUCTION STAGING NOTES:

The existing bridge is subject to regular overtopping by flood waters, and it is anticipated that the project site may be flooded more than once during the construction period. Because of this, the contractor shall be required to protect the approach embankments and the partially constructed bridge structure during the wet season.
 Season 1 Construction:
 1. At a minimum, construction of the following items must be completed:
 a. Approach Embankments
 b. CIDH Pile construction
 c. Bent Columns
 2. If either or both of the abutments are to be constructed in Season 1, the following elements of the abutment(s) must be completed, if it is not feasible to complete each of these elements of the abutment(s) being constructed, the abutment(s) should not be started in Season 1, and should instead be carried through in Season 2.
 a. Abutment Diaphragm
 b. Abutment Backwall
 c. Abutment Wingwalls
 d. Abutment Wingwalls
 e. Any exposed bridge rebar, bolts or other steel elements that are not galvanized must be painted thoroughly with 2 coats of AASHTO M300 Type 1 inorganic zinc rich primer.
 2. Benches cut in creek banks for construction cranes, as well as any access paths to benches, must be re-graded and protected from flood waters per the Road Plans, the Project Permits, and the Project Special Provisions.
 3. Embankment fill must be paved over with a temporary layer of AC - see Roadway Plans and Project Special Provisions for requirements.

2015 STANDARD PLANS

A3A	ABBREVIATIONS (SHEET 1 OF 3)
A3B	ABBREVIATIONS (SHEET 2 OF 3)
A3C	ABBREVIATIONS (SHEET 3 OF 3)
A10A	LEGEND - LINES AND SYMBOLS (SHEET 1 OF 5)
A10B	LEGEND - LINES AND SYMBOLS (SHEET 2 OF 5)
A10C	LEGEND - LINES AND SYMBOLS (SHEET 3 OF 5)
A10D	LEGEND - LINES AND SYMBOLS (SHEET 4 OF 5)
A10E	LEGEND - LINES AND SYMBOLS (SHEET 5 OF 5)
A10F	LEGEND - SOIL (SHEET 1 OF 2)
A10G	LEGEND - SOIL (SHEET 2 OF 2)
A10H	LEGEND - ROCK
A62C	LIMITS OF PAYMENT FOR EXCAVATION AND BACKFILL - BRIDGE
B0-1	BRIDGE DETAILS
B0-3	BRIDGE DETAILS
B0-5	BRIDGE DETAILS
B0-13	BRIDGE DETAILS
B0-21	JOINT SEALS (MAXIMUM MOVEMENT RATING = 2")
B0-26	JOINT SEALS (MAXIMUM MOVEMENT RATING = 2")
RSP B11-26	CALIFORNIA ST-40 BRIDGE RAIL (SHEET 1 OF 2)
RSP B11-27	CALIFORNIA ST-40 BRIDGE RAIL (SHEET 2 OF 2)

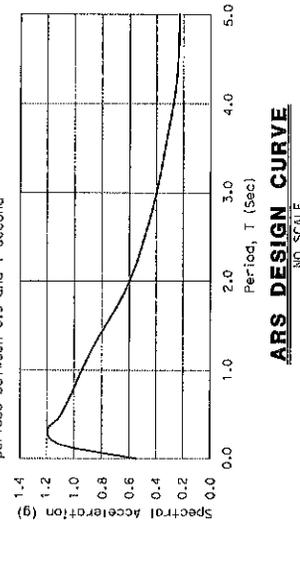

ABBREVIATIONS:

- EQ EQUAL
- WSE WATER SURFACE ELEVATION

LEGEND:

- BT-10 Indicates Caltrans Standard Plan sheet No.
- U-1 Indicates Detail No.
- A Indicates Section No.
- S Indicates sheet No. shown on
- 1 Indicates Detail No.
- 35 Indicates sheet No. shown on

DESIGN BY: SEN	CONSTRUCTION COMPLETED	BRUCE GARDNER ASSOCIATES, INC. STRUCTURAL ENGINEERS	INDEX TO BRIDGE PLANS	BRIDGE NUMBER: 1000
DRAWING BY: SWH	DESIGNED BY: AS NILL, J. BRUNNEN, J. B. APPROVED	DATE: 10/27/13	WOHLER ROAD BRIDGE	BUDGET NUMBER: 041135
CHECKED BY: JAA	DATE: 10/27/13	DATE: 10/27/13	AT MARK WEST CREEK REPLACEMENT	FISCAL YEAR: 14
				SHEET NUMBER: 14
				TOTAL SHEETS: 26

NO SCALE


ARS DESIGN CURVE

COUNTY OF SONOMA
 DEPARTMENT OF PUBLIC WORKS
 STAFF ENGINEER: J. BRUNNEN

BER


PLAN CHECK SET/NOT FOR CONSTRUCTION (5/4/18)

- NOTES:
- Barrier and approach slab not shown for clarity
 - See "TYPICAL WINGWALL ELEVATION" on "ABUTMENT DETAILS No. 1" sheet for wingwall details.
 - See "PILE DATA TABLE" on "FOUNDATION PLAN" sheet for pile out-off elevation, estimated top of rock socket, and specified tip elevation.
 - No splices allowed in No. Splice Zone for main CIDH pile reinforcement. Splices in main CIDH pile reinforcement outside of the No. Splice Zone must utilize staggered ultimate butt splices.

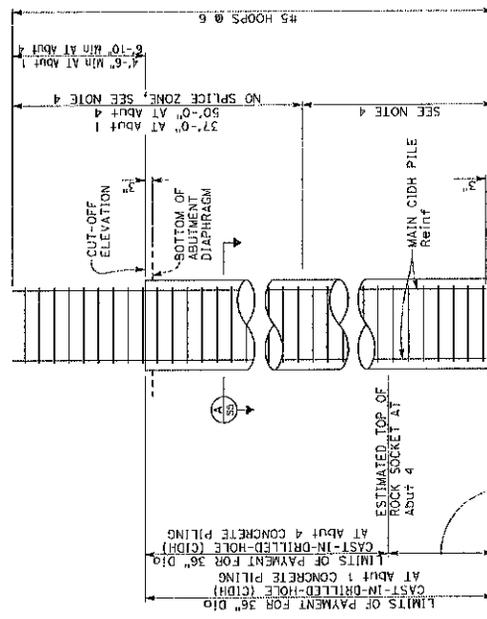


NOTE: Pile hoops must utilize ultimate butt splices only.


ABUTMENT PILE ELEVATION
1/2" = 1'-0"

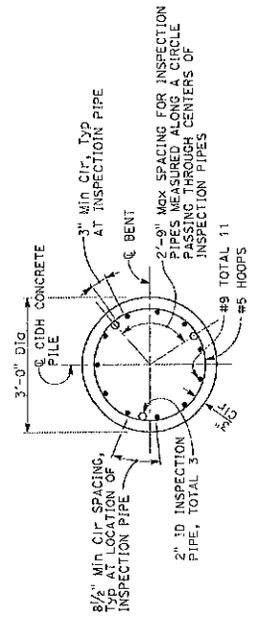


SECTION A
3/4" = 1'-0"
S5

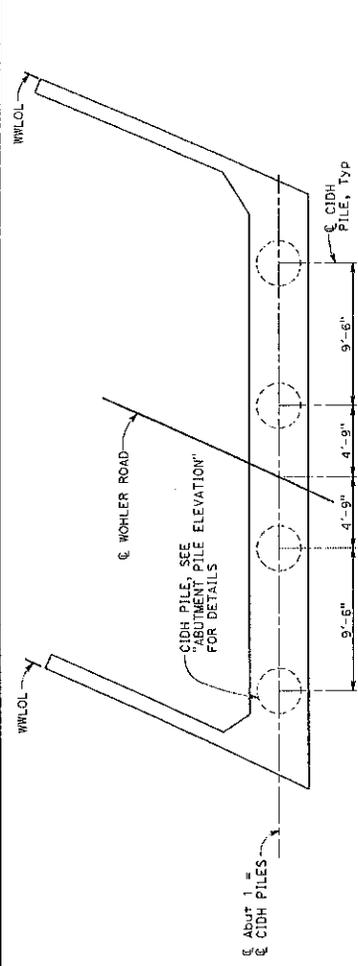

ABUTMENT 1 PILE LAYOUT
1/4" = 1'-0"

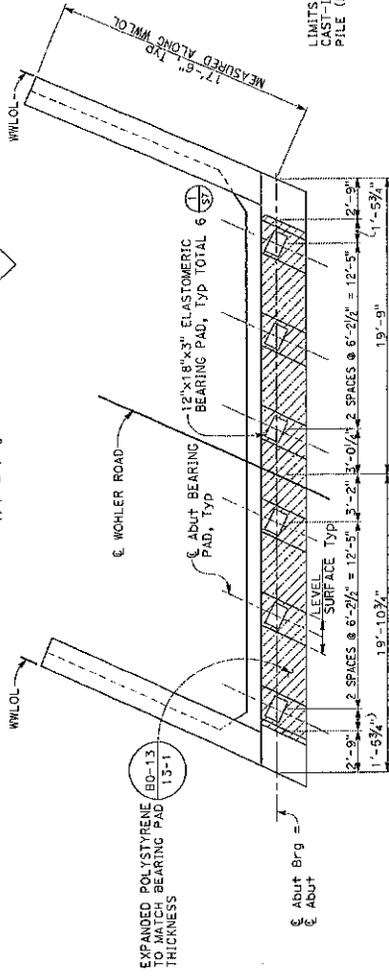


ABUTMENT 1 PLAN
1/4" = 1'-0"

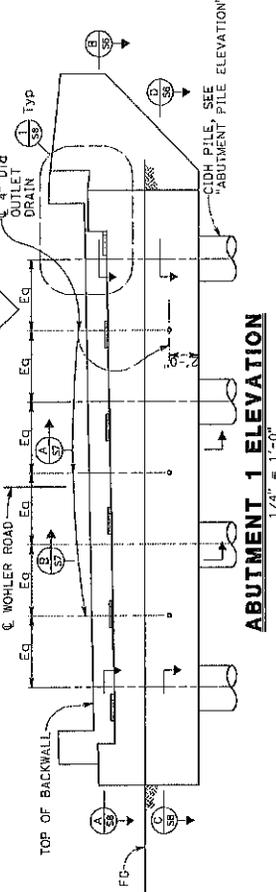


ABUTMENT 1 ELEVATION
1/4" = 1'-0"

PLAN CHECK SET/NOT FOR CONSTRUCTION (5/4/18)


DESIGN BY	SKH	REGISTERED STRUCTURAL ENGINEER	DATE	5/12/18	PROJECT NO.	18-00000000
DRAWING BY	SKH	REGISTERED STRUCTURAL ENGINEER	DATE	5/12/18	SHEET NUMBER	17
CHECKED BY	JMA	REGISTERED STRUCTURAL ENGINEER	DATE	5/12/18	TOTAL SHEETS	32
CONTRACTOR		BIGGS BARBERA ASSOCIATES, INC.		COUNTY OF SONOMA		
RESIDENT ENGINEER		BIGGS BARBERA ASSOCIATES, INC.		WOHLER ROAD BRIDGE		
PLANS APPROVAL DATE		5/12/18		AT MARK WEST CREEK REPLACEMENT		
DATE		5/12/18		SUSAN K. KLASSEN, P.E., DIRECTOR		
PROJECT NO.		18-00000000		FISCAL YEAR		
SHEET NUMBER		17		PROJECT NUMBER		
TOTAL SHEETS		32		REVISION NUMBER		

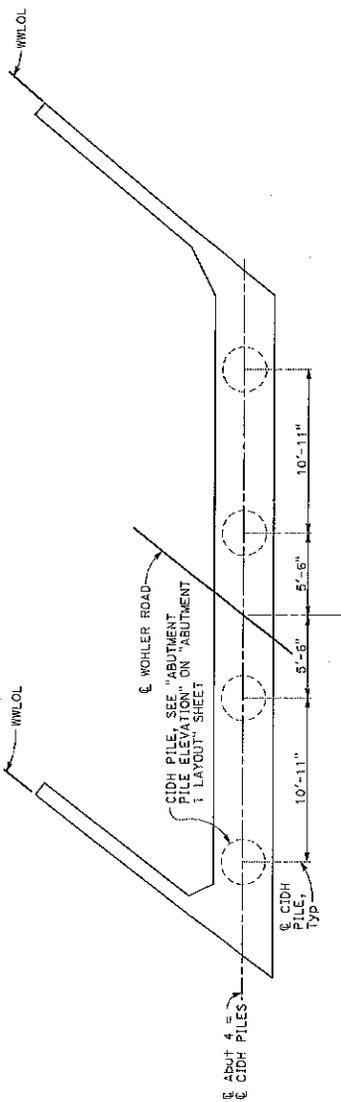

ABUTMENT 4 PILE LAYOUT
1/4" = 1'-0"

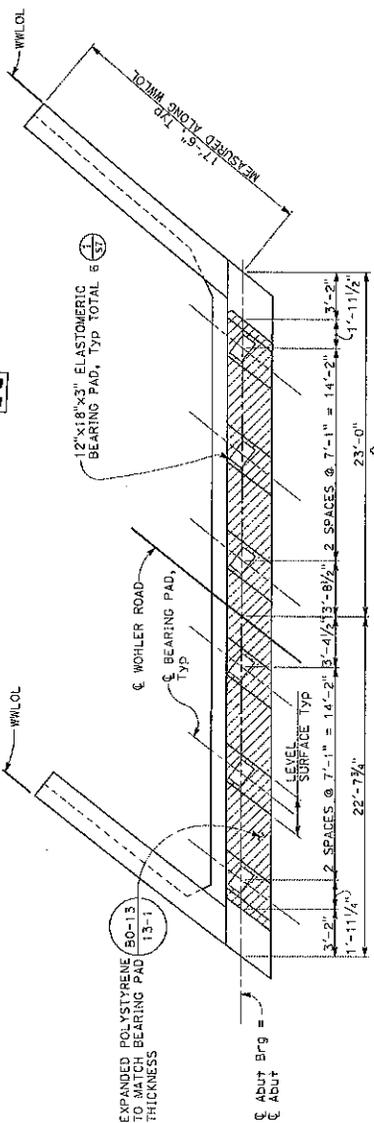


ABUTMENT 4 PLAN
1/4" = 1'-0"

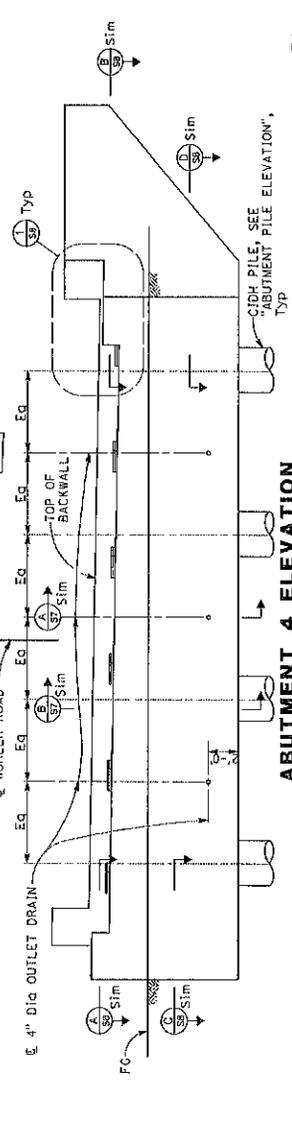


ABUTMENT 4 ELEVATION
1/4" = 1'-0"

- NOTES:**
- Barrier and approach slab not shown for clarity
 - See "TYPICAL WINDOW ELEVATION" on "ABUTMENT DETAILS No. 1" sheet for window details.
 - For "ABUTMENT PILE ELEVATION", see "ABUTMENT 1 LAYOUT" sheet.

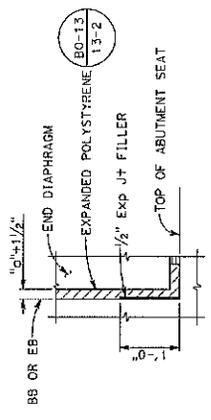

NOTE: See (B6-2) for dimension "d".

DETAIL 1
NO SCALE

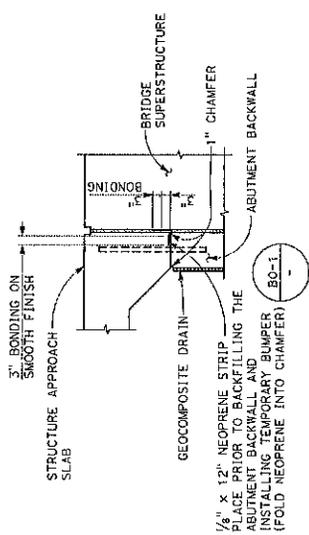

JOINT PROTECTION DETAIL 2
NO SCALE

PLAN CHECK SET/NOT FOR CONSTRUCTION (5/4/18)


DESIGN BY	SEM	REGISTERED STRUCTURAL ENGINEER	CONSTRUCTION COMPLETED	BIDDER NUMBER	1030
DRAWING BY	SNH	AS BUILT INFORMATION TO BE COMPLETED AFTER CONSTRUCTION	RESIDENT ENGINEER	BUDGET NUMBER	COLLIER
CHECKED BY	JAA	DATE	APPROVED	FISCAL YEAR	18 20
		DATE	DATE	SHEET NUMBER	18 20
		DATE	DATE	TOTAL SHEETS	22
		DATE	DATE		



COUNTY OF SONOMA
DEPARTMENT OF TRANSPORTATION, PLANNING AND CONSTRUCTION

BORG
BERNARDSON & ORGANO ASSOCIATES, INC.
STRUCTURAL ENGINEERS

ABUTMENT 4 LAYOUT
WOHLER ROAD BRIDGE
AT MARK WEST CREEK REPLACEMENT

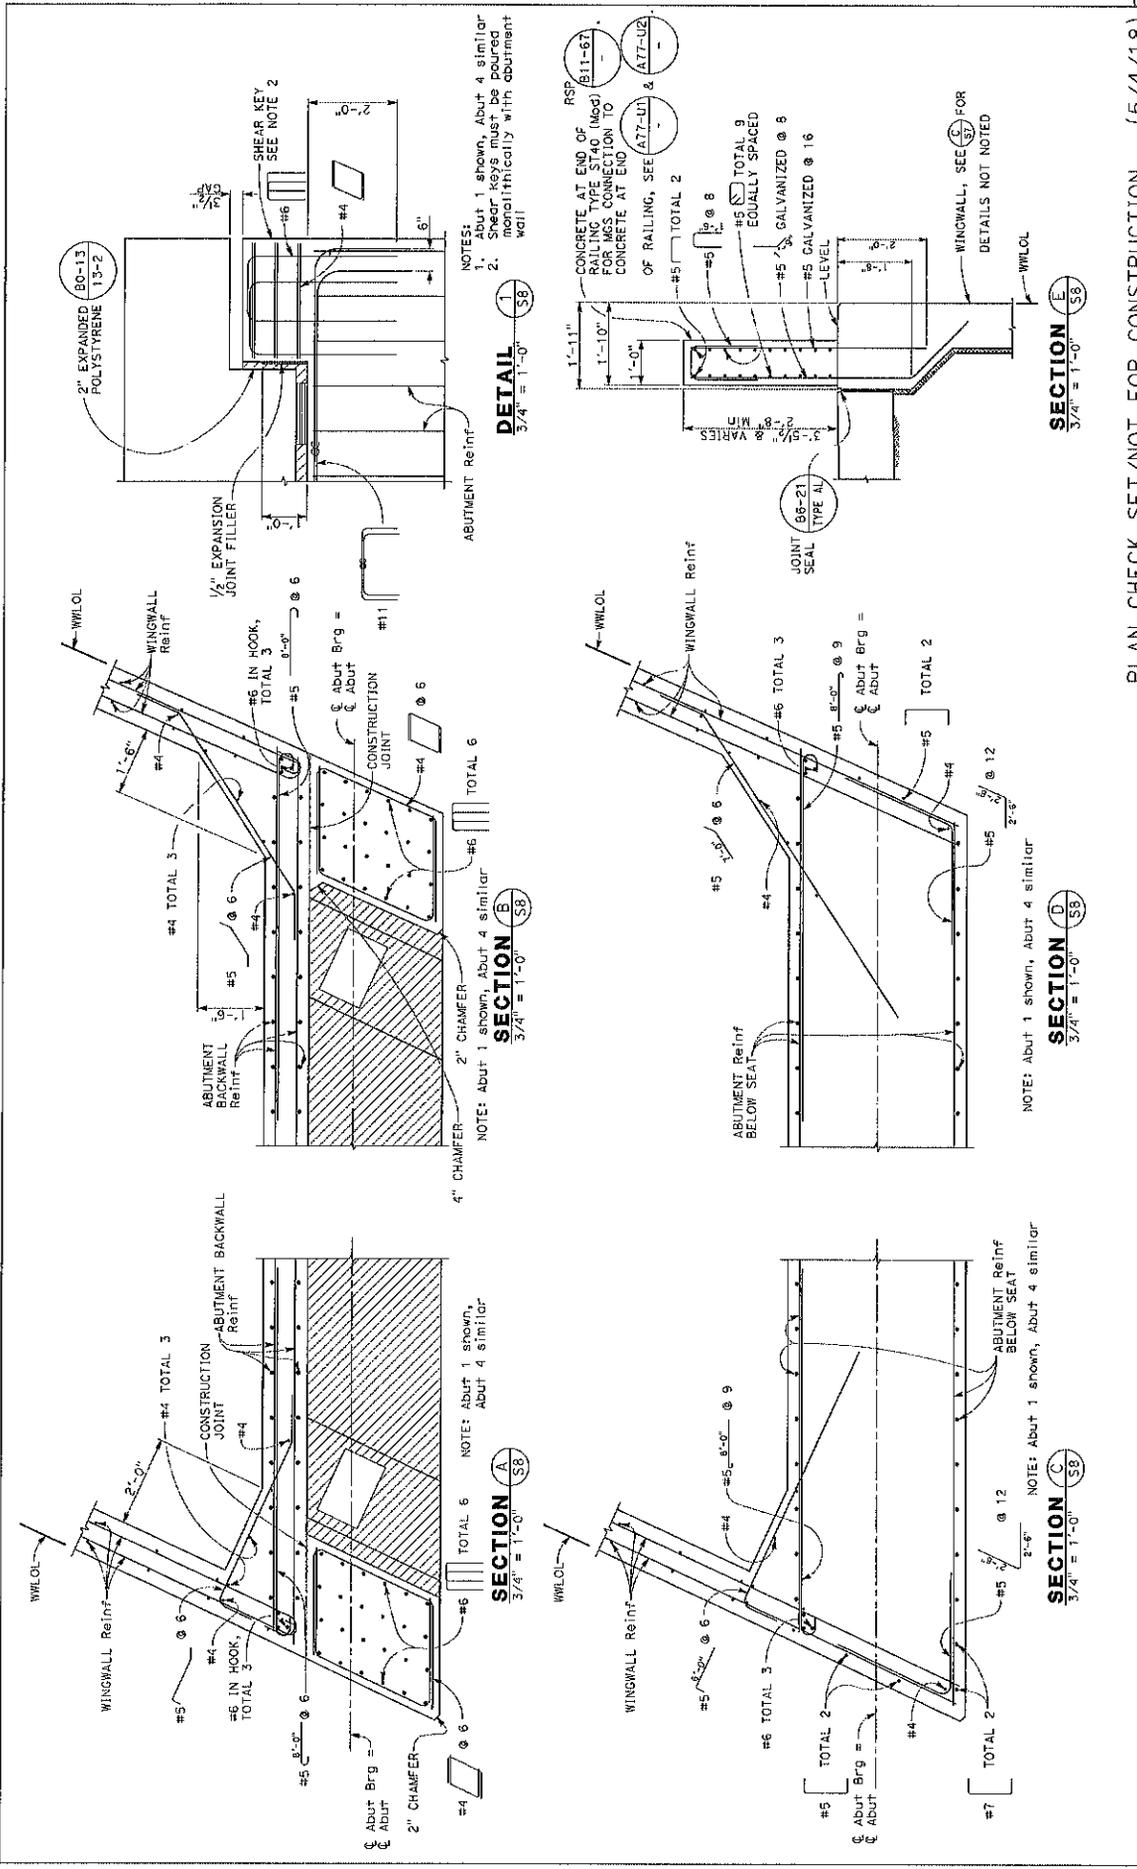

NOTES:
 1. Abut 1 shown, Abut 4 similar
 2. Shear keys must be poured and identically with abutment wall

DETAIL
 3/4" = 1'-0" S8

SECTION B
 3/4" = 1'-0" S8

SECTION A
 3/4" = 1'-0" S8

SECTION C
 3/4" = 1'-0" S8

SECTION D
 3/4" = 1'-0" S8

SECTION E
 3/4" = 1'-0" S8

PLAN CHECK SET/NOT FOR CONSTRUCTION (5/4/18)


DESIGN BY	SDH	REGISTERED STRUCTURAL ENGINEER	CONSTRUCTION COMPLETED	RESIDENT ENGINEER	APPROVED	RESIDENT NUMBER	COLLINS
DRAWING BY	SMH	DATE	DATE	DATE	DATE	FISCAL YEAR	COLLINS
CHECKED BY	JMA	DATE	DATE	DATE	DATE	SHEET NUMBER	50
		DATE	DATE	DATE	DATE	TOTAL SHEETS	52



COUNTY OF SONOMA
 REGISTERED PROFESSIONAL ENGINEERS
 SONOMA, CALIFORNIA, U.S.A.


BIGGS GARDNER ASSOCIATES INC
 STRUCTURAL ENGINEERS
 1000 S. THE ALPINE ROAD
 SUITE 200, WILSONVILLE, OREGON 97150

REGISTERED PROFESSIONAL ENGINEER
 DATE 5/4/18
 DATE 5/4/18
 DATE 5/4/18

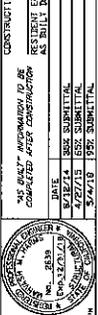




REGISTERED STRUCTURAL ENGINEER
 DATE 5/4/18
 DATE 5/4/18
 DATE 5/4/18

ABUTMENT DETAILS No. 2
WOHLER ROAD BRIDGE
 AT MARK WEST CREEK REPLACEMENT

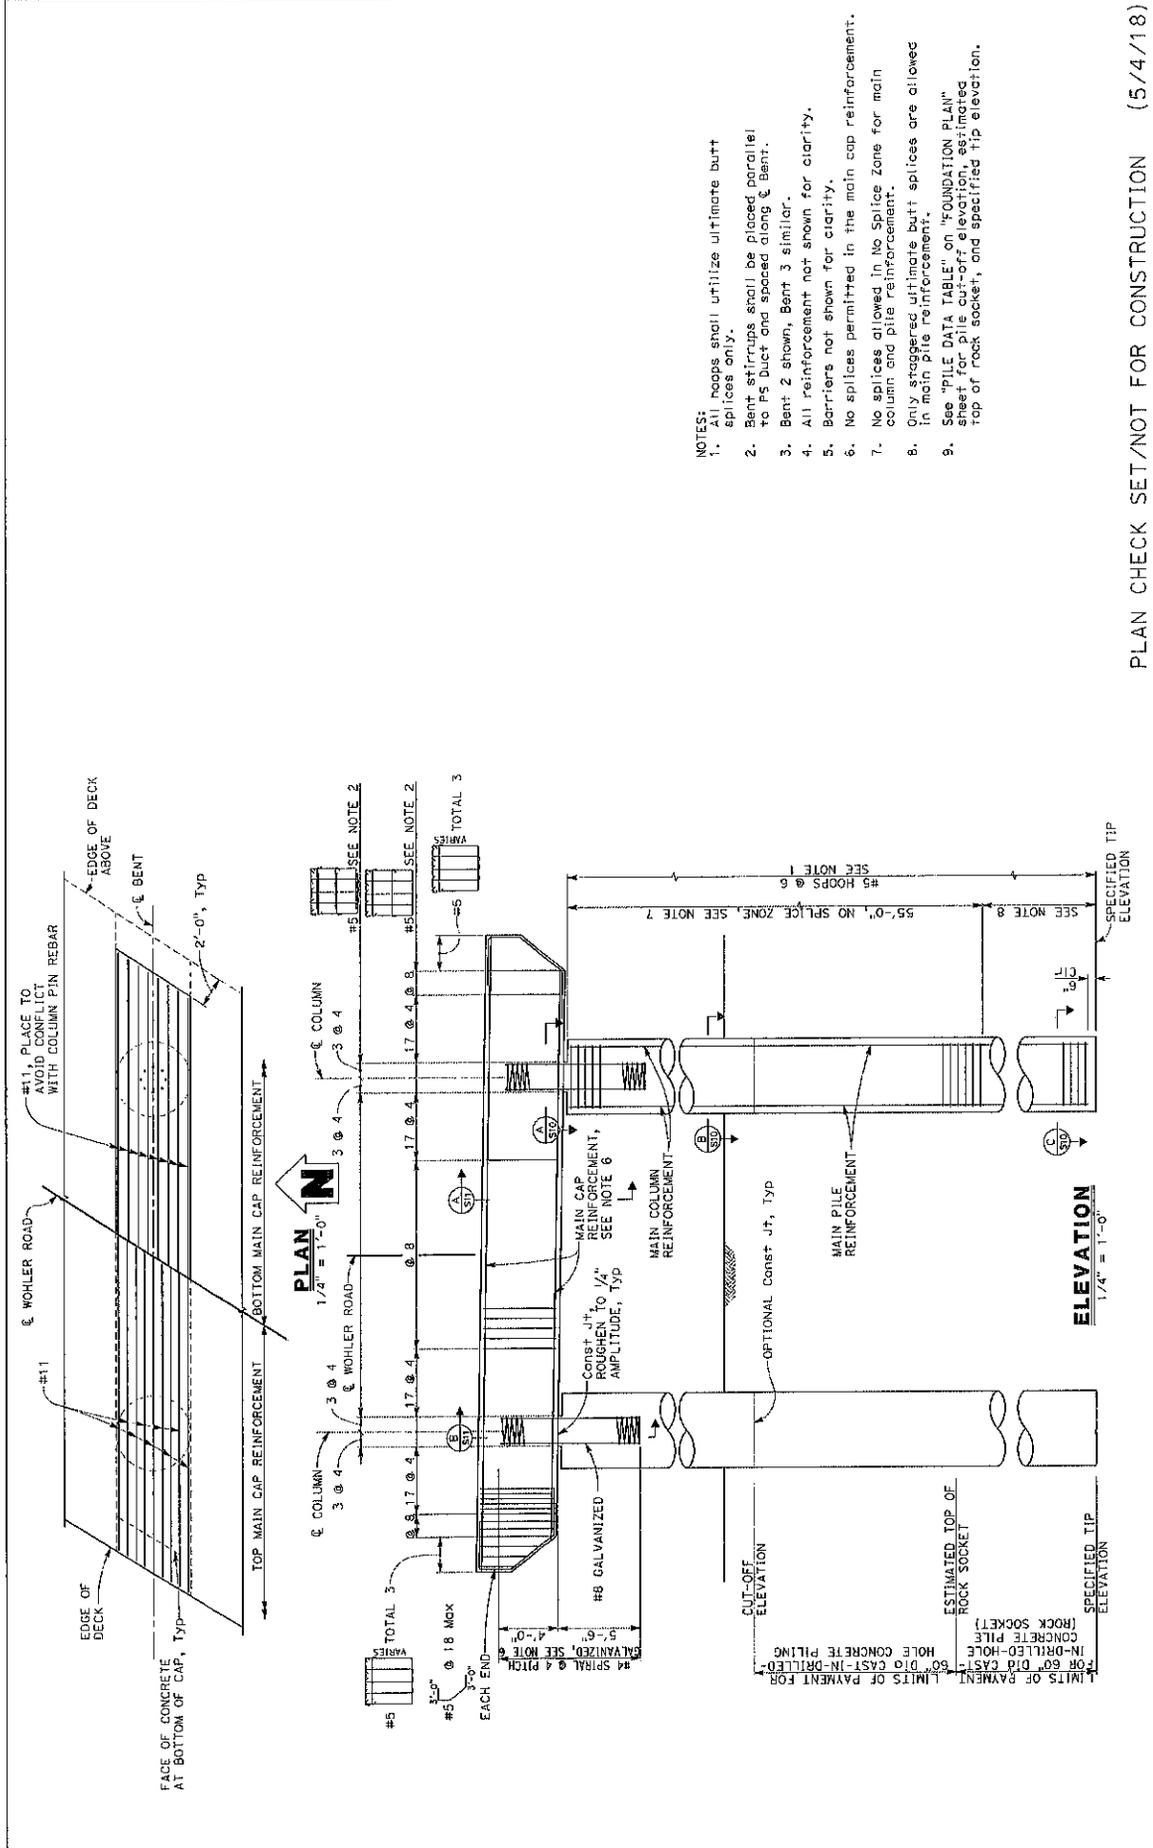

PLAN CHECK SET/NOT FOR CONSTRUCTION (5/4/18)

DESIGN BY	SEN	CONSTRUCTION COMPLETED	DATE	APPROVED BY	DATE
DRAWING BY	SMH	REGISTERED STRUCTURAL ENGINEER	9/12/14	REGISTERED ENGINEER	9/12/14
CHECKED BY	JAA	PLANS APPROVAL DATE	4/27/15	AS BUILT CONSTRUCTION	4/27/15
1. CONTRACT NUMBER: 2012020202-002 2. DATE: 5/4/18 8:35 PM		3. NO BUILT INFORMATION TO BE COMPLETED AFTER CONSTRUCTION		4. BIGGS CARDOSA ASSOCIATES, INC. STRUCTURAL ENGINEERS 5. 1000 N. UNIVERSITY BLVD. SUITE 100 6. TAMPA, FL 33606 7. TEL: 813-973-1111 8. FAX: 813-973-1112	
COUNTY OF SONOMA DEPARTMENT OF TRANSPORTATION & PUBLIC WORKS SUSAN R. KLASSEN, P.E. DIRECTOR			BENT LAYOUT WOHLER ROAD BRIDGE AT MARK WEST CREEK REPLACEMENT		
BRIDGE NUMBER: 001125 FISCAL YEAR: 15 SHEET NUMBER: 21 TOTAL SHEETS: 32			BRIDGE NUMBER: 001125 FISCAL YEAR: 15 SHEET NUMBER: 21 TOTAL SHEETS: 32		

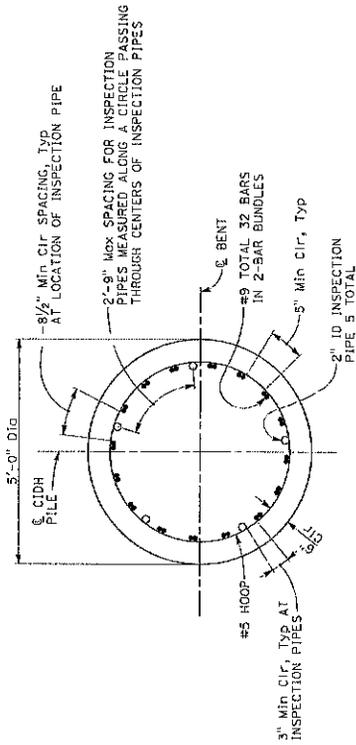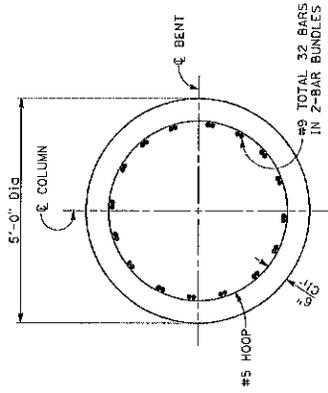
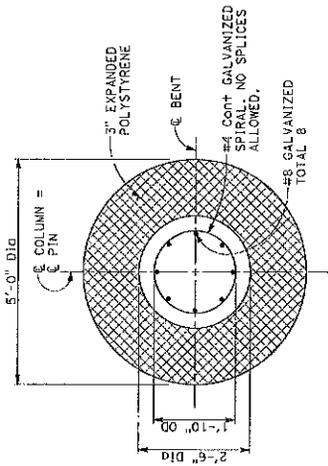


PLAN CHECK SET/NOT FOR CONSTRUCTION (5/4/18)

DESIGN BY	SEN	REGISTERED STRUCTURAL ENGINEER	CONSTRUCTION COMPLETE:	BERKELEY ENGINEERING ASSOCIATES INC. STRUCTURAL ENGINEERS	BRIDGE NUMBER: 0310	BENT DETAILS No. 1
DRAWING BY	SRH	PLANS APPROVAL DATE	DATE	DATE	SUBJECT NUMBER	WOHLER ROAD BRIDGE
CHECKED BY	JAA	NO. 2839	1/17/14	1/17/14	FISCAL YEAR	AT MARK WEST CREEK REPLACEMENT
		DATE: 12/17/13	DATE: 1/17/14	DATE: 1/17/14	SHEET NUMBER	
		DATE: 5/4/18	DATE: 5/4/18	DATE: 5/4/18	TOTAL SHEETS	02



BERKELEY ENGINEERING ASSOCIATES INC. STRUCTURAL ENGINEERS
 1000 UNIVERSITY AVENUE, SUITE 200, BERKELEY, CA 94702
 TEL: 415-848-1000 FAX: 415-848-1001

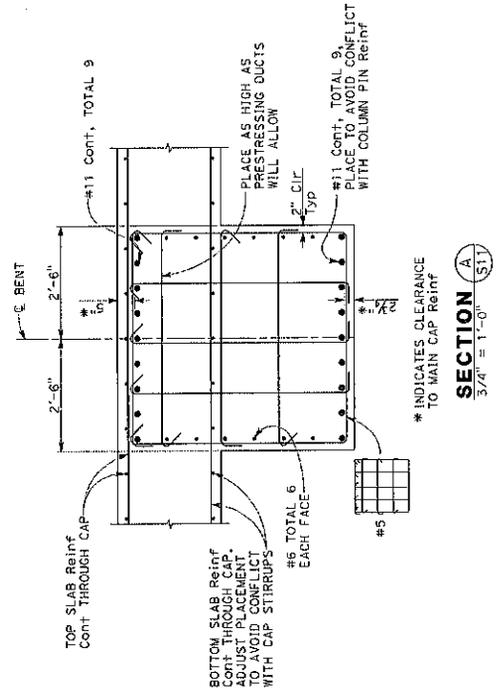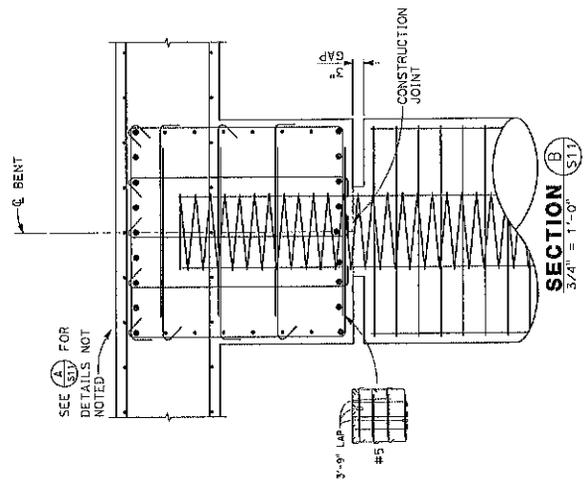

BRIDGE NUMBER	0000
BUDGET NUMBER	00125
FISCAL YEAR	
SHEET NUMBER	25
TOTAL SHEETS	28

PLAN CHECK SET/NOT FOR CONSTRUCTION (5/4/18)

BENT DETAILS No. 2

WOHLER ROAD BRIDGE
AT MARK WEST CREEK REPLACEMENT

COUNTY OF SONOMA
DEPARTMENT OF TRANSPORTATION & PUBLIC WORKS
MASON R. GLASSER, P.E. DIRECTOR



BIGGS CARDOSA ASSOCIATES INC
STRUCTURAL ENGINEERS
1000 S. ALVARADO AVE., SUITE 200
SAN ANTONIO, TEXAS 78204

CONSTRUCTION COMPLETED	
DESIGNED BY	AS BUILT
CHECKED BY	APPROVED
DATE	8/12/14
DATE	4/27/15
DATE	3/27/15

*INDICATES CLEARANCE TO MAIN CAP REINF




REGISTERED STRUCTURAL ENGINEER


PLANS APPROVAL DATE

U.S. GEOLOGICAL SURVEY, 3450 HILL DR., F.S. 24

DESIGN BY	SEN
DRAWING BY	SMH
CHECKED BY	JAM

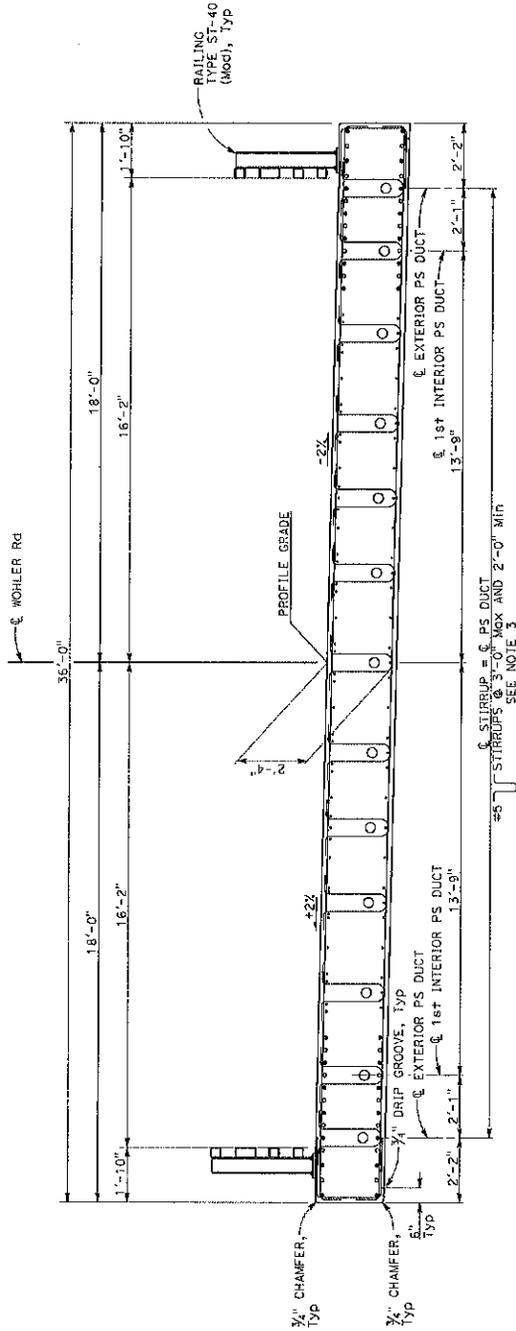

TYPICAL SECTION
1/2" = 1'-0"

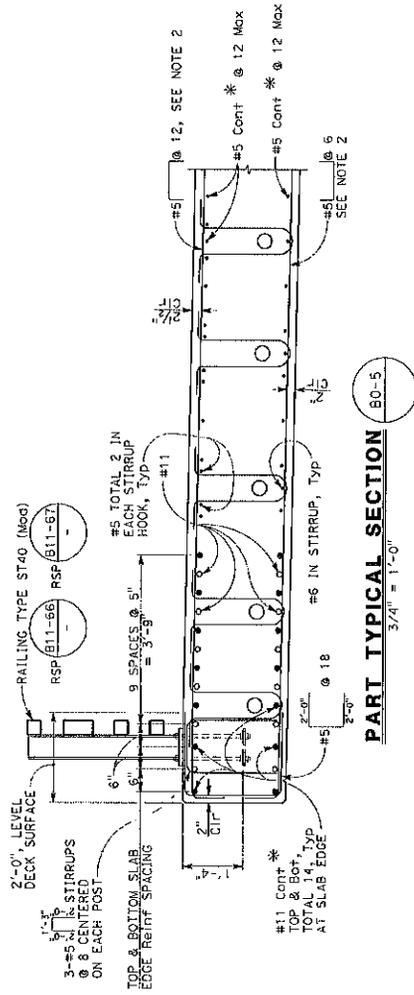

PART TYPICAL SECTION BO-5
3/4" = 1'-0"


- NOTES:**
- All dimensions measured radial to \pm Wohler Road.
 - Transverse reinforcement shall be placed radial to \pm Wohler Road and spaced along \pm Wohler Road.
 - Prestressing ducts shall be placed concentric to \pm Wohler Road. Number of ducts shall be determined by the contractor.

LEGEND:

- Indicates full length reinforcement. Cont reinforcement identified by * must be spliced with service splices outside the No Splice Zones. Lap splices equal to two times the standard lap length may be substituted for service splices for continuous reinforcement identified that are within 6'-6" of \pm Wohler Road. See SLAB DETAILS No. 1 and SLAB DETAILS No. 2 sheets for No Splice Zones.
- Indicates partial length reinforcement. For limits, see SLAB DETAILS No. 1 and SLAB DETAILS No. 2 sheets.

PLAN CHECK SET/NOT FOR CONSTRUCTION (5/4/18)

DESIGN BY	SEM	REGISTERED STRUCTURAL ENGINEER	CONSTRUCTION COMPLETED	TYPICAL SECTION No. 1	BRIDGE NUMBER: BO-070
DRAWING BY	SMH	RESIDENT ENGINEER	AS BUILT DRAWING BY	WOHLER ROAD BRIDGE	BUDGET NUMBER: COL132
CHECKED BY	JAA	DATE APPROVAL DATE	DATE SUBMITTED	AT MARK WEST CREEK REPLACEMENT	FISCAL YEAR
			DATE SUBMITTED	COUNTY OF SONOMA	SHEET NUMBER: 24
			DATE SUBMITTED	DEPARTMENT OF TRANSPORTATION & PUBLIC WORKS	TOTAL SHEETS: 28
				BRIDGE ENGINEER	
				REGISTERED PROFESSIONAL ENGINEER	
				NO. 1838	
				DATE OF EXPIRATION	
				1/1/21	
				1/27/15	
				1/2/18	
				1/2/18	
				1/2/18	

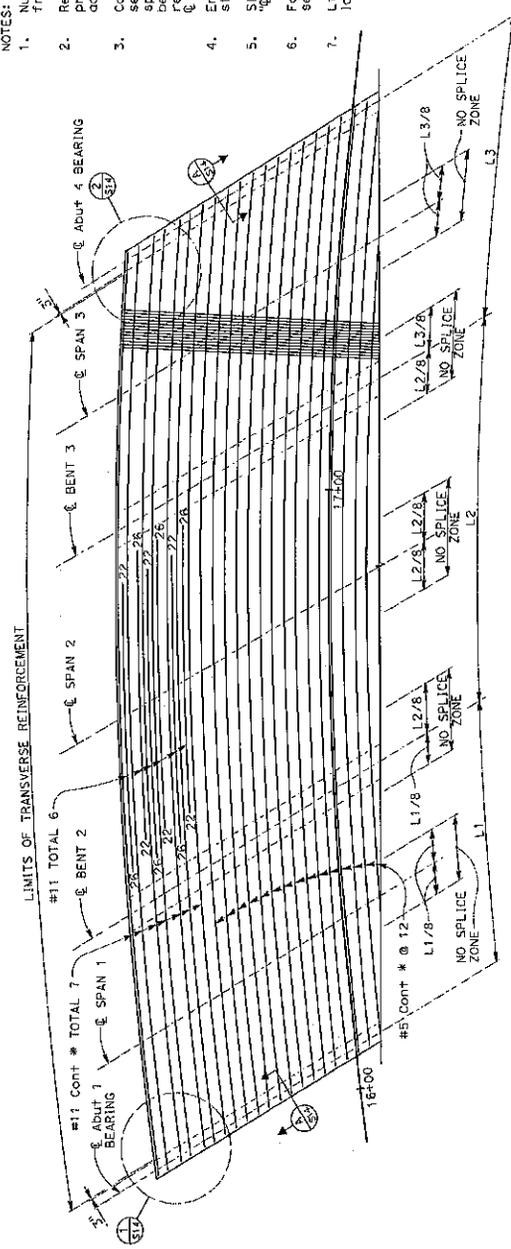

BOTTOM SLAB REINFORCEMENT
NO SCALE

- NOTES:**
1. Number at ends of bars indicates distance in feet from ϕ span.
 2. Reinforcement may be adjusted to avoid conflicts with prestressing ducts. Reinforcement may be bundled adjacent to prestressing ducts as required.
 3. Cont reinforcement identified by * must be spliced with service splices outside the No Splice Zones. Lap splices to no more than 6" and lap length may be substituted for standard lap length. Cont reinforcement identified by * that are within 6'-6" of ϕ Woller Road.
 4. Embed transverse reinforcement 2 ft into slab end diaphragm, see (1) & (2).
 5. Slab longitudinal reinforcement must be placed concentric to ϕ WOLLER ROAD.
 6. For "CAMBER DIAGRAM" and "CONCRETE STRENGTH AND TYPE LIMITS", see "DECK CONTOURS" sheet.
 7. L1, L2, and L3 are measured along the line of each longitudinal reinforcement.

DESIGN BY		SDM	REGISTERED STRUCTURAL ENGINEER		DATE		8/27/18	DATE	4/27/18	DATE	5/27/18	DATE	5/27/18	
DRAWING BY		SMH	REGISTERED STRUCTURAL ENGINEER		DATE		8/27/18	DATE	4/27/18	DATE	5/27/18	DATE	5/27/18	
CHECKED BY		JMA	REGISTERED STRUCTURAL ENGINEER		DATE		8/27/18	DATE	4/27/18	DATE	5/27/18	DATE	5/27/18	
CONSTRUCTION COMPLETE		AS PART INFORMATION TO BE COMPLETED AFTER CONSTRUCTION		RESIDENT ENGINEER BY		DATE	8/27/18	DATE	4/27/18	DATE	5/27/18	DATE	5/27/18	
COUNTY OF SONOMA		DEPARTMENT OF TRANSPORTATION & PUBLIC WORKS		RES. IN CHARGE		DATE	8/27/18	DATE	4/27/18	DATE	5/27/18	DATE	5/27/18	
SLAB DETAILS NO. 2		WOHLER ROAD BRIDGE		AT MARK WEST CREEK REPLACEMENT		BUDGET NUMBER		02115	FISCAL YEAR		27	SHEET NUMBER		27
BUDGET NUMBER		02115		FISCAL YEAR		27		SHEET NUMBER		27		TOTAL SHEETS		32


PLAN CHECK SET/NOT FOR CONSTRUCTION (5/4/18)



BIGBO CARDOBA ASSOCIATES INC
STRUCTURAL ENGINEERING
1000 S. THE ALAMEDA
SAN FRANCISCO, CA 94608
PH: 415-778-3000




REGISTERED STRUCTURAL ENGINEER
No. 8838
Exp. 12/31/19
Bigbo Cardoba
1000 S. THE ALAMEDA
SAN FRANCISCO, CA 94608
PH: 415-778-3000

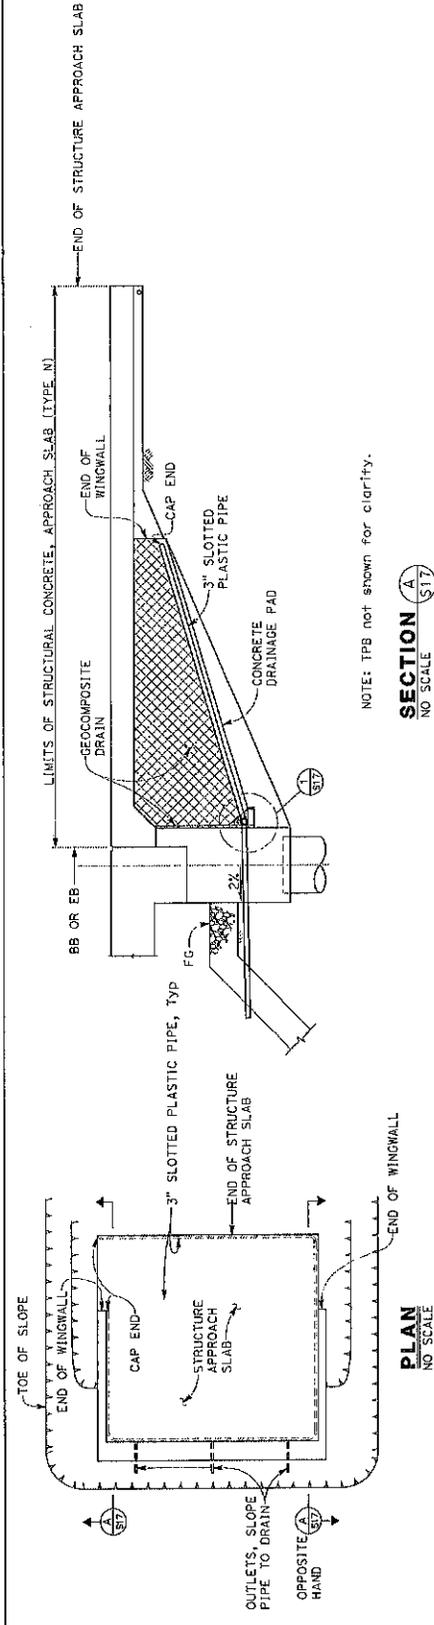

PLAN
NO SCALE

NOTE: TFS NOT SHOWN FOR CLARITY.

SECTION A
NO SCALE

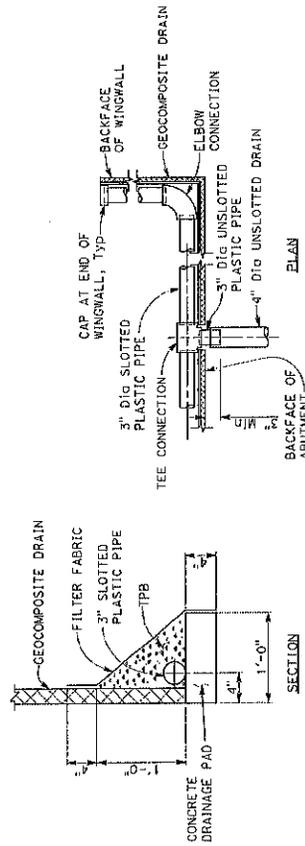

SECTION
NO SCALE

NOTE: Geocomposite drain, treated permeable base, and 3" dia slotted plastic pipe continuous behind abutment and wingwalls. Cap ends of pipes. Provide "tee" connection at each 4" dia drain.

DETAIL
NO SCALE

SECTION A
NO SCALE

PLAN
NO SCALE

REGISTERED STRUCTURAL ENGINEER PLAN APPROVAL DATE: 8/12/18 V. 301230180201518202317 205 3/4/2018 3:00 PM		REGISTERED STRUCTURAL ENGINEER NO. 2838 EXPIRES 12/31/20 8/12/18 8:58 AM 8/12/18 8:58 AM 8/24/18 8:58 AM	CONSTRUCTION COMPLETED AS BUILT AS BUILT AS BUILT AS BUILT AS BUILT AS BUILT	BIGGS CARROSA ASSOCIATES INC STRUCTURAL ENGINEERS 1000 17th Avenue San Francisco, CA 94133 415-775-8888	COUNTY OF SONOMA DEPARTMENT OF TRANSPORTATION & PUBLIC WORKS STEVE R. BLASSEN, P.E. DIRECTOR	STRUCTURE APPROACH DRAINAGE DETAILS WOHLER ROAD BRIDGE AT MARK WEST CREEK REPLACEMENT	PROJECT NUMBER: 2000-0003 BUDGET NUMBER: 00185 FISCAL YEAR: 2018 SHEET NUMBER: 50 TOTAL SHEETS: 58
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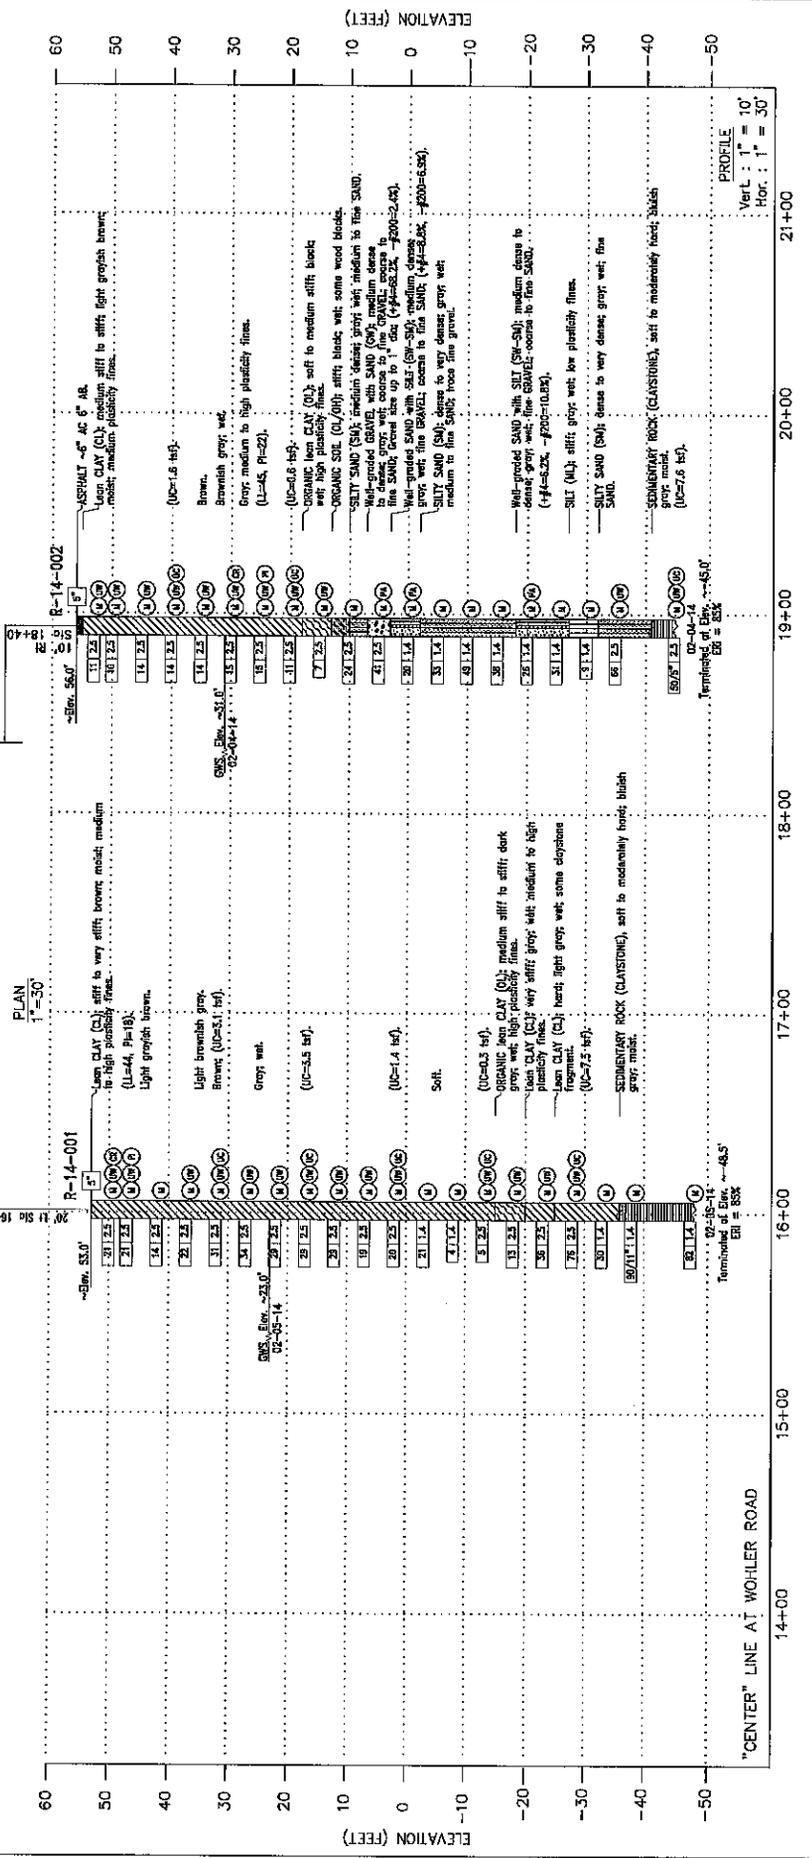
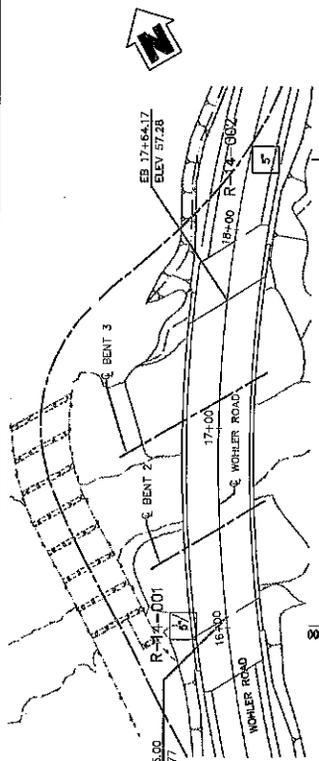
PLAN CHECK SET/NOT FOR CONSTRUCTION (5/4/18)

Notes:
 Standard Penetration Test Sampler: I.D. = 1.4"; O.D. = 2"
 Modified California Sampler: I.D. = 2.5"; O.D. = 3"
 Hammer Assembly: A 140 lb hammer with a 30" drop
 (Automatic Hammer)
 This LTB sheet was prepared in accordance with the
 California Soil & Rock Logging, Classification, and
 Presentation Manual (2010)
 See California 2010 Standard Plans A10F, A10C and
 A10H for Soil and Rock Legends.
 All dimensions are in feet unless otherwise shown.
 Base map is provided by Biggs Cardoso Associates
 Inc. 2015.

BENCHMARK AND DATUM				
MONUMENT	COORDINATES	DESCRIPTION/LOCATION		
NORTHING	EASTING	(NAD 83)		
2	194249.25	308868.39	34.97	AS 1/2" DIA. IRON PIPE (60" DEEP) NAIL IN ASPHALT AT THE NORTH END OF WOHLER ROAD BRIDGE
20	194771.04	308665.32	74.32	6" DIA. IRON PIPE NAIL IN ASPHALT AT THE INTERSECTION OF WOHLER ROAD AND RIVER ROAD
21	194280.44	308675.87	38.37	6" DIA. IRON PIPE NAIL IN ASPHALT OF WOHLER ROAD
22	194327.85	308777.84	61.89	6" DIA. IRON PIPE NAIL IN ASPHALT OF WOHLER ROAD
B001	194282.21	308801.92	99.24	DACT. IRON PIPE IN ASPHALT OF WOHLER ROAD

BASIS OF BEARINGS:

CALIFORNIA COORDINATE SYSTEM OF 1983, ZONE 1, BASED ON CALIFORNIA SURVEING AND DRAFTING VORN BASED ON CASC COORD. SYSTEM. BEARINGS, DISTANCES, AND STATIONING ARE GROUND DISTANCES. MULTIPLY BY 0.99996312 TO OBTAIN GRID DISTANCES.



DESIGN BY	PKW	DATE	05/04/18	CONSTRUCTION COMPLETION	AS BUILT APPROVAL TO BE COMPLETED AFTER CONSTRUCTION
DRAWING BY	PKW	DATE		RESERVE CHANGES BY	AS BUILT DRAWING BY
CHECKED BY	PKW	DATE		APPROVED	
		PLANS APPROVAL DATE	3/27/15	DATE SUBMITTED	3/27/15
		DATE SUBMITTED	3/16/18	DATE SUBMITTED	3/16/18
		DATE	6/24/2015 2:07 PM		

PHILLIP A. GANSZ, DIRECTOR

PARIKH ENGINEERING INC.

BIGGS CARDOSO ENGINEERS INC.

COUNTY OF SONOMA
DEPARTMENT OF TRANSPORTATION & PUBLIC WORKS

LOG OF TEST BORINGS 1 OF 2
WOHLER ROAD BRIDGE AT MARK WEST CREEK (REPLACE)

ROAD NUMBER	202-039
SHEET NUMBER	01135
TOTAL SHEETS	22

Notes:
 Standard Penetration Test Sampler, I.D. = 1.4", O.D. = 2"
 Modified California Sampler, I.D. = 2.5", O.D. = 3"
 Hammer Assembly: A 140 lb hammer with a 30" drop
 (Automatic Hammer)

This LOGB sheet was prepared in accordance with the
 Caltrans Soil & Rock, Logging, Classification, and
 Presentation Manual (2010)

See Caltrans 2010 Standard Plans A10F, A10G and
 A10H for Soil and Rock Legends.



All dimensions are in feet unless otherwise shown.

Base map is provided by Biggs Cardosa Associates
 Inc 2015.

MONUMENT	COORDINATES		ELEV (NAVD 88)	DESCRIPTION/LOCATION
	NORTHING	EASTING		
2	1942468.58	630888.09	55.47	O.C.T. DISK IN CONCRETE (OLD BRIDGE BECD) AT THE NORTH END OF WOHLER ROAD BRIDGE
20	1942711.04	630885.32	74.52	MAG NAIL IN ASPHALT AT THE INTERSECTION OF WOHLER ROAD AND WHEELER ROAD
21	1942963.64	630907.57	55.37	MAG NAIL IN ASPHALT OF WOHLER ROAD
22	1943027.08	630837.04	61.89	MAG NAIL IN ASPHALT OF WOHLER ROAD
69001	1942929.21	630882.02	69.24	O.C.T. DISK IN ASPHALT OF WOHLER ROAD

BASES OF BEARINGS:

CALIFORNIA COORDINATE SYSTEM OF 1983, ZONE 1 (BASED ON CALIFORNIA SURVEYING
 AND DRAFTING V.M. BASED ON CSRS CORS POSITIONS, EPOCH 2011.00). DISTANCE
 AND BEARING MEASUREMENTS ARE GROUND DISTANCES. MULTIPLY BY 0.99996312 TO OBTAIN GRID
 DISTANCES.

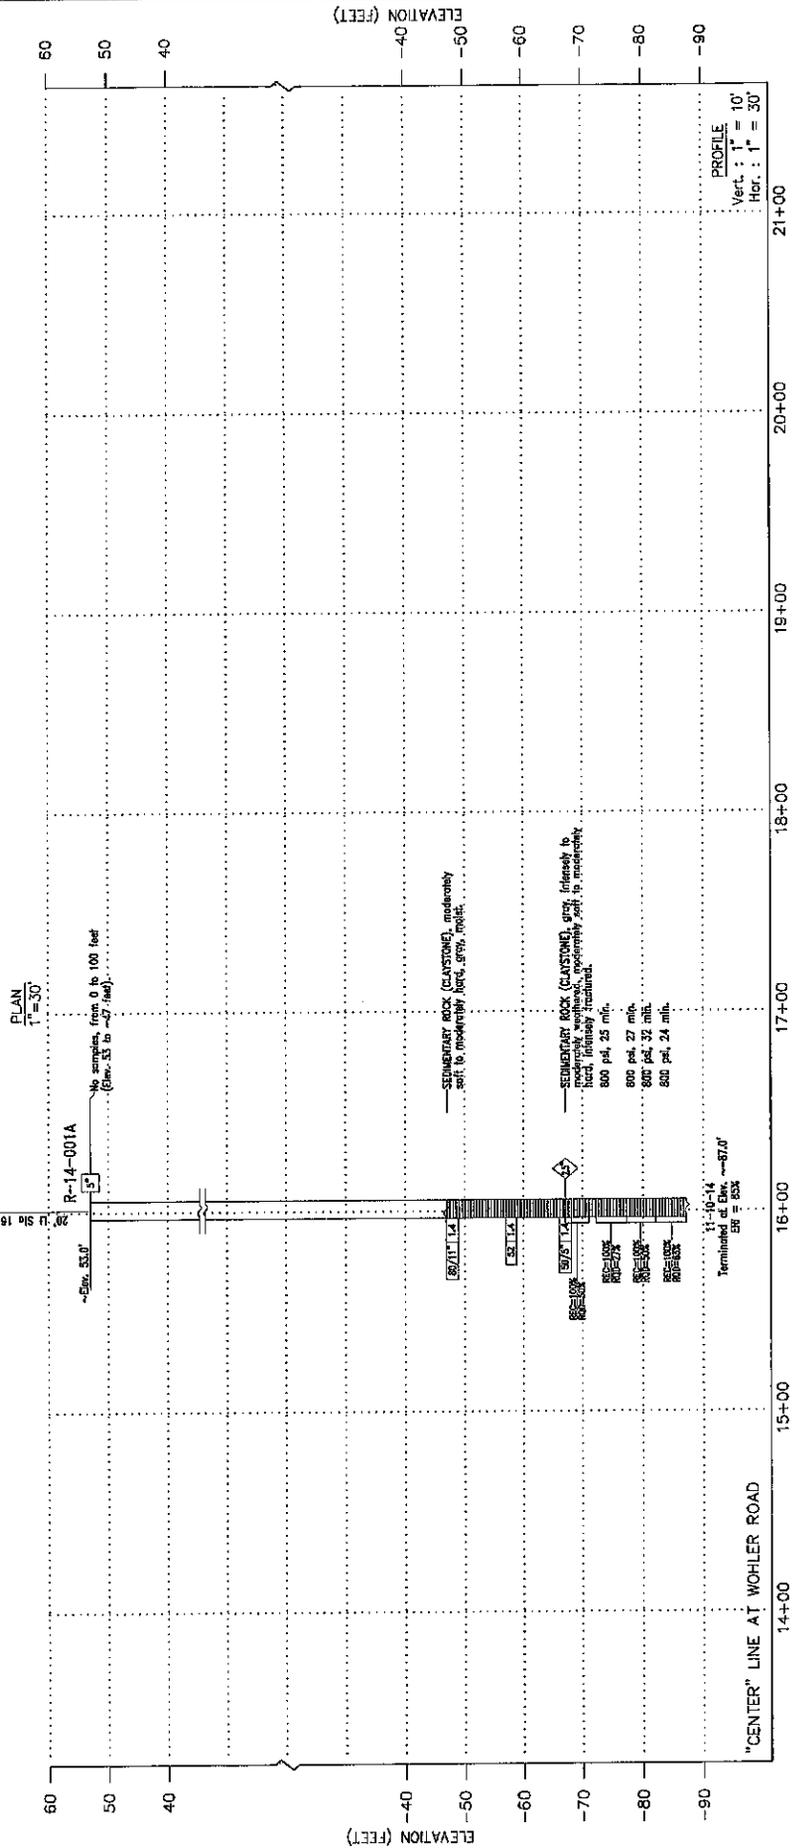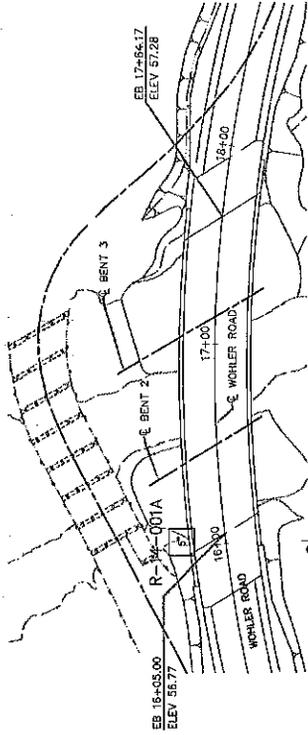


DESIGN BY: <i>[Signature]</i>	DATE: 05/04/18	CONSTRUCTION COMPLETED: _____	COUNTY OF SONOMA DEPARTMENT OF PUBLIC WORKS HIGHWAY DIVISION, DISTRICT OFFICE	ROAD NUMBER: 200-019
DRAWING BY: _____	DATE: _____	AS SHOWN BY: _____	LOG OF TEST BORINGS 2 OF 2 WOHLER ROAD BRIDGE AT MARK WEST CREEK (REPLACE)	BASSET NUMBER: C0115
CHECKED BY: _____	DATE: _____	BY: _____		SHEET NUMBER: 15 OF 17



STATE ENGINEER: _____
 COUNTY ENGINEER: _____
 DATE: _____

APPROVED BY: _____
 DATE: _____


CONSTRUCTION SEASON ONE:
CONSTRUCT BENT PILES AND
COLUMNS, AND ABUTMENT
PILES AND WALLS

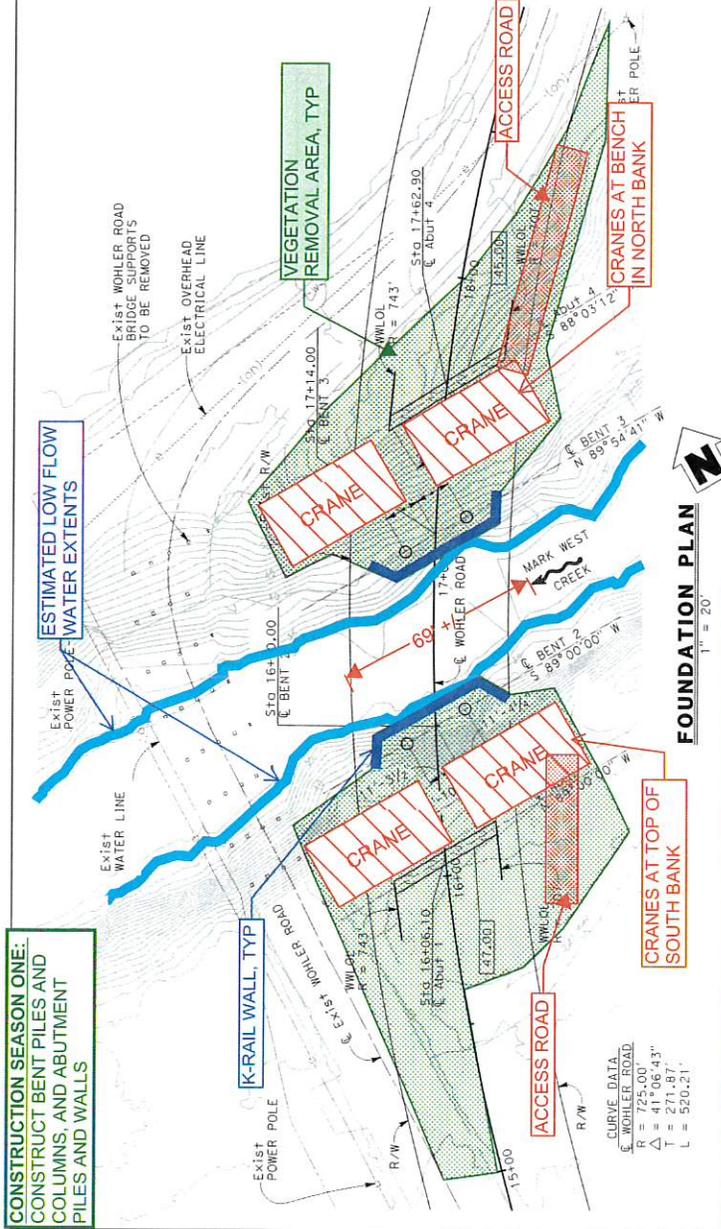

FOUNDATION PLAN
1" = 20'


HYDROLOGIC SUMMARY
(PROVIDED BY AVILA ASSOCIATES)

Drainage Area: 254 square miles
Frequency (years): 2
Discharge (cfs): 100
Water surface Elevation at
Flood Plain Data: are based
were prepared and are
of solid information is not
affected parties should mo

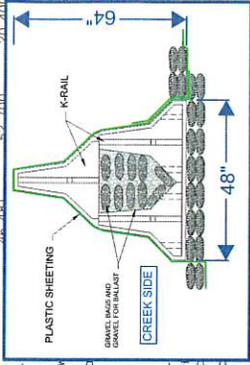

NOTES:
1. Utilities shown are for
abandoned, etc., with R
2. For property delineatic

LEGEND:
○ or ○ Indicates Bottom of Abutment Diaphragm Elevation
○ or ○ Indicates Existing Pile
→ Indicates Direction of Creek Flow

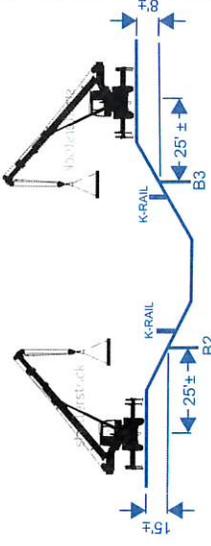

CONSTRUCT NEW BRIDGE
STAGE #1 (1ST CONSTRUCTION SEASON: DEWATER AT BENTS)

THIS APPROACH REQUIRES:
1. CUT BENCH IN NORTH CREEK BANK
2. LONGER THAN STANDARD FALSEWORK, HUNG FROM COLUMNS (L = 45' - 64' ±)

CONSTRUCTION STEPS:
1. CONSTRUCT K-RAIL BERMS
2. PUMP WATER FROM BENT PILE AREA, AS NEEDED
3. CUT CREEK BANK BENCH AND SET UP CRANE(S)
4. CONSTRUCT PILE SHAFTS UNDER SLURRY, WITH TEMPORARY CASING
5. TEST AND REAR PILES AS NEEDED
6. CONSTRUCT COLUMNS AT EACH BENT
7. MOVE CRANES AND CONSTRUCT ABUTMENT PILES, TEST AND REPAIR PILES AS NEEDED.
8. CONSTRUCT ABUTMENT WALLS.
9. IN SEASON TWO, FALSEWORK WOULD BE HUNG FROM THE SUBSTRUCTURE FOR SUPERSTRUCTURE CONSTRUCTION.

Location	Excavate or Fill	Material	Impact Area	Fill Below OHW/TOB			
				Temporary/permane	Square Feet	Acres	Average Depth (FT)
SEASON 1							
Mark West Creek Channel	N/A	N/A	Temporary, 69 LF	720	0.017	N/A	N/A
Dewatering Area	N/A	N/A	Temporary	1,000	0.023	N/A	N/A
NORTH BANK							
Bent Columns (2)	Fill	Concrete	Permanent	40	0.001	21	31
Abutment 4	Excavation	Soils	Temporary	183	0.004	7	85
Abutment 4	Fill	Concrete	Permanent	183	0.004	7	85
Access Road	Excavate	Soils	Temporary	2,500	0.057	3	300
Crane Areas	Excavate	Soils	Temporary	5,200	0.119	5	1,100
Vegetation Removal	N/A	Trees and Shrubs	N/A	7,700	0.177	N/A	N/A
SOUTH BANK							
Bent Columns (2)	Fill	Concrete	Permanent	40	0.001	20	31
Abutment 1	Excavation	Soils	Temporary	159	0.004	4	24
Abutment 1	Fill	Concrete	Permanent	159	0.004	4	24
Access Road	Excavate	Soils	Temporary	3,300	0.076	4	300
Crane Areas	Excavate	Soils	Temporary	4,800	0.110	5	900
Vegetation Removal	N/A	Trees and Shrubs	N/A	9,200	0.211	N/A	N/A

REGISTERED STRUCTURAL ENGINEER
PLANS APPROVAL DATE: 4/27/15
CHECKED BY: [Signature]

BCR
BRIDGE CONSTRUCTION
108-258-6015

DATE: 4/27/15
SUBMITTED: 4/27/15
ISSUE SUBMITTAL

REGION BY: [Signature]
DRAWING BY: [Signature]
CHECKED BY: [Signature]

PROJECT: **WOHLER ROAD BRIDGE AT MARK WEST CREEK (REPLACE)**



BUDGET NUMBER: C01125
FISCAL YEAR: 2015
SHEET NUMBER: 16
TOTAL SHEETS: 31

FRUCTION (4/27/15)

**CONSTRUCTION SEASON TWO:
HANG FALSEWORK, CONSTRUCT BRIDGE
SUPERSTRUCTURE AND ROADWAY APPROACHES
AND REMOVE EXISTING BRIDGE.**


Drainage Area: _____
Frequency (yrs) _____
Discharge (cfs) _____
Water Surface Elevation at Bridge (ft) _____
Flood Plain Data are based upon information available when the plans were prepared and are shown to meet Federal requirements. The accuracy of said information is not warranted by the County and interested or affected parties should make their own investigations.

- NOTES:
- Utilities shown are for illustrative purposes only. Verify utility locations and depths. They may need to be relocated, abandoned, etc., with Road Plans.
 - For property delineations and descriptions, see Road Plans.

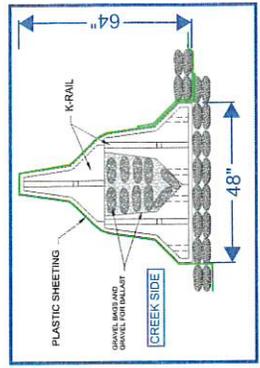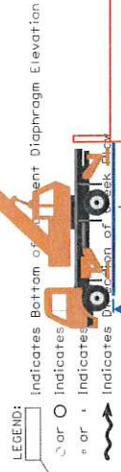

FOR CONSTRUCTION (4/27/15)

PROJECT NUMBER	00-0139
BUDGET NUMBER	00125
FISCAL YEAR	16
SHEET NUMBER	16
TOTAL SHEETS	31

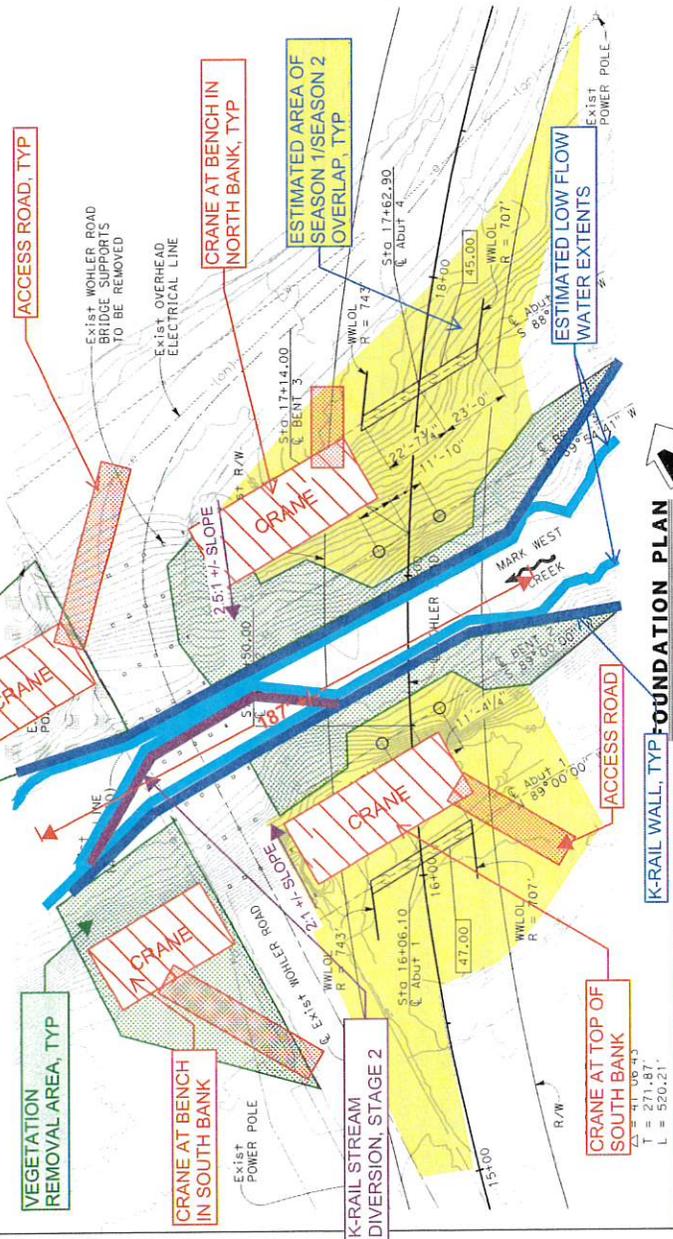

FOUNDATION PLAN


Location	Excavate or Fill	Material	Impact Area		Fill Below OHW/TOB	
			Temporary/permane	Square Feet	Average Depth (FT)	Volume (CY)
DEWATERING						
Mark West Creek Channel	N/A	N/A	Temporary, 187 LF	3,480	0.080	N/A
K-Rail (Linear Feet)	N/A	N/A	Temporary	7,050	0.049	N/A
Dewatering Area	N/A	N/A	Temporary	7,050	0.049	N/A
NORTH BANK						
Rock Slope Protection	Fill	Rock (1/4 Ton)	Permanent	5,750	0.132	320
Access Roads	Excavation	Soils	Temporary	2,700	0.062	600
Crane Areas	Excavation	Soils	Temporary	9,000	0.207	2,100
Vegetation Removal	N/A	N/A	N/A	5,700	0.131	N/A
Overlap with Season 1	N/A	N/A	N/A	7,700	0.177	N/A
SOUTH BANK						
Rock Slope Protection	Fill	Rock (1/4 Ton)	Permanent	4,500	0.103	250
Access Roads	Excavate	Soils	Temporary	2,500	0.057	400
Crane Areas	N/A	N/A	Temporary	7,300	0.168	1,600
Vegetation Removal	N/A	N/A	N/A	5,300	0.122	N/A
Overlap with Season 1	N/A	N/A	N/A	9,200	0.211	N/A
EXISTING BRIDGE REMOVAL						
Existing Abutment Removal	Excavation	Soils	Temporary	410	0.009	4
Existing Abutment Removal	Fill	Soils	Permanent	240	0.006	5
Existing Bent Removal	Excavation	Soils	Temporary	2,520	0.058	5
Existing Bent Removal	Fill	Soils	Permanent	24	0.001	5


**REMOVE EXISTING BRIDGE
STAGE #2 (2ND CONSTRUCTION SEASON): DEWATER AT
EXISTING BRIDGE PIERS:**

- THIS APPROACH REQUIRES:**
- CUT BENCH IN NORTH CREEK BANK
 - MAY REQUIRE ADDITIONAL BENCHES ON WEST SIDE OF EXIST BRIDGE TO REACH ALL PILES


CONSTRUCTION STEPS:

- CONSTRUCT K-RAIL BERMS
- CUT CREEK BANK BENCHES AS NEEDED, SET UP CRANE(S)
- HANG FALSEWORK FROM BRIDGE SUBSTRUCTURE AND CONSTRUCT SUPERSTRUCTURE
- COMPLETE NEW BRIDGE AND ROADWAY APPROACHES
- PLACE ROCK SLOPE PROTECTION
- COVER FLOWING WATER AND CREEK BANKS AT EXISTING BRIDGE TO CAPTURE DEBRIS
- REMOVE EXISTING BRIDGE DECK AND BENT CAPS
- PUMP WATER AT EXISTING PILES, AS NEEDED
- CUT EXISTING PIERS/PILE EXTENSIONS DOWN TO 5' BELOW GRADE (BELOW EST. SCOUR)
- REALIGN END OF K-RAIL TO ISOLATE EXISTING PIER IN CENTER OF CREEK.
- CUT EXISTING CENTER PIER/PILE EXTENSIONS DOWN TO 5' BELOW GRADE.



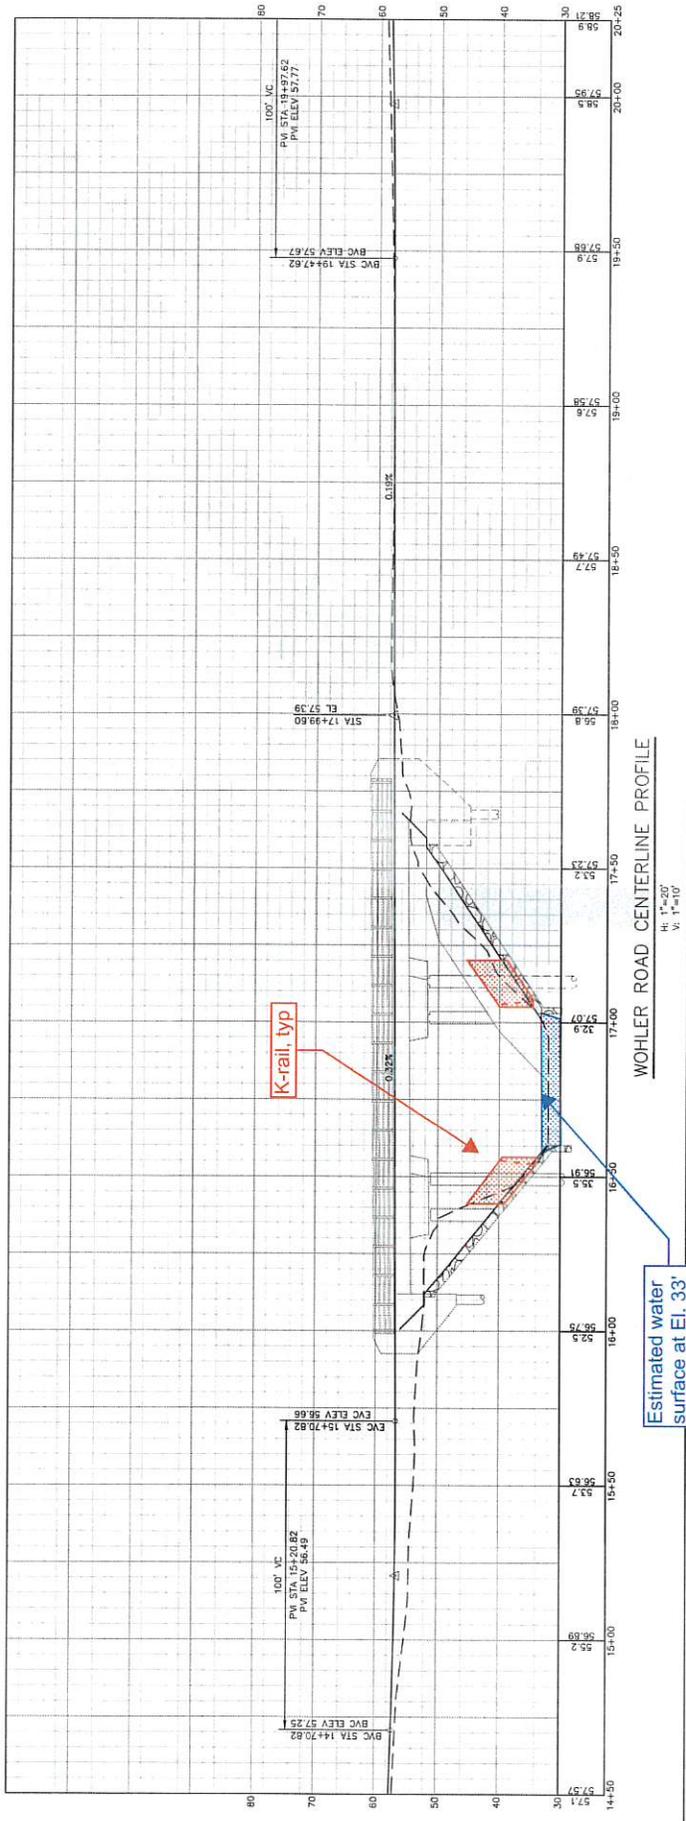


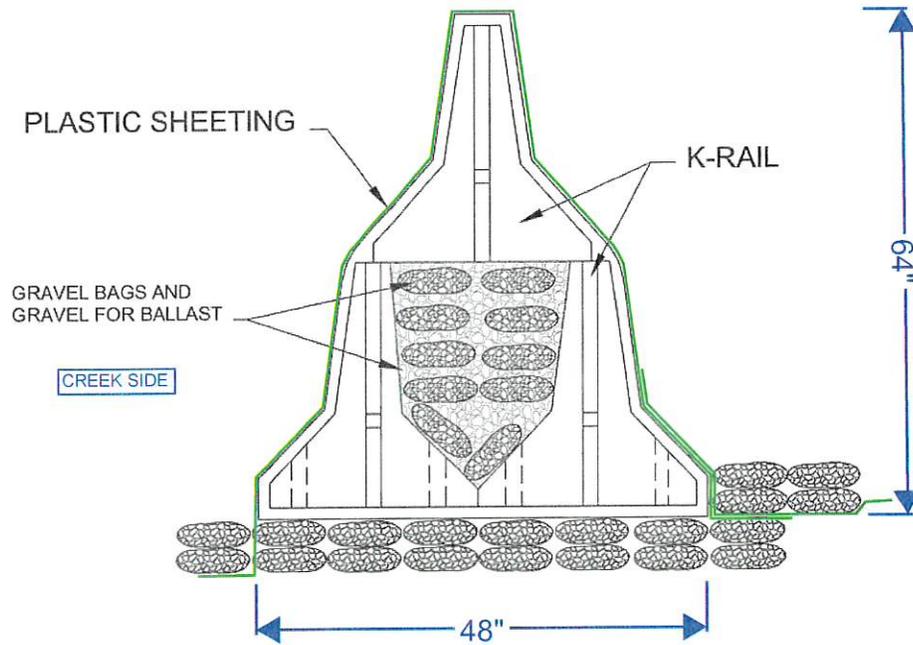

**K-Rail Isolation
Figure 2**

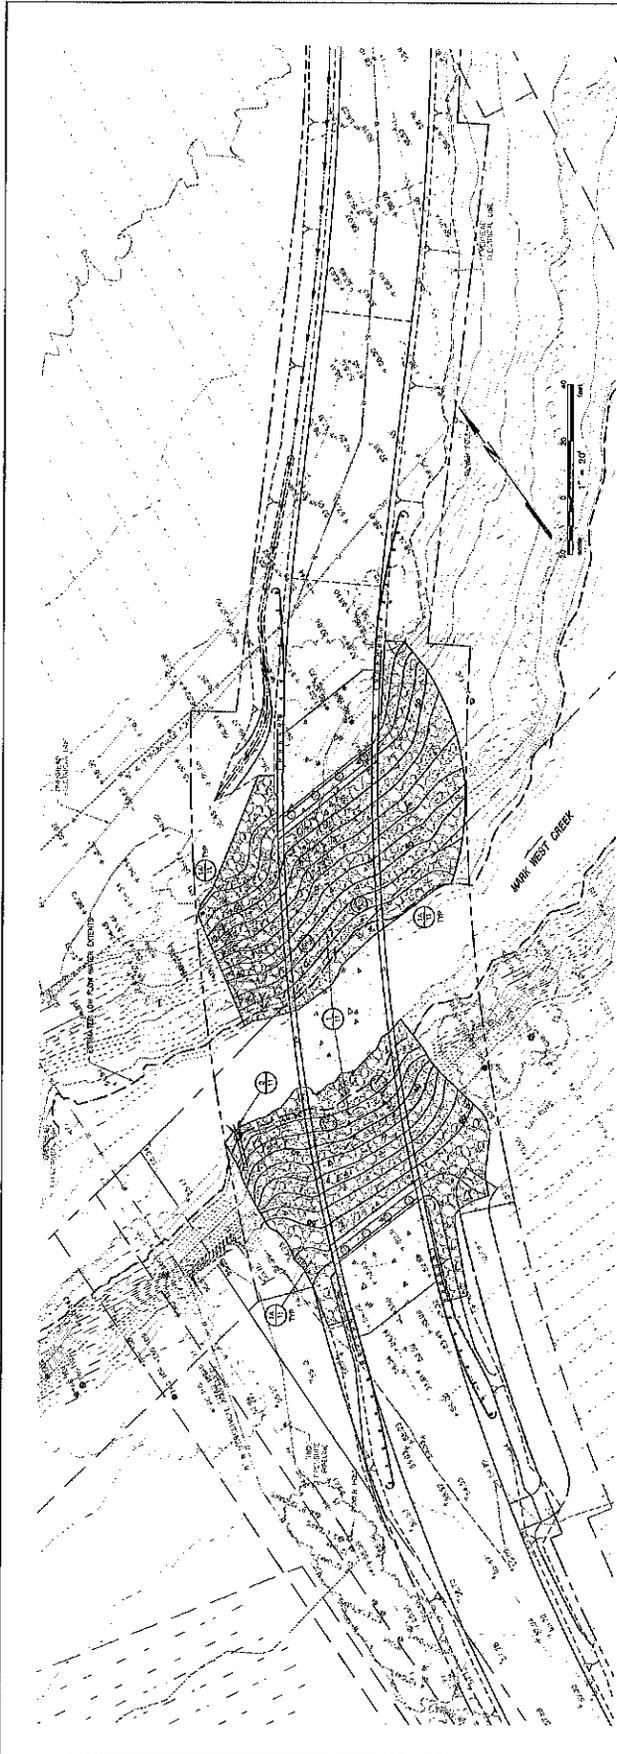

- SYMBOLS & LEGEND**
- PROPERTY LINE
 - BASEMENT
 - CONCRETE
 - PAVEMENT
 - WATER
 - DITCH
 - UTILITY LINE
 - ROCK SLOPE PROTECTION (RSP)
 - RAILROAD
 - DETAIL IDENTIFICATION

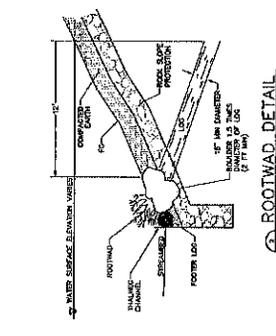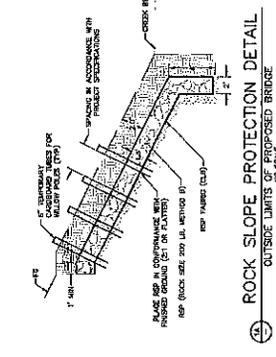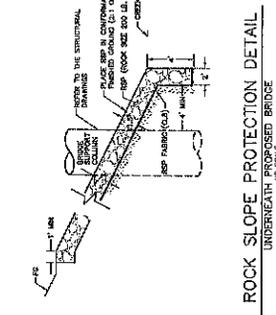

DRAFT

DESIGN BY: JAK	CONSTRUCTION COMPLETED:	ENVIRONMENTAL EXHIBIT	PROJECT NUMBER: 000-0000
DRAWING BY: JMC	DESIGNED AND CONSTRUCTED BY: RESIDENT ENGINEER	WOHLER ROAD BRIDGE AT MARK WEST CREEK REPLACEMENT	DATE: 10/1/00
CHECKED BY: GWH	DATE: 10/1/00	COUNTY OF SONOMA	ISSUE NUMBER: 1
		DEPARTMENT OF PUBLIC WORKS	SHEET NUMBER: 1
		1000 RUSSELL ST. DIXON, CA 94924	TOTAL SHEETS: 1
		BKF	
		BER	
		BRIDGE DATA	
		PROJECT NUMBER: 000-0000	
		DATE: 10/1/00	
		BY: JAK	
		CHECKED BY: GWH	
		DATE: 10/1/00	

Attachment 1

**CALIFORNIA DEPARTMENT OF FISH AND WILDLIFE
MITIGATION MONITORING AND REPORTING PROGRAM (MMRP)
CALIFORNIA ENDANGERED SPECIES ACT**

INCIDENTAL TAKE PERMIT NO. 2081-2018-007-03

PERMITTEE: Sonoma County Department of Transportation and
Public Works

PROJECT: Little Wohler Bridge Replacement Project

PURPOSE OF THE MMRP

The purpose of the MMRP is to ensure that the impact minimization and mitigation measures required by the California Department of Fish and Wildlife (CDFW) for the above-referenced Project are properly implemented, and thereby to ensure compliance with section 2081(b) of the Fish and Game Code and section 21081.6 of the Public Resources Code. A table summarizing the mitigation measures required by CDFW is attached. This table is a tool for use in monitoring and reporting on implementation of mitigation measures, but the descriptions in the table do not supersede the mitigation measures set forth in the California Incidental Take Permit (ITP) and in attachments to the ITP, and the omission of a permit requirement from the attached table does not relieve the Permittee of the obligation to ensure the requirement is performed.

OBLIGATIONS OF PERMITTEE

Mitigation measures must be implemented within the time periods indicated in the table that appears below. Permittee has the primary responsibility for monitoring compliance with all mitigation measures and for reporting to CDFW on the progress in implementing those measures. These monitoring and reporting requirements are set forth in the ITP itself and are summarized at the front of the attached table.

VERIFICATION OF COMPLIANCE, EFFECTIVENESS

CDFW may, at its sole discretion, verify compliance with any mitigation measure or independently assess the effectiveness of any mitigation measure.

TABLE OF MITIGATION MEASURES

The following items are identified for each mitigation measure: Mitigation Measure, Source, Implementation Schedule, Responsible Party, and Status/Date/Initials. The Mitigation Measure column summarizes the mitigation requirements of the ITP. The Source column identifies the ITP condition that sets forth the mitigation measure. The Implementation Schedule column shows the date or phase when each mitigation measure will be implemented. The Responsible Party column identifies the person or agency that is primarily responsible for implementing the mitigation measure. The Status/Date/Initials column shall be completed by the Permittee during preparation of each Status Report and the Final Mitigation Report, and must identify the implementation status of each mitigation measure, the date that status was determined, and the initials of the person determining the status.

Mitigation Measure	Source	Implementation Schedule	Responsible Party	Status / Date / Initials
BEFORE DISTURBING SOIL OR VEGETATION				
1 Before starting Covered Activities, Permittee shall designate a representative (Designated Representative) responsible for communications with CDFW and overseeing compliance with this ITP. Permittee shall notify CDFW in writing before starting Covered Activities of the Designated Representative's name, business address, and contact information, and shall notify CDFW in writing if a substitute Designated Representative is selected or identified at any time during the term of this ITP. Permittee shall obtain CDFW approval of the Designated Biologist in writing before starting Covered Activities, and shall also obtain approval in advance in writing if the Designated Biologist must be changed.	ITP Condition # 6.1	Before commencing ground- or vegetation-disturbing activities/ Entire Project	Permittee	
2 Permittee shall submit to CDFW in writing the name, qualifications, business address, and contact information of a biological monitor (Designated Biologist) at least 30 days before starting Covered Activities. Permittee shall ensure that the Designated Biologist is knowledgeable and experienced in the biology, natural history, including collecting and handling of the Covered Species. The Designated Biologist shall be responsible for monitoring Covered Activities to help minimize and fully mitigate or avoid the incidental take of individual Covered Species and to minimize disturbance of Covered.	ITP Condition # 6.2	Before commencing ground- or vegetation-disturbing activities	Permittee	
3 Permittee shall conduct an education program for all persons employed or otherwise working in the Project Area before performing any work. The program shall consist of a presentation from the Designated Biologist that includes a discussion of the biology and general behavior of the Covered Species, information about the distribution and habitat needs of the Covered Species, sensitivity of the Covered Species to human activities, its status pursuant to CESA including legal protection, recovery efforts, penalties for violations and Project-specific protective measures described in this ITP. Permittee shall provide interpretation for non-English speaking workers, and the same instruction shall be provided to any new workers before they are authorized to perform work in the Project Area. Permittee shall prepare and distribute wallet-sized cards or a fact sheet handout containing this information for workers to carry in the Project Area. Upon completion of the program, employees shall sign a form stating they attended the program and understand all protection measures. This training shall be repeated at least once annually for long-term and/or permanent employees that will be conducting work in the Project Area.	ITP Condition # 6.4	Before commencing ground- or vegetation-disturbing activities/ Entire Project	Permittee	
4 Permittee shall initiate a trash abatement program before starting Covered Activities and shall continue the program for the duration of the Project. Permittee shall ensure that trash and food items are contained in animal-proof containers and removed at least once a week to avoid attracting opportunistic predators such as ravens, coyotes, and feral dogs.	ITP Condition # 6.6	Before commencing ground- or vegetation-disturbing activities/ Entire Project	Permittee	
5 Permittee shall implement dust control measures during Covered Activities to facilitate visibility for monitoring of the Covered Species by the Designated Biologist. Permittee shall keep the amount of water used to the minimum amount needed, and shall not allow water to form puddles.	ITP Condition # 6.7	Before commencing ground- or vegetation-disturbing activities/ Entire Project	Permittee	
6 Before starting Covered Activities, Permittee shall clearly delineate the boundaries of the Project Area with fencing, stakes, or flags. Permittee shall restrict all Covered Activities to within the fenced, staked, or flagged areas. Permittee shall maintain all fencing, stakes, and flags until the completion of Covered Activities in that area.	ITP Condition # 6.9	Before commencing ground- or vegetation-disturbing activities/ Entire Project	Permittee	

Mitigation Measure	Source	Implementation Schedule	Responsible Party	Status / Date / Initials
<p>7 Permittee shall clearly delineate habitat of the Covered Species within the Project Area with posted signs, posting stakes, flags, and/or rope or cord, and place fencing as necessary to minimize the disturbance of Covered Species' habitat.</p>	ITP Condition # 6.10	Before commencing ground- or vegetation-disturbing activities/ Entire Project	Permittee	
<p>8 The Designated Representative shall notify CDFW 14 calendar days before starting Covered Activities and shall document compliance with all pre-Project Conditions of Approval before starting Covered Activities.</p>	ITP Condition # 7.1	Before commencing ground- or vegetation-disturbing activities	Permittee	
<p>9 CDFW has determined that habitat restoration, enhancement and long-term management of compensatory habitat is necessary and required pursuant to CESA to fully mitigate Project-related impacts of the taking on the Covered Species that will result with implementation of the Covered Activities. This determination is based on factors including an assessment of the importance of the habitat in the Project Area, the extent to which the Covered Activities will impact the habitat, and CDFW's estimate of the acreage required to provide for adequate compensation.</p> <p>To meet this requirement, the Permittee shall restore approximately 15,000 square feet of temporary riparian habitat disturbance on-site, enhance and restore approximately 22,500 square feet of riparian habitat on-site that is contiguous with other Covered Species habitat adjacent to the Project site, restore 30 square feet of creek channel, and install a Covered Species Rootwad Habitat Feature, and manage the Habitat Management (HM) pursuant to Conditions of Approval 9.1 and 9.2 below. Long-term funding for monitoring and management of created Covered Species habitat must be complete before starting Covered Activities or within 18 months of the effective date of this ITP if Security is provided pursuant to Condition of Approval 10 below for all uncompleted obligations.</p> <p>1. <u>Cost Estimates.</u> CDFW has estimated the cost of habitat creation, restoration, enhancement, and interim management of riparian vegetation enhancement and restoration as follows:</p> <ul style="list-style-type: none"> i) Habitat improvement costs for restoration of 30 square feet of creek channel, estimated at \$55,000. ii) Habitat restoration and enhancement costs for a total of 37,500 square feet of riparian habitat, and habitat creation costs for a large rootwad habitat feature, estimated at \$56,902.50. iii) Long-term management funding as described in Condition of Approval 9.2, estimated at \$144,500. Management funding is estimated initially for the purpose of providing Security to ensure implementation of habitat creation, restoration, monitoring and management. 	ITP Condition # 9.1	Before commencing ground- or vegetation-disturbing activities (or within 18 months of issuance of the ITP if Security is provided)	Permittee	

	Mitigation Measure	Source	Implementation Schedule	Responsible Party	Status / Date / Initials
10	<p>The Permittee shall prepare a Habitat Enhancement and Long-Term Management Plan (Plan) for CDFW review and acceptance within 60 days of finalizing this ITP. The Plan shall outline restoration of approximately 15,000 square feet of temporary riparian habitat disturbance, enhancement and restoration of approximately 22,500 square feet of riparian habitat on-site that is contiguous with other Covered Species habitat adjacent to the Project site, restoration of 30 square feet of creek channel and installation of a Covered Species Rootwad Habitat Feature. The Plan shall include detailed specifications for restoring all temporarily disturbed areas and a minimum of ten years monitoring unless otherwise approved by CDFW. The Plan shall include a description of how all future management of the project area shall be conducted to enhance existing habitat:</p> <ol style="list-style-type: none"> I. Construction level designs for the Covered Species Rootwad Habitat feature to be located along the downstream left bank of the Project Area. The feature will be composed of a single large rootwad keyed into the rock slope protection to establish habitat complexity and refuge for juvenile and migrating salmonids. II. Detailed Riparian Restoration Planting Plan including a map to scale, installation specifications for RSP pole plantings, seed mixes and application methods, species, quantity, size, and spacing. <p>A 10-year Long-Term Management Plan to ensure the long-term viability of the on-site mitigation, which includes a description of how all future management of the riparian enhancement and restoration will be conducted to enhance and maintain habitat for the benefit of the Covered Species. At a minimum, the Plan shall record annually: a) location and alignment of the habitat feature, b) density of plantings, c) dated photographs, d) survival of riparian restoration plantings, e) vegetation viability with success criteria, and g) recommendations for on-going adaptive management of the habitat feature and vegetation.</p>	ITP Condition # 9.2	Before commencing ground- or vegetation-disturbing activities (or within 18 months of issuance of the ITP if Security is provided)	Permittee	

Mitigation Measure	Source	Implementation Schedule	Responsible Party	Status / Date / Initials
<p>11</p> <p>The Permittee may proceed with Covered Activities only after the Permittee has ensured funding (Security) to complete any activity required by Condition of Approval 9 that has not been completed before Covered Activities begin. Permittee shall provide Security as follows:</p> <ol style="list-style-type: none"> 1. <u>Security Amount.</u> The Security shall be in the amount of \$256,402.50. This amount is based on the cost estimates identified in Condition of Approval 9.1 above. 2. <u>Security Form.</u> The Security shall be in the form of an irrevocable letter of credit (see Attachment 2) or another form of Security approved in advance in writing by CDFW's Office of the General Counsel. 3. <u>Security Timeline.</u> The Security shall be provided to CDFW before Covered Activities begin or within 30 days after the effective date of this ITP, whichever occurs first. 4. <u>Security Holder.</u> The Security shall be held by CDFW or in a manner approved in advance in writing by CDFW. 5. <u>Security Transmittal.</u> If CDFW holds the Security, Permittee shall transmit it to CDFW with a completed Mitigation Payment Transmittal Form (see Attachment 3) or by way of an approved instrument such as escrow, irrevocable letter of credit, or other. 6. <u>Security Drawing.</u> The Security shall allow CDFW to draw on the principal sum if CDFW, in its sole discretion, determines that the Permittee has failed to comply with the Conditions of Approval of this ITP. 7. <u>Security Release.</u> The Security (or any portion of the Security then remaining) shall be released to the Permittee after CDFW has conducted an on-site inspection and received confirmation that all secured requirements have been satisfied, as evidenced by: Timely submission of all required reports. 	<p>ITP Condition # 10</p>	<p>Before commencing ground- or vegetation-disturbing activities (or within 18 months of issuance of the ITP if Security is provided)</p>	<p>Permittee</p>	
<p>DURING CONSTRUCTION</p>				
<p>12</p> <p>The Designated Biologist shall be on-site daily when Covered Activities occur. The Designated Biologist shall conduct compliance inspections to (1) minimize incidental take of the Covered Species; (2) prevent unlawful take of species; (3) check for compliance with all measures of this ITP; (4) check all exclusion zones; and (5) ensure that signs, stakes, and fencing are intact, and that Covered Activities are only occurring in the Project Area. The Designated Representative or Designated Biologist shall prepare daily written observation and inspection records summarizing: oversight activities and compliance inspections, observations of Covered Species and their sign, survey results, and monitoring activities required by this ITP. The Designated Biologist shall conduct compliance inspections a minimum of once a week during periods of inactivity and after de-watering and riparian vegetation removal are completed.</p>	<p>ITP Condition # 7.3</p>	<p>Entire Project</p>	<p>Permittee</p>	

	Mitigation Measure	Source	Implementation Schedule	Responsible Party	Status / Date / Initials
13	<p>The Designated Representative or Designated Biologist shall compile the observation and inspection records identified in Condition of Approval 7.3 into a Quarterly Compliance Report and submit it to CDFW along with a copy of the MMRP table with notes showing the current implementation status of each mitigation measure. Quarterly Compliance Reports shall be submitted to the CDFW offices listed in the Notices section of this ITP and via e-mail to CDFW's Regional Representative and Headquarters CESA Program. At the time of this ITP's approval, the CDFW Regional Representative is James Hansen (James.Hansen@wildlife.ca.gov) and Headquarters CESA Program email is CESA@wildlife.ca.gov. CDFW may at any time increase the timing and number of compliance inspections and reports required under this provision depending upon the results of previous compliance inspections. If CDFW determines the reporting schedule must be changed, CDFW will notify Permittee in writing of the new reporting schedule.</p>	ITP Condition # 7.4	Entire Project	Permittee	
14	<p>Permittee shall provide CDFW with an Annual Status Report (ASR) no later than January 31 of every year beginning with issuance of this ITP and continuing until CDFW accepts the Final Mitigation Report identified below. Each ASR shall include, at a minimum: (1) a summary of all Quarterly Compliance Reports for that year identified in Condition of Approval 7.4; (2) a general description of the status of the Project Area and Covered Activities, including actual or projected completion dates, if known; (3) a copy of the table in the MMRP with notes showing the current implementation status of each mitigation measure; (4) an assessment of the effectiveness of each completed or partially completed mitigation measure in avoiding, minimizing and mitigating Project impacts; (5) all available information about Project-related incidental take of the Covered Species; (6) an accounting of the number of acres subject to both temporary and permanent disturbance, both for the prior calendar year, and a total since ITP issuance; and (7) information about other Project impacts on the Covered Species.</p>	ITP Condition # 7.5	Entire Project	Permittee	
15	<p>The Designated Biologist shall submit all observations of Covered Species to CDFW's California Natural Diversity Database (CNDDDB) within 60 calendar days of the observation and the Designated Biologist shall include copies of the submitted forms with the next Quarterly Compliance Report or ASR, whichever is submitted first relative to the observation.</p>	ITP Condition # 7.6	Entire Project	Permittee	
16	<p>The Designated Representative shall immediately notify CDFW in writing if it determines that the Permittee is not in compliance with any Condition of Approval of this ITP, including but not limited to any actual or anticipated failure to implement measures within the time periods indicated in this ITP and/or the MMRP. The Designated Representative shall report any non-compliance with this ITP to CDFW within 24 hours.</p>	ITP Condition # 7.2	Entire Project	Permittee	
17	<p>The Designated Biologist shall maintain a construction-monitoring notebook on-site throughout the construction period, which shall include a copy of this ITP with attachments and a list of signatures of all personnel who have successfully completed the education program. Permittee shall ensure a copy of the construction-monitoring notebook is available for review at the Project site upon request by CDFW.</p>	ITP Condition # 6.5	Entire Project	Permittee	
18	<p>Permittee shall prohibit use of erosion control materials potentially harmful to Covered Species and other species, such as monofilament netting (erosion control matting) or similar material, in potential Covered Species' habitat.</p>	ITP Condition # 6.8	Entire Project	Permittee	

	Mitigation Measure	Source	Implementation Schedule	Responsible Party	Status / Date / Initials
19	Project-related personnel shall access the Project Area using existing routes, or routes identified in the Project Description and shall not cross Covered Species' habitat outside of or en route to the Project Area. Permittee shall restrict Project-related vehicle traffic to established roads, staging, and parking areas. If Permittee determines construction of routes for travel are necessary outside of the Project Area, the Designated Representative shall contact CDFW for written approval before carrying out such an activity. CDFW may require an amendment to this ITP, among other reasons, if additional take of Covered Species will occur as a result of the Project modification.	ITP Condition # 6.11	Entire Project	Permittee	
20	Permittee shall confine all Project-related parking, storage areas, laydown sites, equipment storage, and any other surface-disturbing activities to the Project Area using, to the extent possible, previously disturbed areas. Additionally, Permittee shall not use or cross Covered Species' habitat outside of the marked Project Area unless provided for as described in Condition of Approval 6.11 of this ITP.	ITP Condition # 6.12	Entire Project	Permittee	
21	Permittee shall immediately stop and, pursuant to pertinent state and federal statutes and regulations, arrange for repair and clean up by qualified individuals of any fuel or hazardous waste leaks or spills at the time of occurrence, or as soon as it is safe to do so. Permittee shall exclude the storage and handling of hazardous materials from the Project Area and shall properly contain and dispose of any unused or leftover hazardous products off-site.	ITP Condition # 6.13	Entire Project	Permittee	
22	Permittee shall provide CDFW staff with reasonable access to the Project and mitigation lands under Permittee control, and shall otherwise fully cooperate with CDFW efforts to verify compliance with or effectiveness of mitigation measures set forth in this ITP.	ITP Condition # 6.14	Entire Project	Permittee	
23	Permittee shall conduct Covered Activities between June 15 and October 15 of any year.	ITP Condition # 8.1	Entire Project	Permittee	
24	Work within the Project Area shall be confined to the period of June 15 to October 15. Any extension of the work period will require an amendment to this ITP. The amendment request for a work period extension shall: 1) describe the extent of work already completed; 2) detail the activities that remain to be completed; 3) detail the time required to complete each of the remaining activities; 4) provide photographs of both the current work completed and the proposed site for continued work; and 5) include an assessment of the impacts of the work extension of Covered Species.	ITP Condition # 8.2	Entire Project	Permittee	
25	All in-water work within Mark West Creek shall be conducted inside cofferdams or leak proof K-rails and in isolation from flowing water.	ITP Condition # 8.3	Entire Project	Permittee	
26	All Covered Species habitat enhancement work shall be completed according to construction ready plans, Wohler Road Bridge at Mark West Creek Replacement, prepared by Biggs Cardosa Associates INC., dated May 2018 (Figure 2); Dewatering Plan Figures prepared by Sonoma County DTPW, dated April 2018 (Figure 3); and Environmental Exhibit, prepared by BKF Engineers, dated April 2018 (Figure 4), where further detailed plans shall be reviewed and accepted by CDFW within 60 days of final ITP issuance. The Permittee shall notify CDFW if modifications are made to any Attachment listed in this ITP prior to construction. At the discretion of CDFW, minor plan modifications may require an amendment to this ITP.	ITP Condition # 8.4	Entire Project	Permittee	

Mitigation Measure	Source	Implementation Schedule	Responsible Party	Status / Date / Initials
<p>27</p> <p>Permittee shall minimize the potential for Covered Species to be entrained during de-watering activities. The Permittee shall implement the use of a screen in accordance with the National Marine Fisheries Service 1996 Juvenile Fish Screen Criteria for Pump Intakes. Screen material may be constructed of any rigid woven, perforated, or slotted material that provides water passage while physically excluding fish. Round openings in the screen shall not exceed 3/32-inch diameter, square openings shall not exceed 3/32-inch measured diagonally, and slotted openings shall not exceed 0.069 inches in width. Approach velocity shall not exceed 0.33 feet per second.</p>	<p>ITP Condition # 8.5</p>	<p>Entire Project</p>	<p>Permittee</p>	
<p>28</p> <p>The Permittee shall implement a detailed Dewatering and Covered Species Rescue Plan to include, at a minimum, the following measures:</p> <ul style="list-style-type: none"> a) Only a CDFW-approved biologist with experience in Covered Species capture and handling shall participate in the capture, handling, and monitoring of Covered Species. b) Relocation activities shall be performed during the morning when temperatures are coolest. Hourly air and water temperatures shall be measured and recorded. c) Before removal and relocation of Covered Species, the Designated Biologist shall identify the most appropriate release location(s). Release locations shall provide suitable habitat for Covered Species and shall be selected to minimize the likelihood of reentering the work area. Suitable habitat is defined as creek sections that will remain wet over the summer. d) Following installation of water diversion structures, and prior to Project activities, a CDFW-approved biologist shall perform surveys for Covered Species in the Project Area, collect, and relocate them to the nearest predetermined suitable habitat. During holding and transportation, Covered Species shall be held in stream water collected from the site. e) Prior to fully dewatering the Project Area, remaining Covered Species in the work area shall be rescued. Dewatering efforts shall be monitored by the Designated Biologist at all times. The Designated Biologist shall reduce the rate of diversion if it appears that Covered Species may be stranded. f) Efforts shall be made to reduce collecting and handling stress, minimize the time that Covered Species are held in buckets, and minimize handling stress during processing and release. Covered Species shall not be held in containers with other species. If not immediately released, buckets must be kept in the shade and water temperatures monitored to be consistent with the temperature in the creek. Immediately after collection, Covered Species shall be identified and counted. Capture methods may include dip nets. All nets shall be made of a soft braded nylon material that is non-abrasive. Mesh sizing shall be matched to species and the life stages likely encountered. 	<p>ITP Condition # 8.6</p>	<p>Entire Project</p>	<p>Permittee</p>	

Mitigation Measure	Source	Implementation Schedule	Responsible Party	Status / Date / Initials
<p>g) No employee or contractor shall remove any Covered Species, dead or alive, from the site for personal use. All efforts to reduce the time that live Covered Species are out of the water shall be made to reduce the chances of incidental take during the rescue. All Covered Species are to be promptly returned to the water with the exception of mortality.</p> <p>h) Covered Species shall be processed first and released as soon as possible. Species name and length data will be recorded on data sheets, as well as time, date, location, gear type, water temperature, and any other pertinent observations of the Covered Species.</p> <p>i) Rescue operations may result in Covered Species mortality. If Covered Species suffer mortality, the Permittee shall preserve individuals by freezing or placing in a sealed container with 10 percent formalin solution. Information on time and exact location of any incidental take, method of take, length of time from death to preservation, water temperature, and any other relevant information will be recorded in writing. Permittee shall contact the CDFW regional representative for instructions on transmitting preserved individuals.</p> <p>j) After completing the rescue, a brief documentation report shall be prepared. The report shall include information on the personnel conducting the Covered Species rescue, methods used, numbers of Covered Species collected and relocated, length data, and estimate of the survival of Covered Species immediately after release. Photographs of the site and rescue operations shall be included. Any take of non-Covered Species shall be documented. The report shall be provided by the Permittee to CDFW in the next Quarterly Compliance Report required by Condition of Approval 7.4.</p> <p>k) After the Covered Species rescue effort is completed, if additional Covered Species are observed, Project activities shall cease until those individuals have been relocated. The Designated Biologist shall remain at the site during dewatering to rescue additional Covered Species as necessary.</p> <p>l) Reintroduction of stream flows shall be gradual to the isolated work area, so as to prevent stranding, channel instability, or excessive scour. The Designated Biologist shall monitor upstream and downstream reaches to ensure no Covered Species are stranded or in distress during reintroduction of flows. If conditions causing or contributing to stress and/or injury are observed, the Permittee shall take immediate remedial actions directed at lessening sources of stress. This may include a more gradual reintroduction of flows, to avoid abrupt water surface elevation changes both downstream and upstream of the Project Area.</p>				
<p>29</p> <p>Permittee shall immediately notify the Designated Biologist if a Covered Species is taken or injured by a Project-related activity, or if a Covered Species is otherwise found dead or injured within the vicinity of the Project. The Designated Biologist or Designated Representative shall provide initial notification to CDFW by calling the Regional Office at (707) 428-2002. The initial notification to CDFW shall include information regarding the location, species, and number of animals taken or injured and the ITP Number. Following initial notification, Permittee shall send CDFW a written report within two calendar days. The report shall include the date and time of the finding or incident, location of the animal or carcass, and if possible provide a photograph, explanation as to cause of take or injury, and any other pertinent information.</p>	<p>ITP Condition # 7.8</p>	<p>Entire Project</p>	<p>Permittee</p>	

	Mitigation Measure	Source	Implementation Schedule	Responsible Party	Status / Date / Initials
30	To ensure compliance with the Conditions of Approval of this ITP, the Designated Biologist shall have authority to immediately stop any activity that does not comply with this ITP, and/or to order any reasonable measure to avoid the unauthorized take of an individual of the Covered Species in consultation with CDFW.	ITP Condition # 6.3	Entire Project	CDFW	
POST-CONSTRUCTION					
31	Upon completion of Covered Activities, Permittee shall remove from the Project Area and properly dispose of all temporary fill and construction refuse, including, but not limited to, broken equipment parts, wrapping material, cords, cables, wire, rope, strapping, twine, buckets, metal or plastic containers, and boxes.	ITP Condition # 6.15	Post-construction	Permittee	
32	No later than 45 days after completion of all mitigation measures, Permittee shall provide CDFW with a Final Mitigation Report. The Designated Biologist shall prepare the Final Mitigation Report which shall include, at a minimum: (1) a summary of all Quarterly Compliance Reports and all ASRs; (2) a copy of the table in the MMRP with notes showing when each of the mitigation measures was implemented; (3) all available information about Project-related incidental take of the Covered Species; (4) information about other Project impacts on the Covered Species; (5) beginning and ending dates of Covered Activities; (6) an assessment of the effectiveness of this ITP's Conditions of Approval in minimizing and fully mitigating Project impacts of the taking on Covered Species; (7) recommendations on how mitigation measures might be changed to more effectively minimize take and mitigate the impacts of future projects on the Covered Species; and (8) any other pertinent information.	ITP Condition # 7.7	Post-construction and after completion of mitigation	Permittee	
45	CDFW accepts the Final Mitigation Report as complete.		Post-construction	CDFW	

IRREVOCABLE STANDBY LETTER OF CREDIT
NO. [*Number issued by financial institution*]

Issue Date: [*date*]

Beneficiary:

California Department of Fish and Wildlife
Post Office Box 944209
Sacramento, CA 94244-2090
Attn: HCPB Mitigation Account Coordinator

Amount: U.S. \$[*dollar number*] [(*dollar amount*)]

Expiry: [*Date*] at our counters

Dear Sirs:

1. At the request and on the instruction of our customer, [*name of applicant*] ("Applicant"), we, [*Name of financial institution*] ("Issuer"), hereby establish in favor of the beneficiary, the California Department of Fish and Wildlife ("CDFW"), this irrevocable standby letter of credit ("Credit") in the principal sum of U.S. \$[*dollar number*] [(*dollar amount*)] ("Principal Sum").
2. We are informed this Credit is and has been established for the benefit of the CDFW pursuant to the terms of the incidental take permit for the [*name of project*] issued by the CDFW to the Applicant on [*date*] (No. [*number*]) ("Permit").
3. We are further informed that pursuant to the Permit, the Applicant has agreed to complete certain mitigation requirements, as set forth in Conditions [*numbers*] in the Permit ("Mitigation Requirements").
4. We are finally informed that this Credit is intended by the CDFW and the Applicant to serve as a security device for the performance by the Applicant of the Mitigation Requirements.
5. The CDFW shall be entitled to draw upon this Credit only by presentation of a duly executed Certificate for Drawing ("Certificate") in the same form as Attachment A, which is attached hereto, at our office located at [*name and address of financial institution*].
6. The Certificate shall be completed and signed by an "Authorized Representative" of the CDFW as defined in paragraph 12 below. Presentation by the CDFW of a completed Certificate may be made in person or by registered mail, return receipt requested, or by overnight courier.
7. Upon presentation of a duly executed Certificate as above provided, payment shall be made to the CDFW, or to the account of the CDFW, in immediately available funds, as the CDFW shall specify.

8. If a demand for payment does not conform to the terms and conditions of this Credit, we shall give the CDFW prompt notice that the demand for payment was not effected in accordance with the terms and conditions of this Credit, state the reasons therefore, and await further instruction.
9. Upon being notified that the demand for payment was not effected in conformity with the Credit, the CDFW may correct any such non-conforming demand for payment under the terms and conditions stated herein.
10. All drawings under this Credit shall be paid with our funds. Each drawing honored by us hereunder shall reduce, *pro tanto*, the Principal Sum. By paying to the CDFW an amount demanded in accordance herewith, we make no representations as to the correctness of the amount demanded.
11. This Credit will be cancelled upon receipt by us of Certificate of Cancellation, which: (i) shall be in the form of Attachment B, which is attached hereto, and (ii) shall be completed and signed by an Authorized Representative of the CDFW, as defined in paragraph 12 below.
12. An "Authorized Representative" shall mean either the Director of the California Department of Fish and Wildlife, the General Counsel of the California Department of Fish and Wildlife, or a Regional Manager of the California Department of Fish and Wildlife.
13. This Credit shall be automatically extended without amendment for additional periods of one year from the present or any future expiration date hereof, unless at least sixty (60) days prior to any such date, we notify the CDFW in writing by registered mail, return receipt requested, or by overnight courier that we elect not to consider this Credit extended for any such period.
14. Communications with respect to this Credit shall be in writing and addressed to us at [**name and address of financial institution**], specifically referring upon such writing to this credit by number. The address for notices with respect to this Credit shall be: (i) for the CDFW: California Department of Fish and Wildlife, Habitat Conservation Planning Branch, 1416 Ninth Street, 12th Floor, Sacramento, California 95814-2090 Attn: HCPB Mitigation Account Coordinator; and (ii) for the Applicant: [**name and address of applicant**].
15. This Credit may not be transferred.
16. This Credit is subject to the International Standby Practices 1998 ("ISP 98"). As to matters not covered by the ISP 98 and to the extent not inconsistent with the ISP 98, this credit shall be governed by and construed in accordance with the Uniform Commercial Code, Article 5 of the State of California.
17. This Credit shall, if not canceled, expire on [**expiration date**], or any extended expiration date.

18. We hereby agree with the CDFW that documents presented in compliance with the terms of this Credit will be duly honored upon presentation, as specified herein.
19. This Credit sets forth in full the terms of our undertaking. Such undertaking shall not in any way be modified, amended or amplified by reference to any document or instrument referred to herein or in which this Credit is referred to or to which this Credit relates and any such reference shall not be deemed to incorporate herein by reference any document or instrument.

[Name of financial institution]

By: _____
Name: _____
Title: _____

ATTACHMENT A

IRREVOCABLE STANDBY LETTER OF CREDIT NO. [**Number issued by financial institution**]
CERTIFICATE FOR DRAWING

To:

[Name and address of financial institution]

Re: Incidental Take Permit No. [**permit number**]

The undersigned, a duly Authorized Representative of the California Department of Fish and Wildlife ("CDFW"), as defined in paragraph 12 in the above-referenced Irrevocable Standby Letter of Credit ("Credit"), hereby certifies to the Issuer that:

1. **[Insert one of the following statements:** "In the opinion of the CDFW, the Applicant has failed to complete the Mitigation Requirements referenced in paragraph 3 of the Credit." **or** "As set forth in paragraph 13, the Issuer has informed the CDFW that the Credit will not be extended and the Applicant has not provided the CDFW with an equivalent security approved by the CDFW to replace the Credit."]
2. The undersigned is authorized under the terms of the Credit to present this Certificate as the sole means of demanding payment on the Credit.
3. The CDFW is therefore making a drawing under the Credit in amount of U.S. \$_____.
4. The amount demanded does not exceed the Principal Sum of the Credit.

Therefore, the CDFW has executed and delivered this Certificate as of the ___ day of _____, _____.

CALIFORNIA DEPARTMENT OF FISH AND WILDLIFE

BY: _____

[Insert one of the following: "DIRECTOR" or "GENERAL COUNSEL" or "REGIONAL MANAGER, [NAME OF REGIONAL OFFICE]"

ATTACHMENT B

IRREVOCABLE LETTER OF CREDIT NO. [*Number issued by financial institution*]
CERTIFICATE FOR CANCELLATION

To:

[Name of financial institution and address]

Re: Incidental Take Permit No. [*permit number*]

The undersigned, a duly Authorized Representative of the California Department of Fish and Wildlife ("CDFW"), as defined in the paragraph 12 in the above-referenced Irrevocable Standby Letter of Credit ("Credit"), hereby certifies to the Issuer that:

1. **[Insert one of the following statements:** "The Applicant has presented documentary evidence of full compliance with the Mitigation Requirements referenced in paragraph 3 of the Credit." **or** "The natural expiration of this Credit has occurred."]
2. The CDFW therefore requests the cancellation of the Credit.

Therefore, the CDFW has executed and delivered this Certificate for Cancellation as of the ____ day of _____, _____.

CALIFORNIA DEPARTMENT OF FISH AND WILDLIFE

BY: _____

[Insert one of the following: "DIRECTOR" or "GENERAL COUNSEL" or "REGIONAL MANAGER, [NAME OF REGIONAL OFFICE]"

State of California - Department of Fish and Wildlife
MITIGATION PAYMENT TRANSMITTAL FORM
 DFW 1057 (NEW 07/28/17)

Project Applicant Instructions: Please fill out and attach this form to payment. For conservation banks, also attach the Bill(s) of Sale for credits sold. One form may be used for multiple transactions, **BUT YOU MUST USE A SEPARATE FORM FOR EACH CHECK YOU TRANSMIT.** Make sure to include Project Name, Project Tracking Number, and ASB Mitigation Tracking Number (if available) on the attached payment type.

1. DATE: _____ TO: _____ Regional Manager _____ Region Office Address	2. FROM: _____ Name _____ Mailing Address _____ City, State, Zip _____ Telephone Number/FAX Number
---------------------------------------------------------------------------------------------------------	--------------------------------------------------------------------------------------------------------------------------------------------

3. RE: _____
 Project Name as appears on permit/agreement

4. AGREEMENT/ACCOUNT INFORMATION: (check the applicable type)

2081 Permit
 Conservation Bank
 2835 NCCP
 1802 Agreement
 1600 Agreement
 Other _____

Project Tracking Number

5. PAYMENT TYPE (One check per form only): The following funds are being remitted in connection with the above referenced project:

Check information:

Total \$ _____ Check No. _____

Account No. _____ Bank Routing No. _____

a. Endowment: for Long-Term Management Subtotal \$ _____

b. Habitat Enhancement Subtotal \$ _____

c. Security:

1. Cash Refundable Security Deposit Subtotal \$ _____

2. Letter of Credit Subtotal \$ _____

1. Financial Institution: _____

2. Letter of Credit Number: _____

3. Date of Expiration: _____

ACCOUNTING OFFICE USE ONLY	
Description	FISCal Coding
Speedchart (Project, Program, Reference, Fund)	
Reporting Structure	
Category	
Date Established: _____	By: _____

