Planning file number **PLP19-0009**



HYATT PLACE HOTEL

AIRPORT BOULEVARD AND NORTH LAUGHLIN ROAD SANTA ROSA, CA 95403 02.01.2021 - USE PERMIT RESUBMITTAL - EP






PROPOSED HYATT PLACE HOTEL

3750 NORTH LAUGHLIN ROAD, SANTA ROSA, CA 95403

ABBREVIATIONS ABOVE FINISHED FLOOR MANUFACTURER ACOUSTICAL **ADJUSTABLE** MEZZ MEZZANINE ALIGN MIN MINIMUM ALTERNATE **MISCELLANEOUS** ANCHOR BOLT MOUNTED MULLION ARCHITECTURAL AUTOMATIC NEGATIVE BUILDING NOMINAL NOT IN CONTRACT BLOCKING NOT TO SCALE BOARD **BOTTOM OF** BOTH SIDES ON CENTER OUTSIDE DIAMETER CABINET CBC CALIFORNIA BUILDING CODE OPP OPPOSITE CI CAST IN PLACE **PARTITION** PARTIAL PENETRATION CENTER LINE POWDER ACTUATED FASTENER CENTER TO CENTER PLASTIC LAMINATE CERAMIC CONSTRUCTION JOINT PLATE NAILING PLYWD PLYWOOD CONCRETE MASONRY UNIT COMP COMPACT POUND CONNECTION PRESSURE CONTINUOUS COMPLETE PENETRATION QUALITY COUNTERSUNK QUANTITY COLD WATER CUBIC YARDS PRESSURE/ PRESERVATIVE TREATED DET PRESTRESSED DEPARTMENT

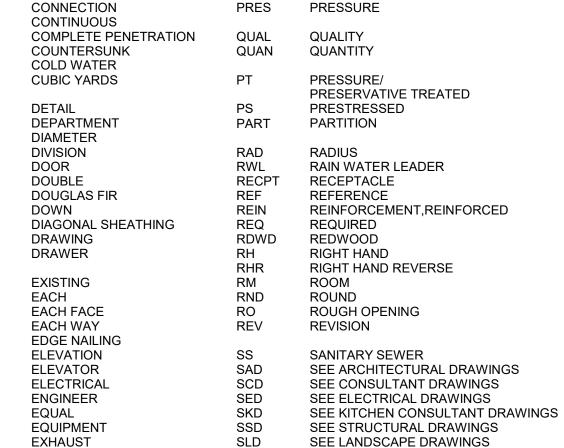

SEE MECHANICAL DRAWINGS

SEE PLUMBING DRAWINGS

SCHEDULE, SCHEDULE

SEISMIC JOINT

SPECIFICATION

SQUARE FOOT

STAINLESS STEEL

SECTION

SHEET SHEET METAL

SIMILAR

SQUARE

STRAP TIE

STAGGERED

STANDARD

STORAGE

SYSTEM

TEMPERED

TIE DOWN

THICKNESS THREADED

TOP AND BOTTOM

TOP OF CONCRETE

TOP OF FINISH

TOP OF PLATE

TOP OF STEEL

TOP OF WALL

TRUE NORTH

UTILITY, UTILITIES

VERIFY IN FIELD

WATER CLOSET

WATER HEATER

TYPICAL

VERTICAL

VESTIBULE

WITH OUT

WOOD

VERIFY

VER

W/

W/O

WD

VEST

TONGUE AND GROOVE


UNDER WRITERS LABORATORY UNLESS OTHERWISE NOTED

STRUCTURAL

SUSPENDED

SYMMETRICAL

SPACE

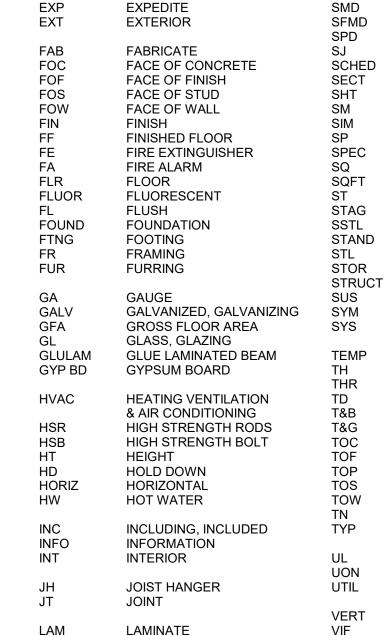

LEFT HAND

LIGHT WEIGHT

MACHINE BOLTS

MAINTENANCE


MAXIMUM

MECHANICAL

LEFT HAND REVERSE

PARCEL MAP



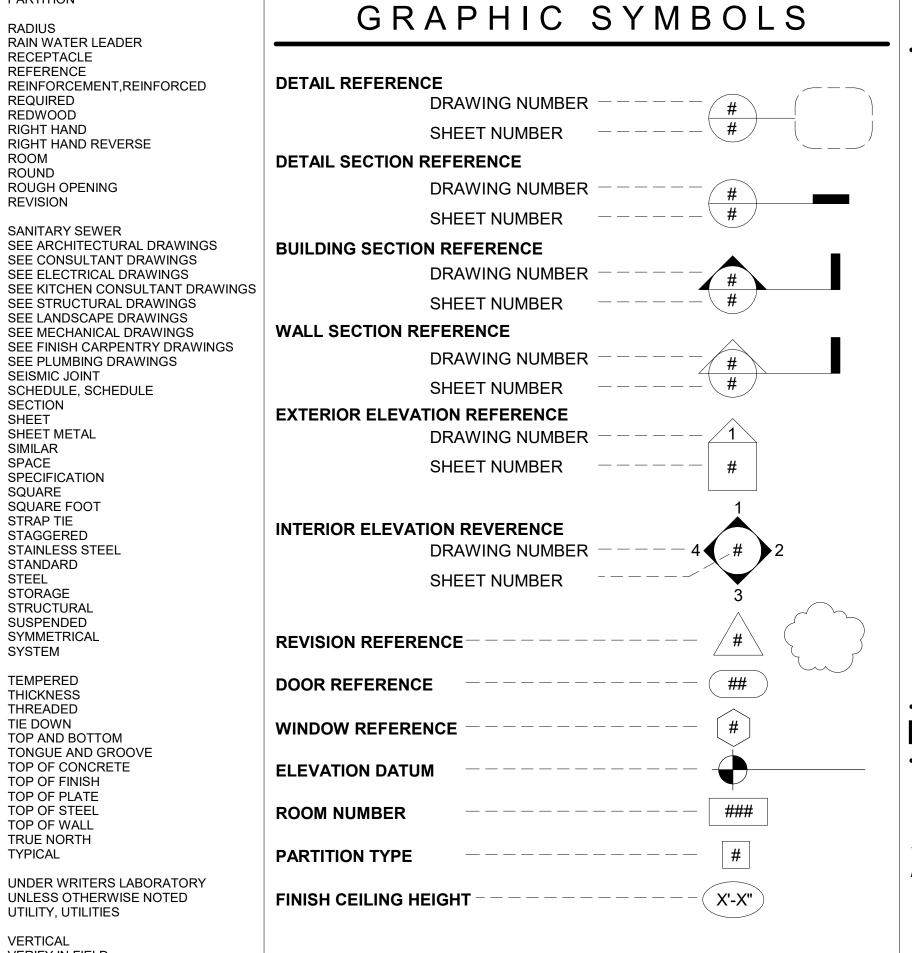

PROJECT DIRECTORY

PROJECT CSW LAND, LLC **OUTREACH:** PO BOX 921 SANTA ROSA, CA 95402

ATTN: SCOTT SCHELLINGER SCOTT@CSWLAND.COM 707.921.5030

OWNER: LANDMARK HOTELS GROUP 1520 RAILROAD AVENUE ST HELENA, CA 94574 SHAWN SWEENEY

ARCHITECT: LOWNEY ARCHITECTURE 360 17TH STREET, SUITE 200 OAKLAND, CA 94612 ATTN: ERIC PRICE 510.836.5400

510.836.5454 (FAX)

ERIC@LOWNEYARCH.COM

LANDSCAPE LOWNEY ARCHITECTURE 360 17TH STREET, SUITE 200 DESIGNER: OAKLAND, CA 94612

> 510.836.5400 510.836.5454 (FAX) JENNIFER@LOWNEYARCH.COM

ATTN: JENNIFER IVANOVICH

ENGINEER:

ALWAYS ENGINEERING, INC. 131 STONY CIR #1000 SANTA ROSA, CA 95401 ATTN: BEN MONROE, P.E., QSD/QSP 707.542.8795 x 17 BENM@ALWAYSENG.COM


STRUCTURAL **ENGINEER:**

DCI ENGINEERS ONE POST STREET, SUITE 1050 SAN FRANCISCO, CA 94104 415.781.1505

21795 HIGHWAY 99 LYNNWOOD, WA 98036 ATTN: JOHN TOMAN, P.E. 425.741.1200 JTOMAN@EMERALDCITYENG.COM

EMERALD CITY ENGINEERS. INC

PROJECT LOCATION

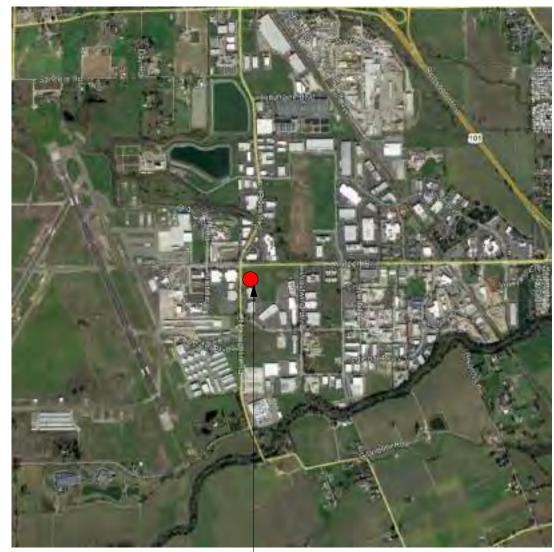



PROJECT LOCATION

PROJECT SCOPE

THE PROPOSED HOSPITALITY PROJECT INCLUDES NEW SURFACE PARKING, MULTI-STORY BUILDING WITH ROOF DECK AND A SEPARATE TRASH ENCLOSURE. THE BUILDING'S PROPOSED USE IS LIMITED SERVICE HOTEL WITH A (SEPARATE) RESTAURANT TENANT. THE PROJECT PROPOSES ADDITIONAL OFF-SITE SURFACE PARKING IN ADDITION TO THAT PROVIDE ON THE BUILDING'S PARCEL.

> THE BUILDING STRUCTURES INCLUDE SIX (6) STORY HOTEL WITH RESTAURANT ON THE SIXTH FLOOR, PORTE COCHERE BUILDING OVERHANG FACING WESTERLY TOWARD NORTH LAUGHLIN AND SEPARATE TRASH ENCLOSURE AT THE NORTHEAST. THE NORTHWEST CORNER OF THE BUILDING INCLUDES A SINGLE STORY INDOOR POOL AREA WHICH OPENS TO AN OUTDOOR LANDSCAPED AREA. OUTDOOR SEATING AREAS ARE INCLUDED AT BOTH THE EAST AND WEST SIDES OF THE BUILDING. THE PROJECT ANTICIPATES MOST MECHANICAL EQUIPMENT WILL BE LOCATED AT THE ROOFTOP AND SCREENED.

PRIVATE PARKING AGREEMENT AT THE EAST SIDE OF THE BUILDING.

DRAWING LIST

DRAWING LIST				
SHEET NUMBER	SHEET NAME			
01 GENERAL				
G0.0	COVER SHEET			
G0.1	INDEX			
G0.2	PROJECT DATA			
00 01 /11				
02 CIVIL .UP1	OVERALL SITE PLAN			
.0P1 C1				
C2	PRELIMINARY GRADING PLAN PRELIMINARY DRAINAGE PLAN			
C3.1	EMERGENCY ACCESS PLAN ENTRY			
C3.2				
C3.2 C4	EMERGENCY ACCESS PLAN EXIT LEGEND AND ABBREVIATIONS			
H1	(E) IMPERVIOUS EXHIBIT			
H2	(P) EX 3 LID PLAN			
H3	NOTES AND DETAILS			
ПЗ	NOTES AND DETAILS			
03 ARCHITECT	URAL			
A0.1	AERIAL VIEW FROM THE SOUTHWEST			
A0.2	NORTHWEST VIEW FROM AIRPORT BOULEVARD			
A0.3	NORTHEAST VIEW FROM AIRPORT BOULEVARD			
A0.4	ENTERING THE SITE FROM NORTH LAUGHLIN ROAD			
A0.6	PERSPECTIVES			
A0.7	PERSPECTIVES			
A1.0	SITE PLAN			
A1.1	LEVEL 1			
A1.2	LEVEL 2			
A1.3	LEVEL 3			
A1.4	LEVEL 4			
A1.5	LEVEL 5			
A1.6	LEVEL 6			
A1.7	ROOF PLAN			
A2.1	EXTERIOR ELEVATIONS			
A2.2	EXTERIOR ELEVATIONS			
A2.3	MATERIAL PALETTE			
A3.1	BUILDING SECTION			
A3.2	BUILDING SECTIONS			
A3.3	ROOM TYPES			
A3.4	ROOM TYPES			
04 LANDSCAPI	Ē			
L1.0	MATERIAL PALETTE			
L1.1	LANDSCAPE MATERIALS			
L1.2	TREE REMOVAL			
L1.3	PLANTING ZONES			
	HYDROZONE PLAN			

DEFERRED SUBMITTALS

- JOINT TRENCH FIRELINE CONNECTION AND DEVICES SIGNAGE
- * ALL DEFERRED APPROVAL SUBMITTALS ARE SUBJECT TO LOCAL INSPECTION AND



LH

MB

MAINT

MECH



PROJECT DATA

GROSS FLOOR AREA

TOTAL GUEST ROOM COUNT

UNIT TYPE BY FLOOR | COUNT

LEVEL

6TH FLOOR

5TH FLOOR

4TH FLOOR

3RD FLOOR

2ND FLOOR

1ST FLOOR

TYPE K-A

TYPE K-B

TYPE K-C

TYPE K-D

TYPE K-DC TYPE K-E

TYPE Q-A

TYPE Q-B

TYPE Q-C

Grand total: 165

AREA

16,336 SF

19,035 SF

18,925 SF

18,925 SF

18,925 SF

24,426 SF

116,571 SF

75

13

4

50

14

3

UNIT TYPE BY FLOOR	COUN
LEVEL 1	
TYPE K-A	1
TYPE K-B	1
TYPE K-C	1
TYPE K-E	1
TYPE Q-A	2
TYPE Q-B	1
TYPE Q-C	1
LEVEL 1	8
2ND FLOOR	
TYPE K-A	17
TYPE K-B	3
TYPE K-D	1
TYPE Q-A	10
TYPE Q-B	3
TYPE Q-C	1
2ND FLOOR	35
3RD FLOOR	
TYPE K-A	17
TYPE K-B	3
TYPE K-C	1
TYPE K-D	1
TYPE Q-A	10
TYPE Q-B	3
3RD FLOOR	35
4TH FLOOR	
TYPE K-A	17
TYPE K-B	2
TYPE K-D	1
TYPE Q-A	12
TYPE Q-B	2
TYPE Q-C	1
4TH FLOOR	35
5TH FLOOR	00
TYPE K-A	17
TYPE K-B	2
TYPE K-C	1
TYPE K-D	1
TYPE Q-A	12
TYPE Q-B	2
5TH FLOOR	35
6TH FLOOR	00
TYPE K-A	6
TYPE K-B	2
TYPE K-C	1
	1
TYPE C. A	-
TYPE Q-A	4
TYPE Q-B	3
6TH FLOOR	17
Grand total: 165	165

BUILDING INFORMATION

BUILDING ADDRESS: 3750 NORTH LAUGHLIN ROAD SANTA ROSA, CA 95403

NUMBER OF STORIES: (6) STORIES

ALLOWABLE HEIGHT: 50' (28' TO 40' VARIABLE WITHIN SETBACKS)

PROPOSED HEIGHT: 75'-0" (EXCLUDING MECHANICAL EQUIPMENT SCREENING)

CONSTRUCTION TYPE: TYPE III-A

SPRINKLERED: YES

OCCUPANCY CLASSIFICATION: A-3, R-2, M, B, S-2

DENSITY

ZONING	LOT AREA	ALLOWED	PROPOSED	ALLOWED	PROPOSED
DISTRICT		UNITS	UNITS	RETAIL AREA	RETAIL AREA
MP 2 AC AVG, VOH	4.18 ACRES 79,817 S.F.	N/A	(175) MAXIMUM	N/A	4,000 MAXIMUM

ZONING INFORMATION

ASSESSOR'S PARCEL #: 059-370-022

ZONING DISTRICT: MP 2 AC AVG, VOH

CURRENT LAND USE: (LI) LIMITED INDUSTRIAL

LISTED REQUIRED USE HOTEL AND RESTAURANT PERMITS:

LOT DEVELOPMENT STANDARDS

LOT AREA: 182,081 SF (4.18 ACRES)

GFA (EXCLUDING PARKING): 79,817 SF

PROPOSED LOT COVERAGE: 13.4% (SEE ABOVE)
ALLOWABLE LOT COVERAGE: 50% ALLOWED

SETBACKS*

FRONT: 40' AVERAGE, 25' MINIMUM INTERIOR SIDE: 10'

STREET SIDE 10'
REAR: 10'

PROPOSED AVG 34' AVG (65% OF LOT WIDTH HAS NO BUILDING)
PROPOSED MIN 31' MIN

*SPECIAL YARD REQUIREMENTS 60' AVG

55' MIN ALONG AIRPORT BOULEVARD RIGHT-OF-WAY

(NOT PROPERTY LINE)

PARKING INFORMATION

	REQUIRED*	PROVIDED	NOTES
HOTEL (LODGING)	PER TRAFFIC/PARKING STUDY*	196	
COMMERCIAL "(RESTAURANT)"	PER TRAFFIC/PARKING STUDY*	25	
MEETING/ CONFERENCE	PER TRAFFIC/PARKING STUDY*	0	
TOTAL	(177)	(211)	

*SEE W-TRANS PARKING ANALYSIS

BICYCLE PARKING INFORMATION

	REQUIRED	PROVIDED	COMPLIANT
HOTEL (LODGING)	18 = 1 + (165 / 10) (1 SPACE + 1 PER 10 ROOMS)	18	YES
COMMERCIAL "(RESTAURANT)"	1 (1 PER 4,000 SF)	1	YES
MEETING/ CONFERENCE	1 (1 PER 4,000 SF)	1	YES
TOTAL	20	20	

THE PROPOSED PROJECT SEEKS A USE PERMIT FROM THE COUNTY OF SONOMA. THE PROPOSED PROJECT REQUIRES DEVIATION FROM SOME COUNTY GUIDELINES AND STANDARDS ASSOCIATED WITH THE COUNTY MUNICIPAL CODE AND AIRPORT SPECIFIC PLAN. PERSUANT TO THAT PERMIT APPLICATION, THE PROPOSED DESIGN SEEKS TO MEET THE INTENT OF THE COUNTY REQUIREMENTS TO THE MAXIMUM EXTENT POSSIBLE WHILE ADHERING TO THE NEEDS OF THE PROPOSED USE(S). SEE ALSO FURTHER DETAIL IN THE PROJECT APPLICATION NARRATIVE.

SIGNAGE

ALLOWABLE

PER SECTION D.SIGNS - SONOMA COUNTY AIRPORT INDUSTRIAL AREA SPECIFIC PLAN

1. SIGNS TO IDENTIFY INDUSTRIAL PARK DISTRICT/SUBDIVISION:

A. AT THE STREET ENTRANCE TO EACH INDUSTRIAL PARK DISTRIC/SUBDIVISION, ONLY ONE DETACHED SIGN ON EACH SIDE OF THE STREET SHALL BE PERMITTED.

B. SHALL BE LOW PROFILE, WALL TYPE SIGNS LESS THAN 6 FEET IN HEIGHT WITH MAXIMUM MESSAGE AREA OF APPROX. 75 SF.

C. SHALL BE LOCATED IN THE LANDSCAPE SETBACK AT LEAST 10 FEET FROM THE

STREET RIGHT-OF-WAY LINE.

3. MOUNTED BUSINESS IDENTIFICATION SIGNS:

A. ONE MOUNTED SIGN SHALL BE PERMITTED ON EACH STRUCTURE FOR THE PURPOSE OF IDENTIFYING THE OCCUPANT OF THE BUILDING.

B. MOUNTED SIGNS ATTACHED TO VERTICAL SURFACES OF A BUILDING OR BUILDING-ASSOCIATED WALL SHALL BE ALLOWED, WITH THE PROVISION THAT SUCH SIGNS APPEAR AS AN INTEGRAL PART OF THE OVERALL ARCHITECTURAL AND SITE DESIGN CONCEPT. SIGNS MATERIALS SHALL COMPLEMENT THOSE OF THE STRUCTURE OF WHICH THEY ARE ATTACHED. SUCH SIGNS SHALL BE EXTERNALLY ILLUMINATED. OCCUPANT SIGNS SHALL BE SCALED PROPORTIONATELY TO THE AMOUNT OF OVERALL SPACE WITHIN THE BUILDING. THE ATTACHED SIGN AREA SHALL NOT EXCEED THREE PERCENT (3%) OF THE TOTAL AREA OF THE WALLS ON ANY FACE OF THE BUILDING WHICH THEY ARE ATTACHED.

C. FASCIA AND ROOF SIGNS ARE NOT PERMITTED.

PROPOSED:

TOTAL SIGNAGE

LINEAR FOOT OF BUILDING FRONTAGE:

SOUTH OF DE ANZA BLVD. 179' - 10" SHARON DR. 146' - 8"

TOTAL SIGNAGE PER BUILDING FRONTAGE

ELEVATION EAST -

TOTAL SF OF ELEVATION: APPROX. 19,758 SF 3% SF OF ELEVATION ALLOWED FOR SIGNAGE: APPROX. 592.74 SF

SIGNAGE A. 143 SF (38' 4" X 3' 9") BUILDING MOUNTED

SIGNAGE B. 18 SF (13' 0" X 1' 5") BUILDING MOUNTED PROPOSED 161 SF

ELEVATION NORTH

TOTAL SF OF ELEVATION: APPROX. 6,116 SF 3% SF OF ELEVATION ALLOWED FOR SIGNAGE: APPROX. 183.48 SF

SIGNAGE E. 26 SF (5' 2" X 5' 2")

263 SF

SIGNAGE C. 123 SF (33' 0" X 3' 9") BUILDING MOUNTED SIGNAGE D. 114 SF (11' 0" X 10' 5") BUILDING MOUNTED

BUILDING MOUNTED

ELEVATION SOUTH

TOTAL SF OF ELEVATION: APPROX. 5,181 SF 3% SF OF ELEVATION ALLOWED FOR SIGNAGE: APPROX.155.43 SF

SIGNAGE F. 42 SF (6' 6" X 6' 6") BUILDING MOUNTED

ELEVATION WEST

TOTAL SF OF ELEVATION: APPROX. 19,758 SF

3% SF OF ELEVATION ALLOWED FOR SIGNAGE: APPROX. 592.74 SF


SIGNAGE G. 146 SF (21' 9" X 6' 9") BUILDING MOUNTED





DATE ISSUES & REVISIONS BY
1 02.26.2019 USE PERMIT SUBMITTAL EP
2 06.3.2019 USE PERMIT RESUBMITTAL EP
3 02.01.2021 USE PERMIT RESUBMITTAL EP






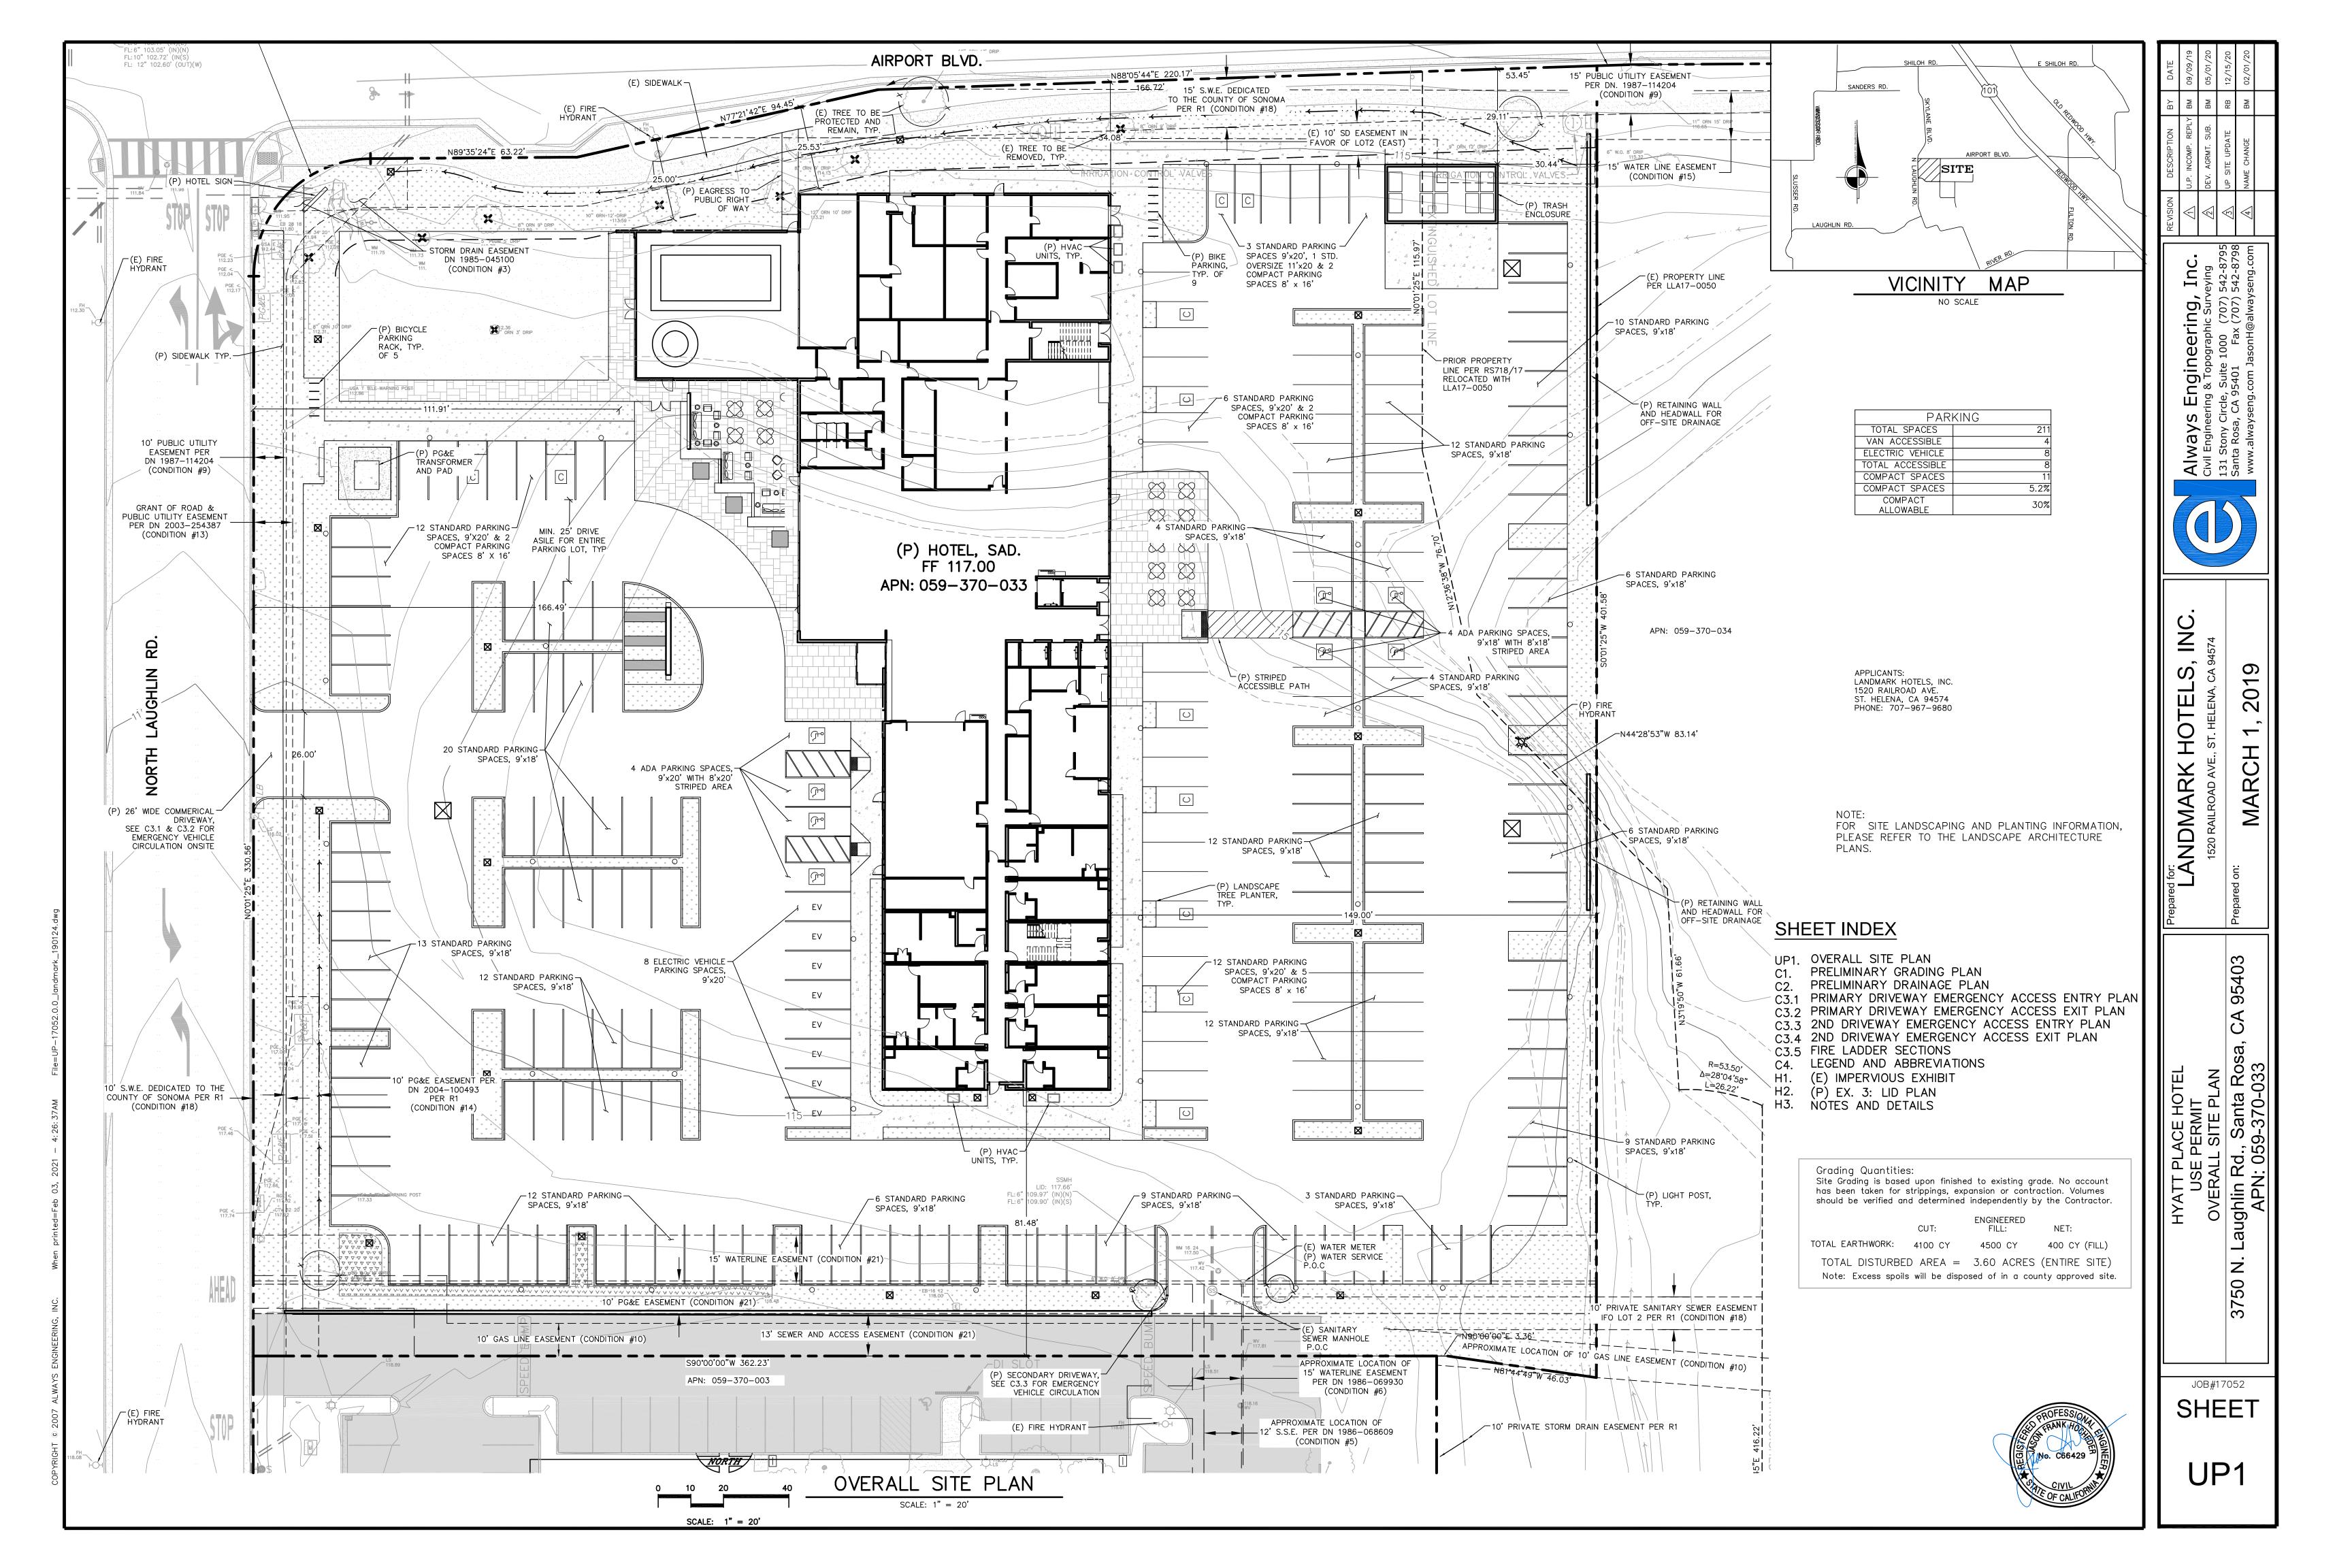


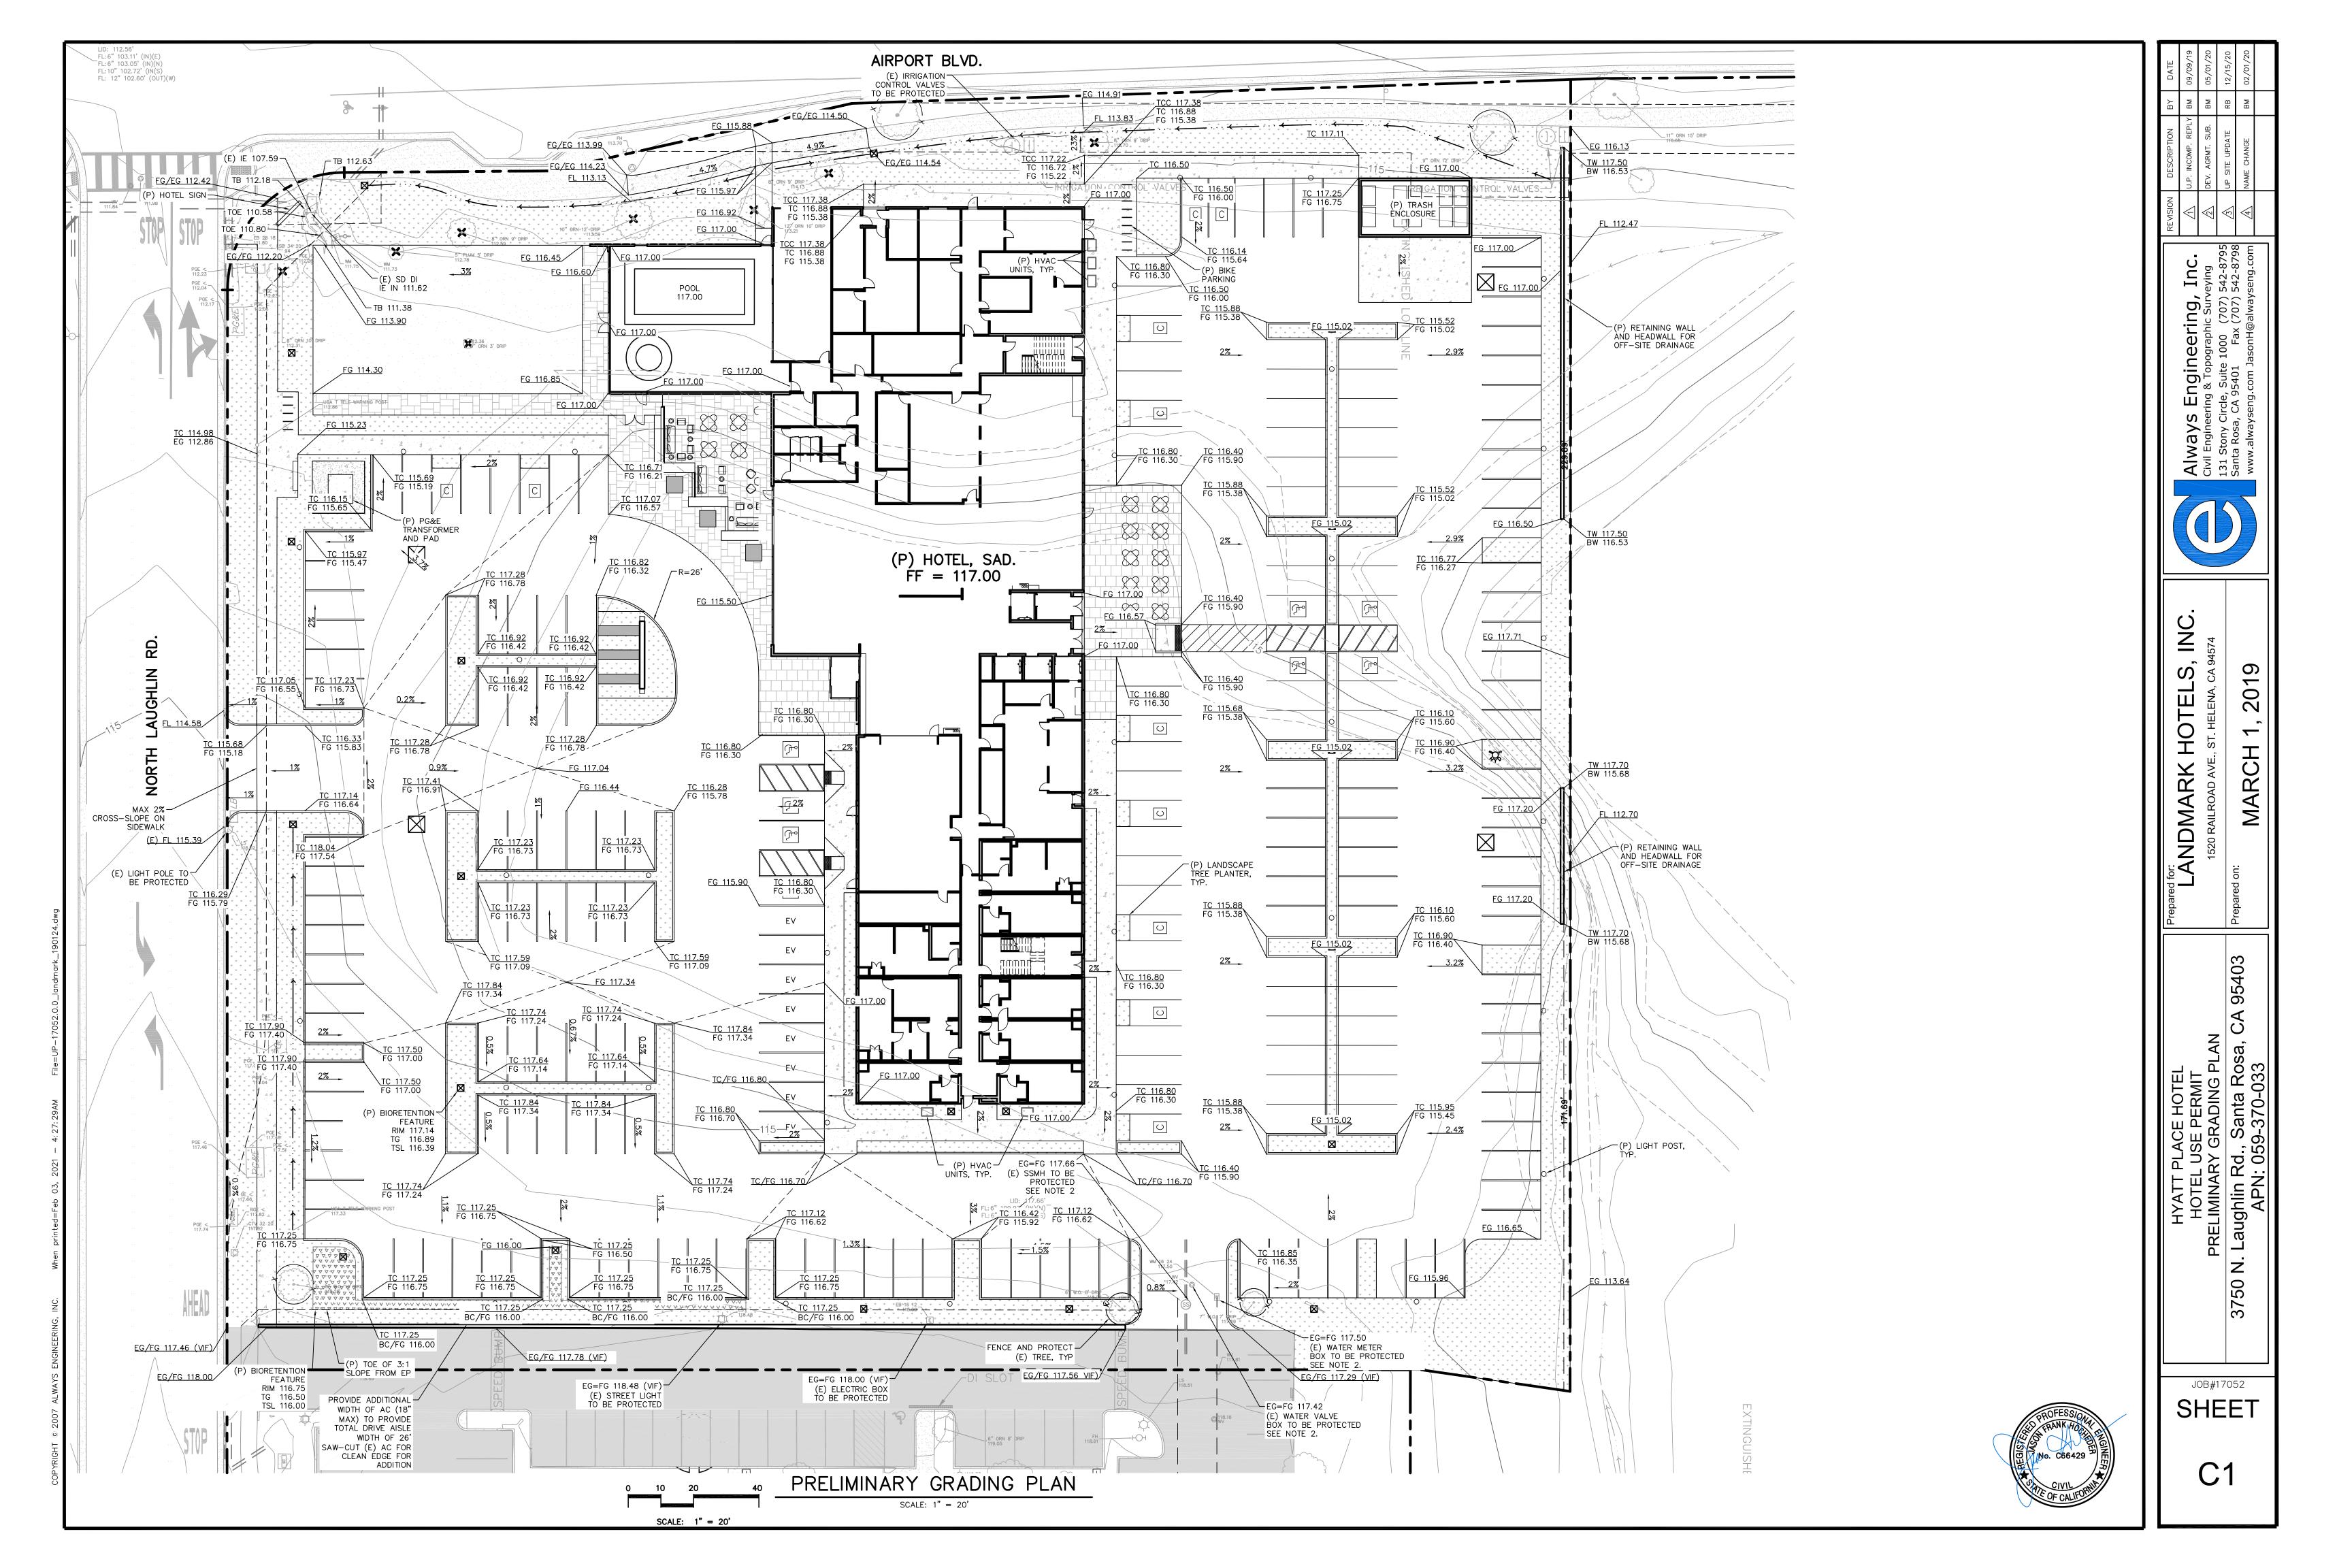

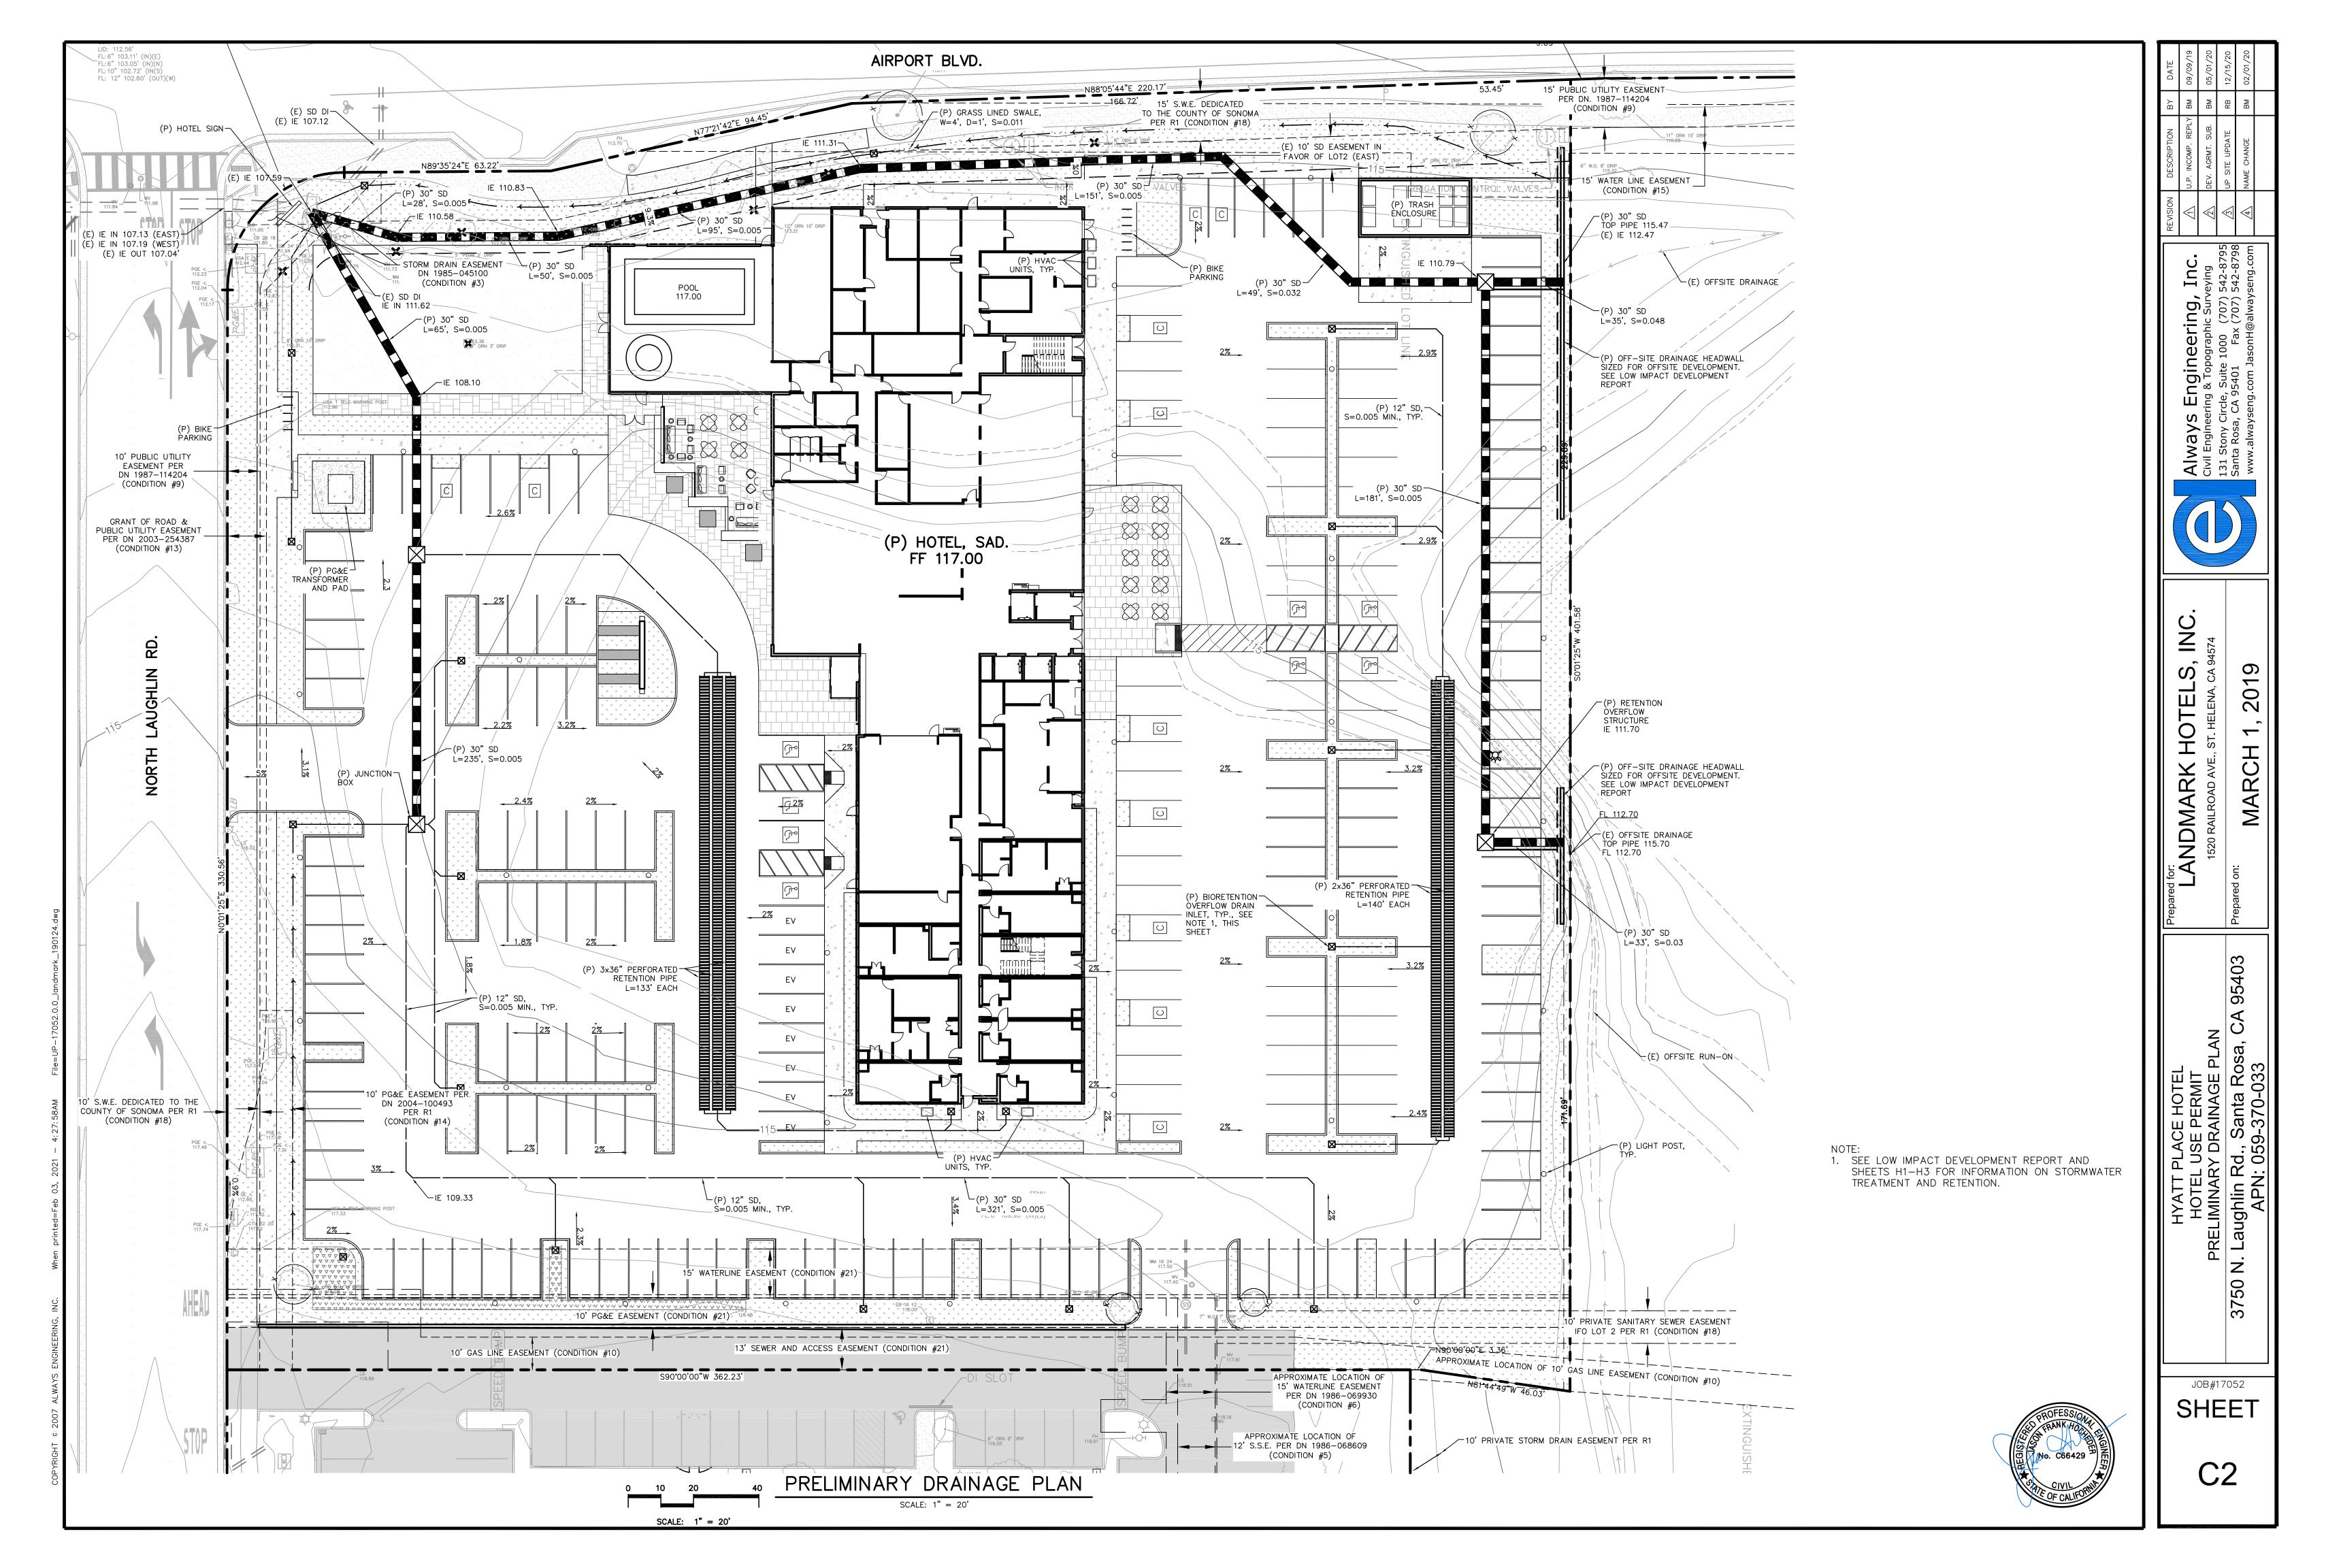

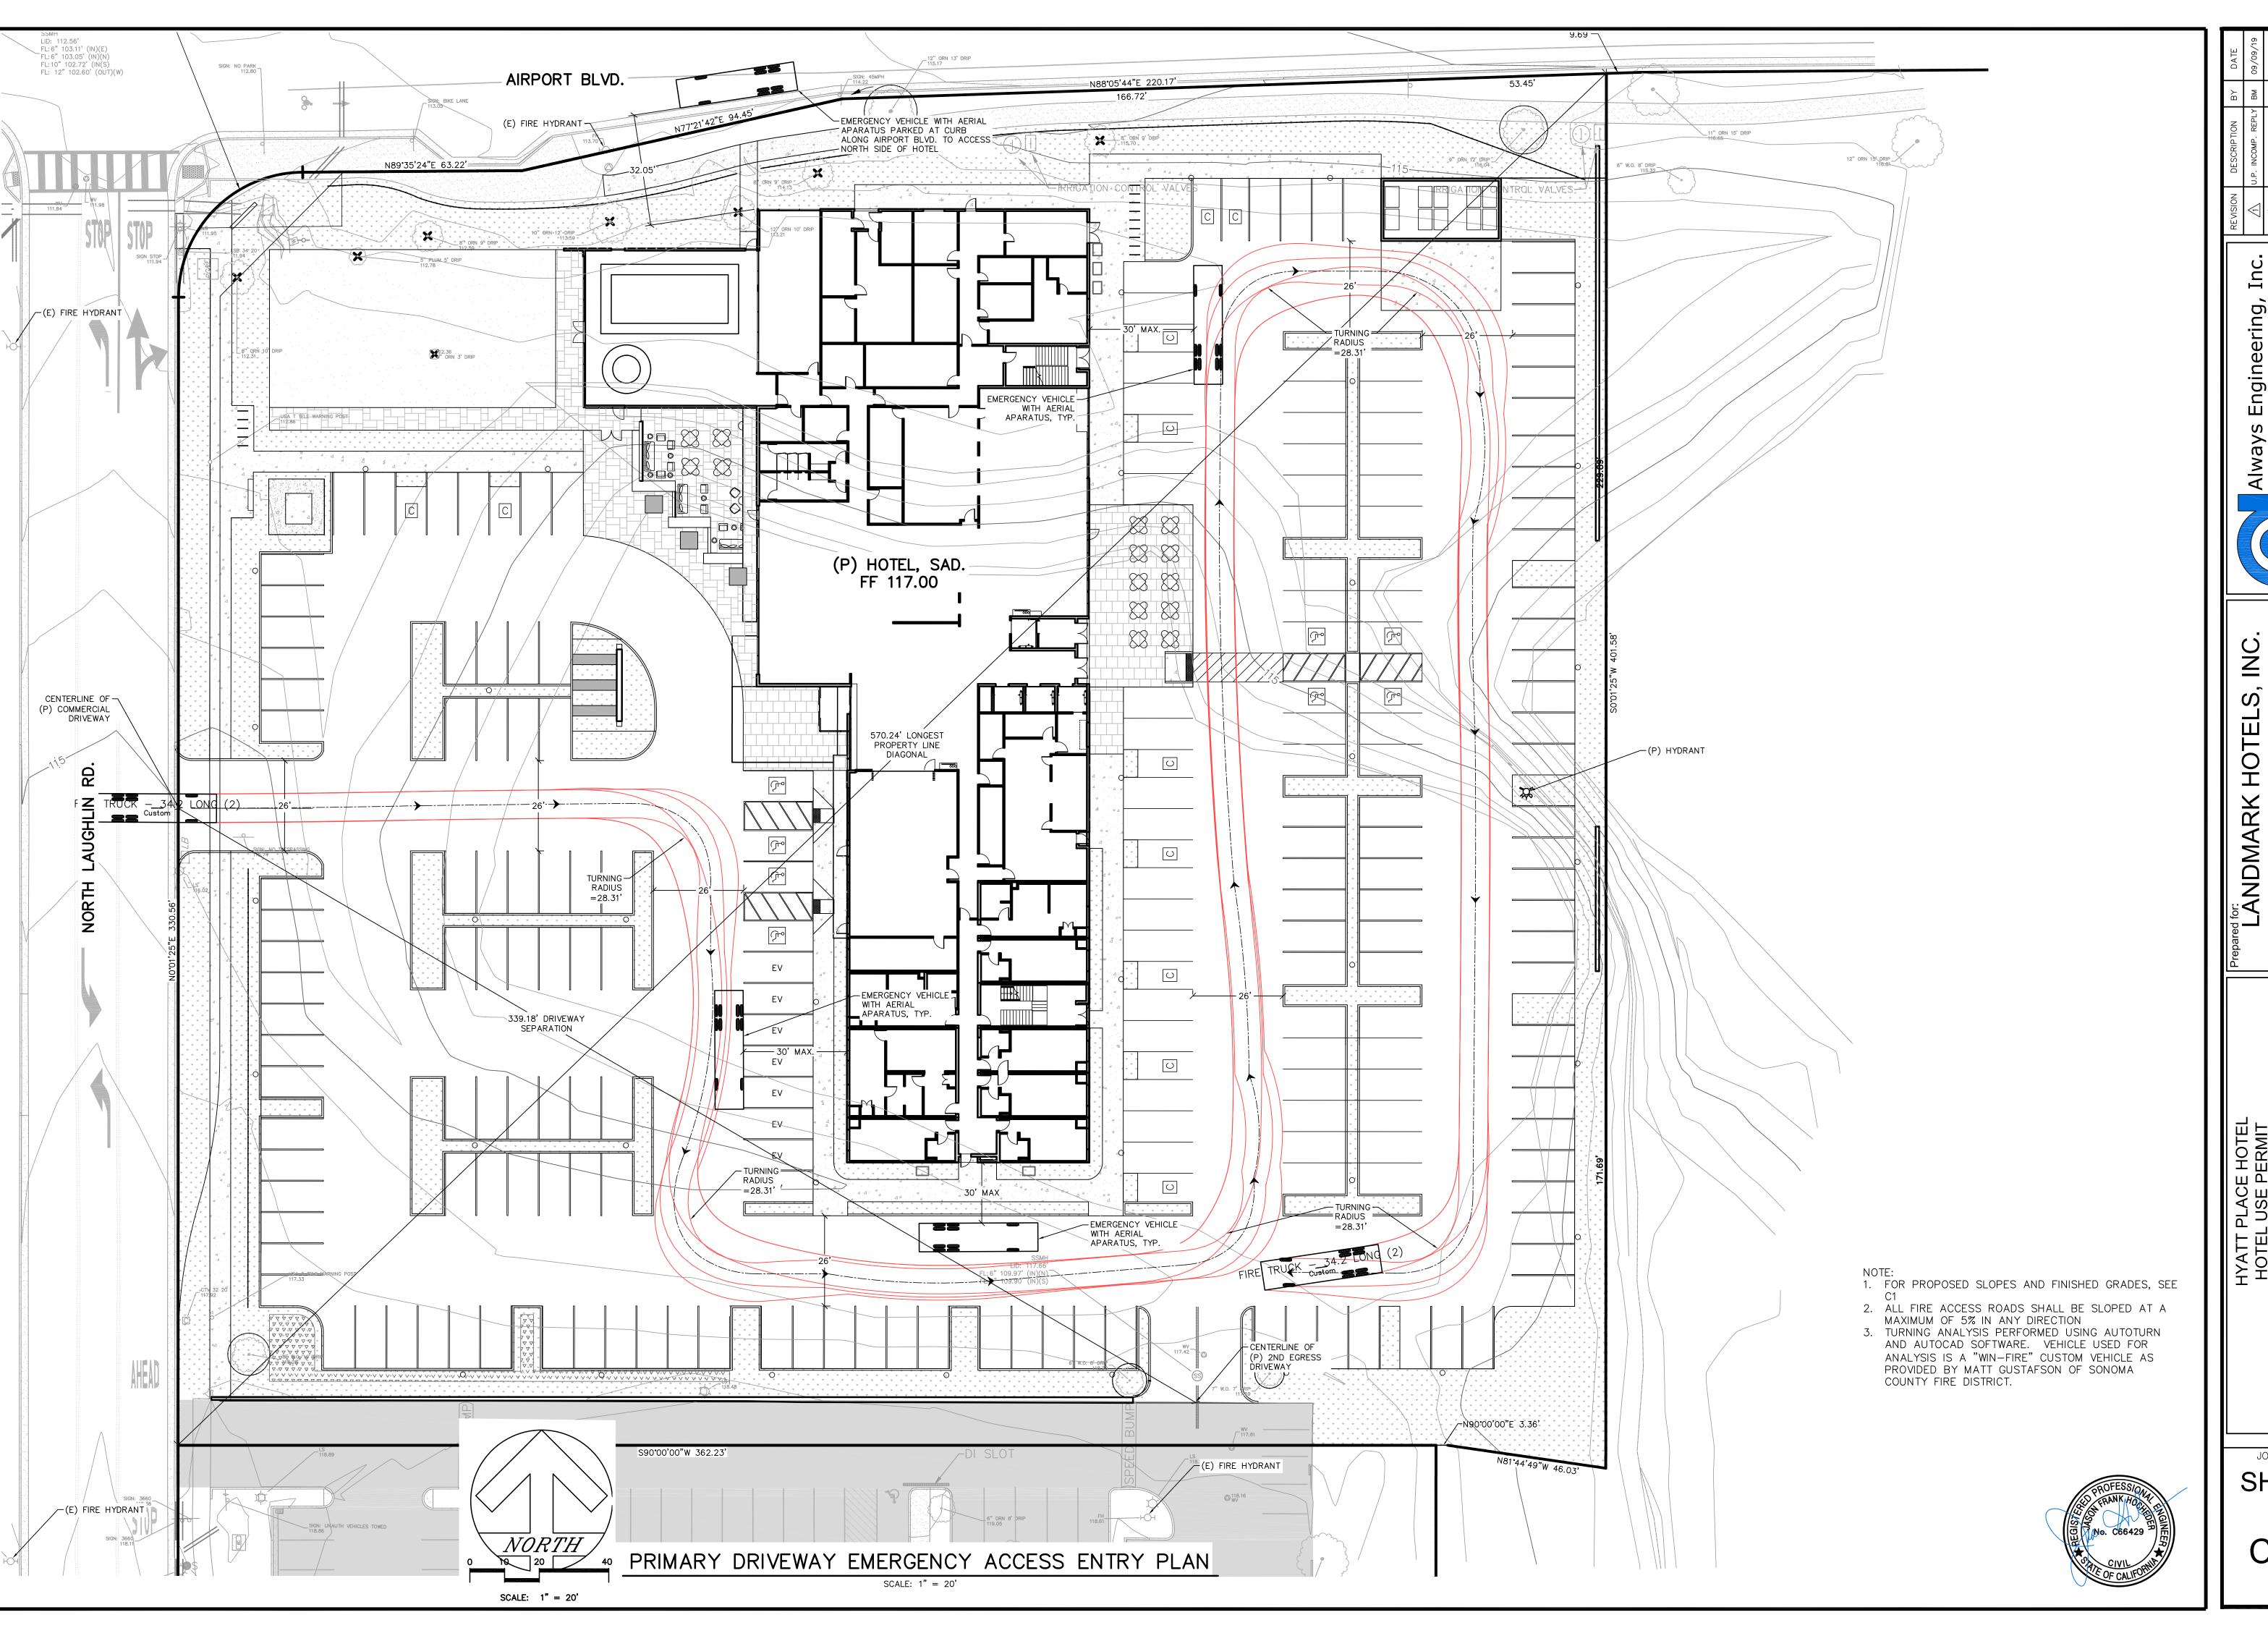

Engineering, ering & Topographic Surve Sircle, Suite 1000 (707) 5 CA 95401 Fax (707) 5

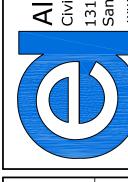

OTELS,


20

ENTRY PLAN , CA 95403

HYATT PLACE HOTEL
HOTEL USE PERMIT
SIVEWAY EMERGENCY ACCESS EI
J. Laughlin Rd., Santa Rosa, C
APN: 059-370-033 PRIMARY DRIV 3750 N. I

JOB#17052

SHEET

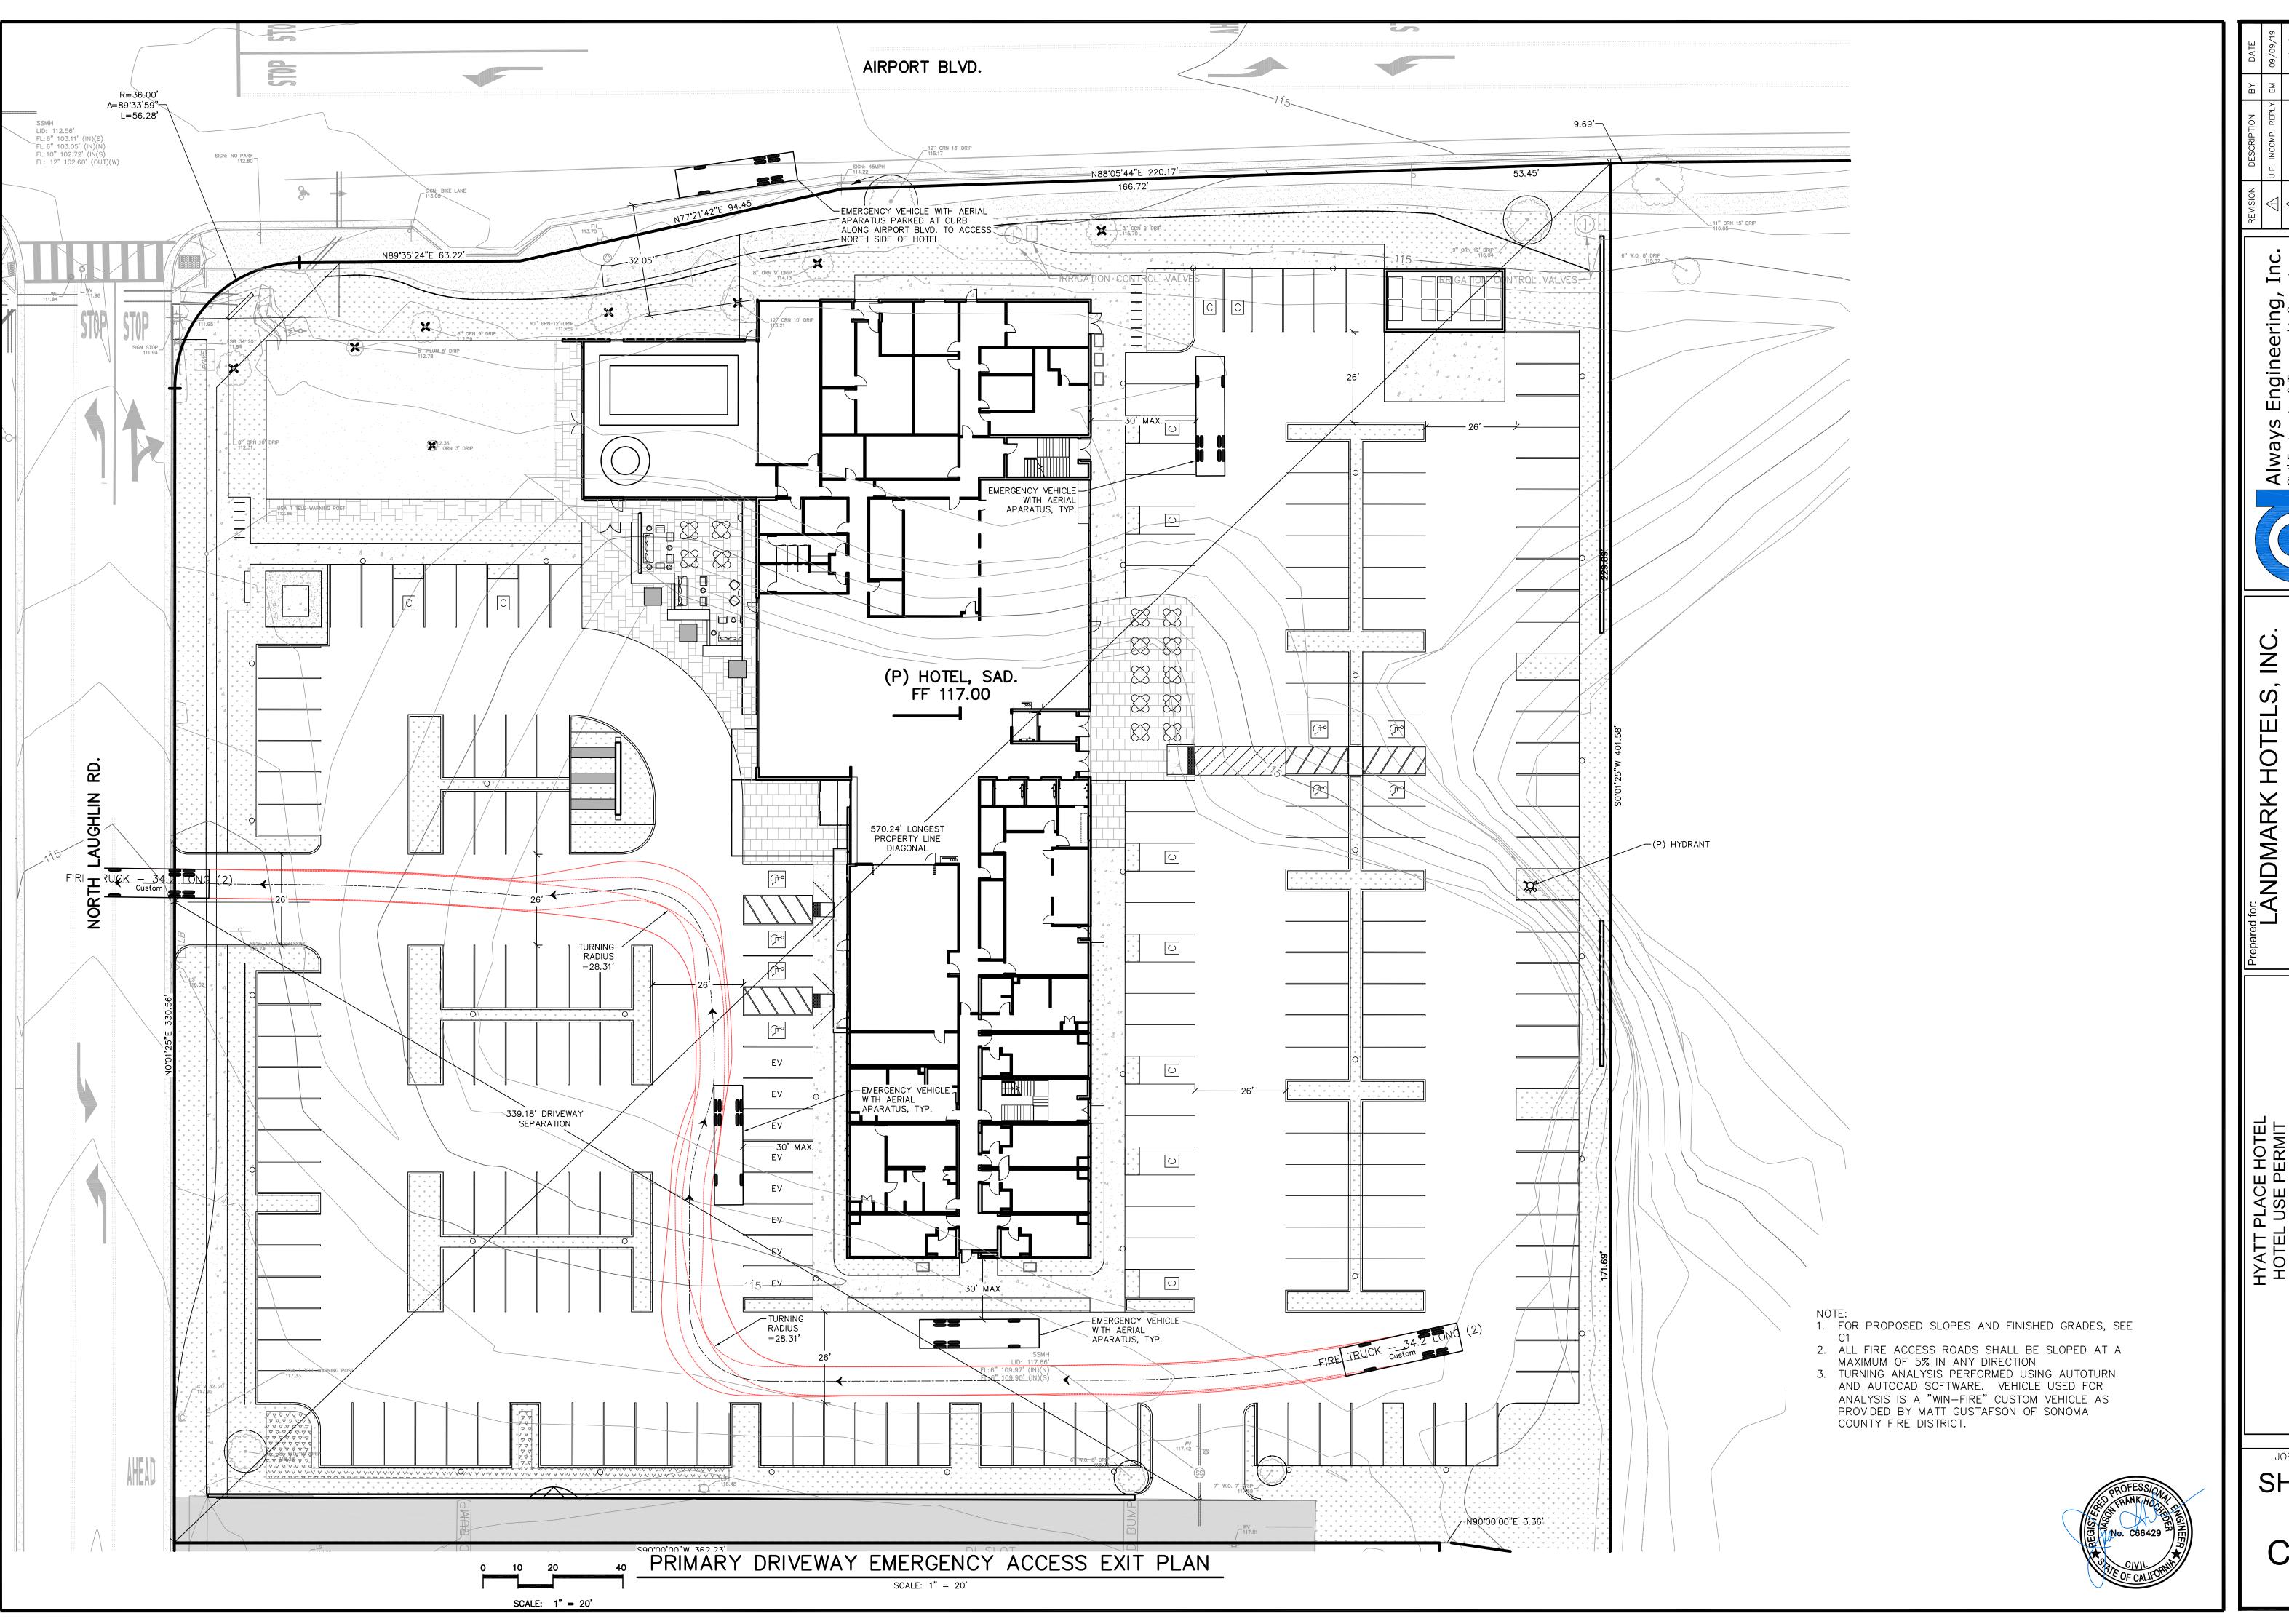


LAN EXIT 95403


PRIMARY I

JOB#17052

SHEET

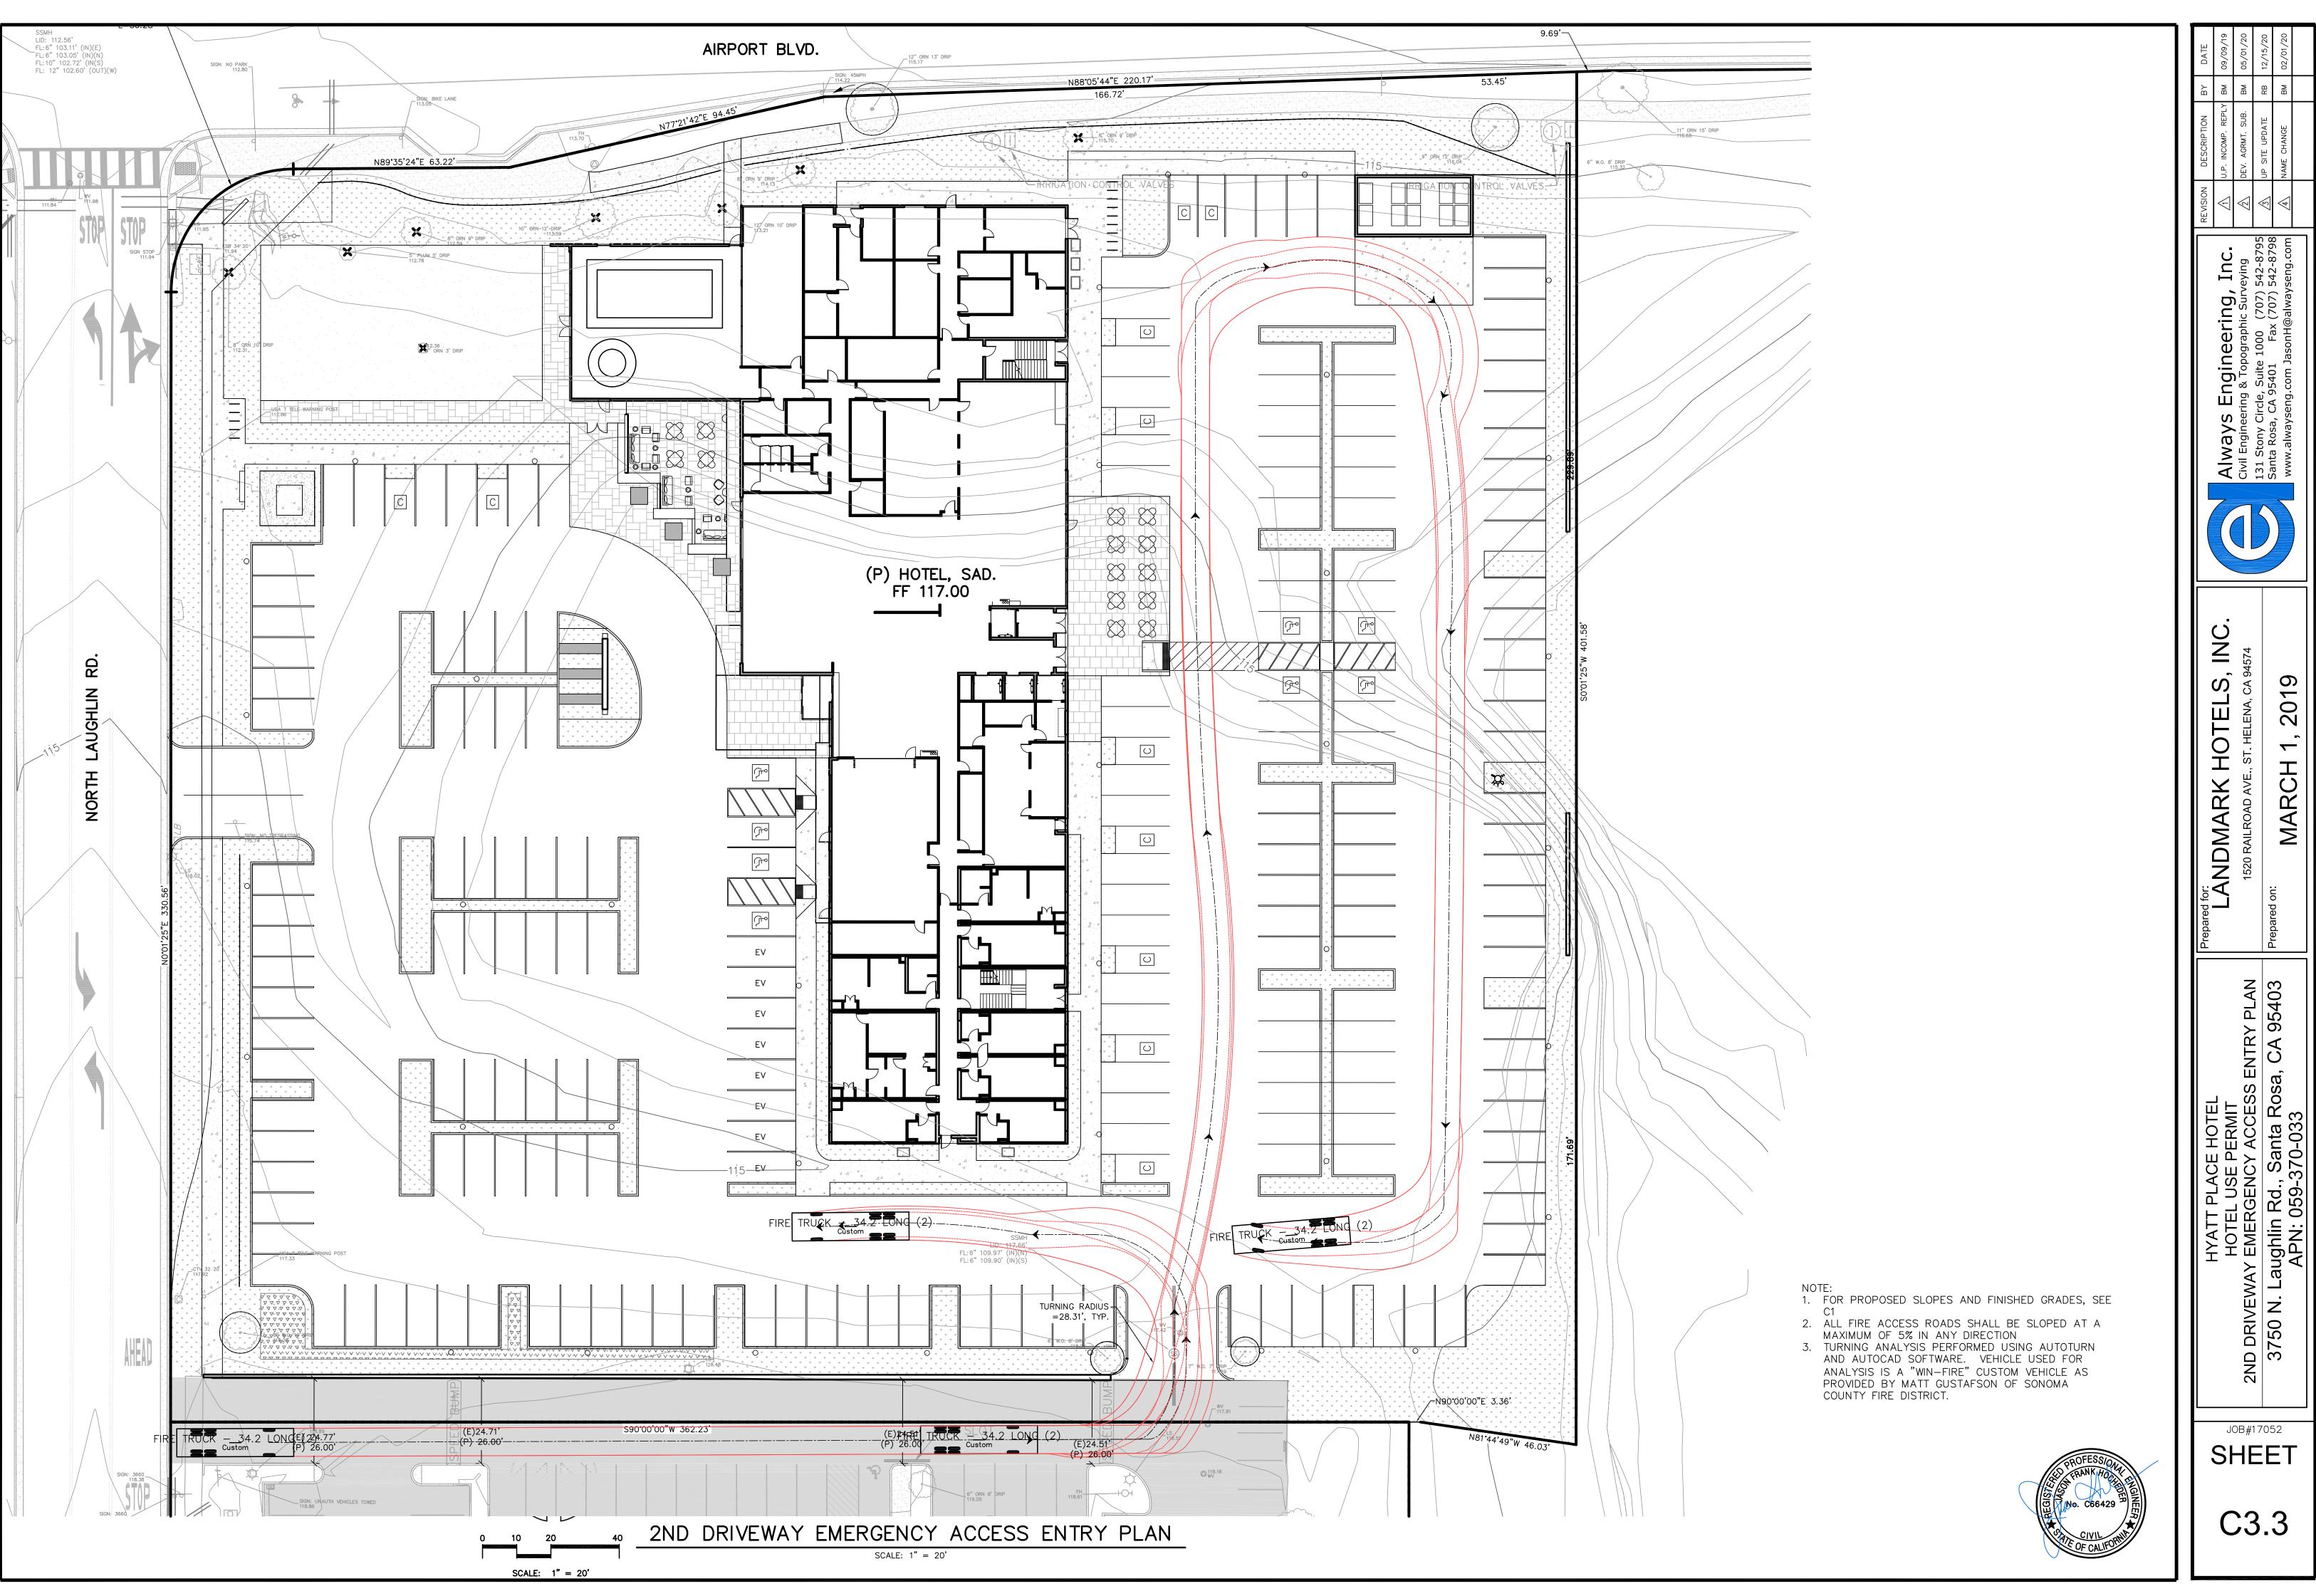

JOB#17052

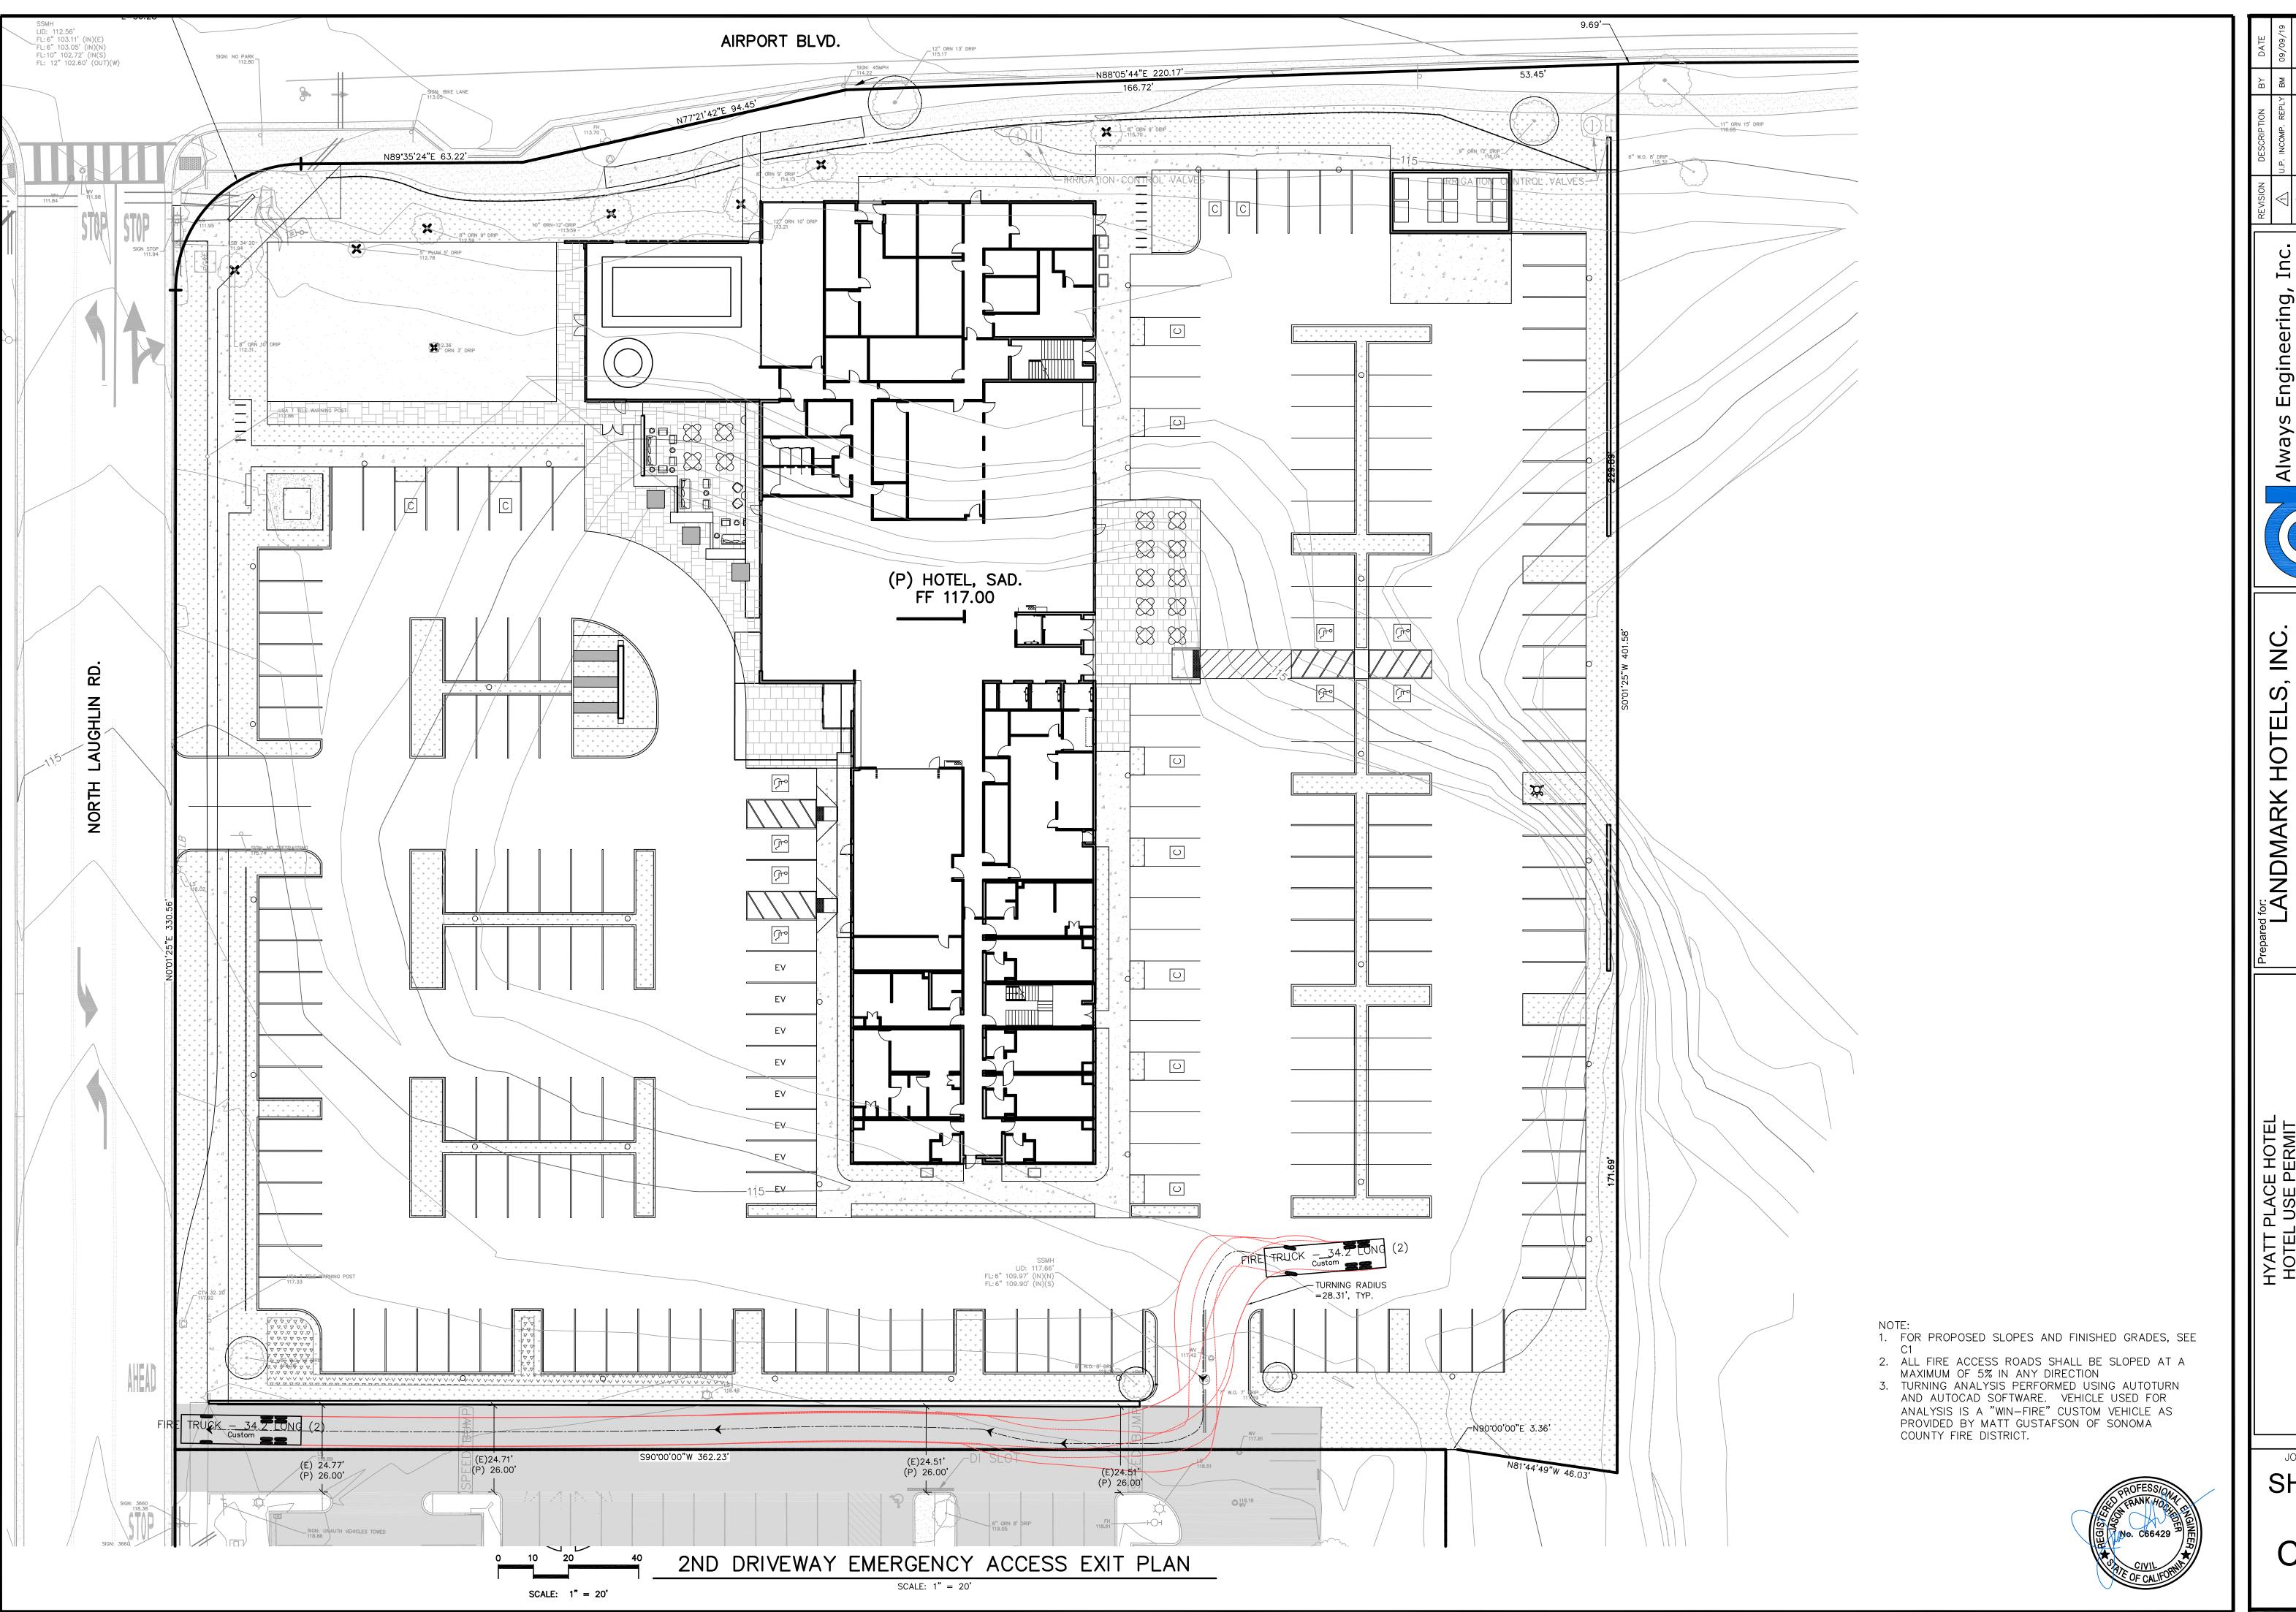

HOTELS


PLAN 95403

JOB#17052


2ND DRIVEV 3750 N. L


SHEET




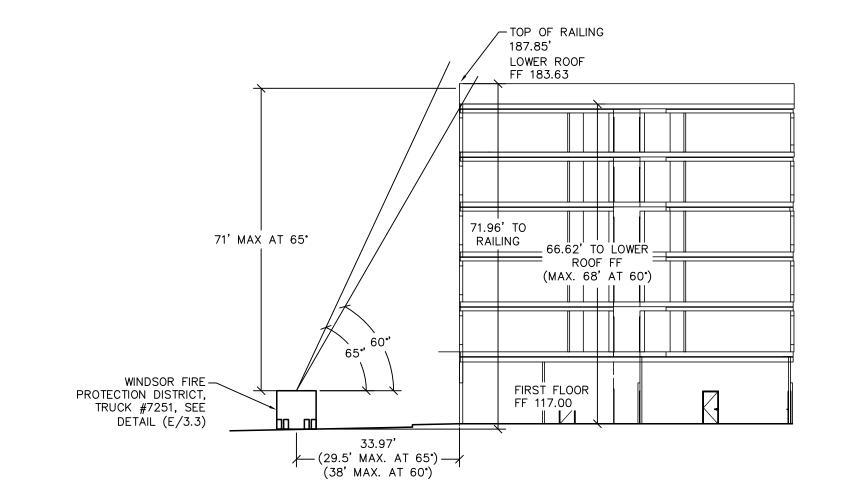




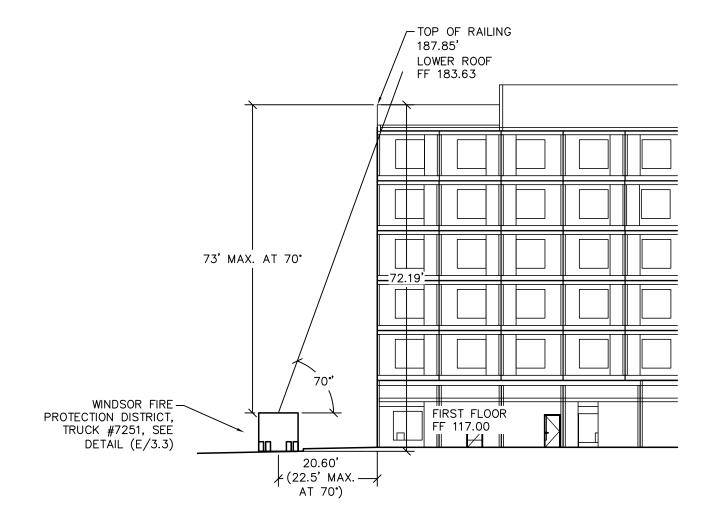

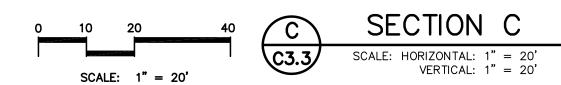

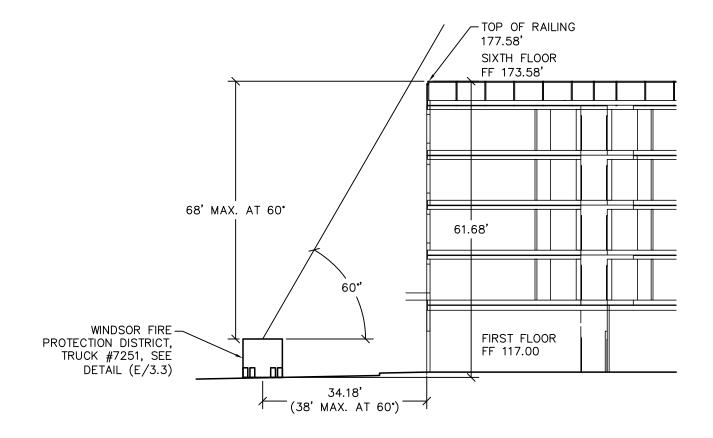



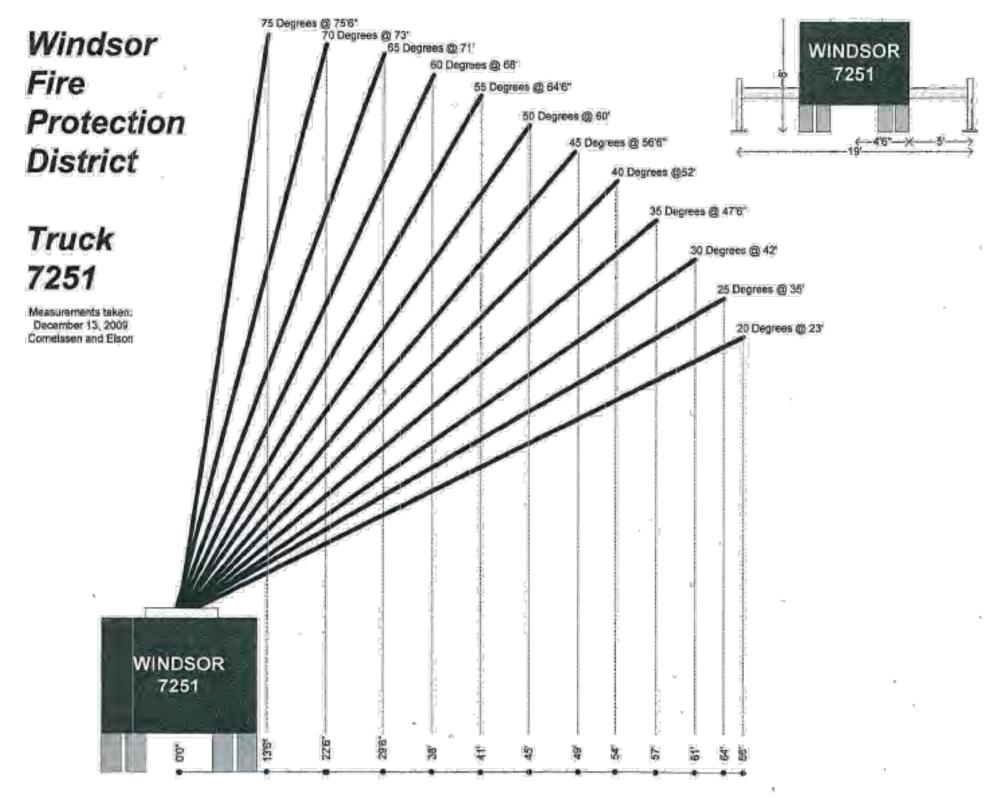

WINDSOR FIRE TRUCK #7251 E C3.3 NOT TO SCALE





NC HOTELS, ANDMARK

2019

95403 HYATT PLACE HOTEL
HOTEL USE PERMIT
FIRE LADDER SECTIONS
. Laughlin Rd., Santa Rosa, C
APN: 059-370-033

3750 N.

JOB#17052 SHEET

ABBREVIATIONS

LGLIND		ADDILL V			
	ASHPHALT SURFACE	<	ANGLE	LS	LANDSCAPE
· · · · · · · · · · · · · · · · · · ·		& @	AND AT	LT MH	LEFT MANHOLE
Δ	CONCRETE SURFACE	Ģ.	CENTERLINE	MAX	MAXIMUM
* * * * * * * * * * * * * * * * * * *	LANDSCAPE AREA	N OR DIA FL	DEGREE DIAMETER	MIN MISC	MINIMUM MISCELLANEOUS
15	5 FOOT INDEX	II	FLOWLINE PARALLEL	N N.I.C.	NORTH NOT IN CONTRACT
10	1' INTERVAL	% -	PERCENT	N.T.S.	NOT TO SCALE
	CONTOURS	I PL	PERPENDICULAR PROPERTY LINE	NO. OR #	NUMBER
	SUBJECT PROPERTY BOUNDARY	AC	ASPHALT CONCRETE	O.C. O.D.	ON CENTERS OUTSIDE DIAMETER
	OVERHEAD ELECTRIC LINE	AD ADD'I	AREA DRAIN ADDITIONAL	ОН	OVERHEAD
	OVERHEAD TELEPHONE LINE	AGG	AGGREGATE	PI POVC	POINT OF INTERSECTION POINT ON VERTICAL CURVE
	OVERHEAD UTILITY LINES (MULTIPLE) OVERHEAD ELECTRIC (HIGH VOLTAGE)	APPROX	APPROXIMATE	PP	POWER POLE
	OVERHEAD UTILITY LINES (HIGH VOLTAGE)	AVG BASMAA	AVERAGE BAY AREA STORM WATER	PSD	PERFORATED SUBDRAIN
— G — — G —	•	<i>B</i> / (0) / (1) / (1)	MANAGEMENT ASSOCIATION	PUE PVC	PUBLIC UTILITES EASEMENT POLYVINYLCHLORIDE
—SD ——SD —	STORM DRAIN LINE	ВС	OF AGENCIES	PW	PROCESS WASTEWATER
—ss ——ss —	SANITARY SEWER LINE	BFE	BEGIN CURVE BASE FLOOD ELEVATION	PT PVMT	POINT PAVEMENT
	WATER LINE	BGL	BOTTOM OF GRAVEL LAYER	R/W	RIGHT OF WAY
	UNDERGROUND TRAFFIC SIGNAL WIRE	BM BSL	BENCH MARK	R OR RAD	RADIUS BELATIVE COMPACTION
OO	CHAINLINK FENCE	BVC	BUILDING SET BACK LINE BEGIN VERTICAL CURVE	R.C. REF	RELATVE COMPACTION REFERENCE
xxx		CDS	CHAIN DOWNSPOUT	REINF	REINFORCING
A	SURVEY CONTROL POINT	CJ CMP	CONTROL JOINT CORRUGATED METAL PIPE	REQ'D RIM	REQUIRED RIM ELEVATION OF
+ 100.00	SPOT ELEVATION	C.O.	CLEANOUT	KIIVI	BASMAA FEATURE
<i>co</i> 🔘	SANITARY SEWER CLEANOUT	CLR	CLEAR	RT	RIGHT
SS	SANITARY SEWER MANHOLE	CO. CONC	COUNTY CONCRETE	S	SOUTH OR SLOPE
(SD)	STORM DRAIN MANHOLE	CONST	CONSTRUCTION	SAD SCD	SEE ARCHITECTURAL DRAWINGS SEE CIVIL DRAWINGS
0	STORM DRAIN CATCH BASIN	CONT CTR	CONTINUOUS	SD	STORM DRAIN
	DRAINAGE INLET	DI	CENTER DROP INLET	SED	SEE ELECTRICAL DRAWINGS
	DRAINAGE INLET	DS	DOWNSPOUT	SF SFPD	SQUARE FEET SEE FIRE PROTECTION DRAWINGS
■ DS	DRAINAGE DOWNSPOUT	DIA DWG	DIAMETER DRAWING	SG	SUBGRADE
	IRRIGATION CONTROL VALVE	Ε	EAST	SLAD	SEE LANDSCAPE ARCHITECTS DRAWINGS
(M)	MONITORING WELL	EC EF	END CURVE	SPD	SEE PLUMBING DRAWINGS
(WELL	ES	EACH FACE EACH SIDE	SMD	SEE MECHANICAL DRAWINGS
Юн	FIRE HYDRANT	ETW	EDGE OF TRAVELLED WAY	SS	STAINLESS STEEL OR SANITARY SEWER
	WATER VALVE	EVC EW	END VERTICAL CURVE EACH WAY	SSD	SEE STRUCTURAL DRAWINGS
W	WATER METER	EA	EACH	SSP SSR	SEE SEPTIC PLANS SEE SOILS REPORT
X	HOSE BIB	EL OR ELEV ELEC OR E	ELEVATION ELECTRICAL	SSMH	SANITARY SEWER MANHOLE
E <i>PG&E</i>	ELECTRIC BOX PG&E VAULT	EMBED	EMBEDMENT	SIM SPEC	SIMILAR SPECIFICATION
(E)	ELECTRIC LID	EQ EXIST OR (E)	EQUAL OR EQUATION	SQ	SQUARE
● PP	POWER POLE	FES	EXISTING FLARED END SECTION	SRD	SEE REFRIGERATION DRAWINGS
● JP	JOINT UTILITY POLE	FG	FINISH GRADE	STA STD	STATION STANDARD
- ∭ √P	JOINT POLE W/STREET LIGHT	FH FP	FIRE HYDRANT FIRE PROTECTION	STRUC	STRUCTURAL
● S	TRAFFIC SIGNAL	FIN	FINISH	T TBM	TELEPHONE TEMPORARY BENCH MARK
- © S	TRAFFIC SIGNAL POLE W/STREET LIGHT	FT FTG	FOOT OR FEET	TC	TOP OF CONCRETE
●TP ≻<	TELEPHONE POLE	FUT	FOOTING FUTURE	TCC	TOP OF CONCRETE CURB
- 	STREET LIGHT	G	GAS, ROAD GRADIENT	TD TG	TOP OF DECK TOP OF GRATE
	LANDSCAPE LIGHT	GB GV	GRADE BREAK GATE VALVE	TGL	TOP GRAVEL LAYER
	STREET LIGHT BOX	GALV	GALVANIZED	TP TO:	TOP OF PAVEMENT
<u>s</u> 0	TRAFFIC SIGNAL LIGHT BOX TRAFFIC DETECTOR LID	HD HP	HEAVY DUTY HIGH POINT	TSL TAN, T	TOP SOIL LAYER TANGENT
	TELEPHONE BOX	HORIZ	HORIZONTAL	TOW	TOP OF WALL
Ŧ	TELEPHONE MANHOLE	HVAC	HEATING, VENTING AND	THK	THICK
	CABLE TV BOX	ID	AIR CONDITIONING INSIDE DIAMETER	TYP UC	TYPICAL UTILITY CHASE
TEL	TELEPHONE VAULT	IE (INV)	INVERT ELEVATION	UG	UNDERGROUND
<u> </u>	GAS VALVE	IN. IRR	INCH INCH TION	USP UNO	UNDER SEPARATE PERMIT UNLESS NOTED OTHERWISE
G	GAS METER	JB	IRRIGATION JUNCTION BOX	VC	VERTICAL CURVE
0	BOLLARD	JT	JOINT	VG	VALLEY GUTTER
- о -	SIGN	L LD	LENGTH LIGHT DUTY	VERT W/	VERTICAL WITH
<u></u> M	MAILBOX	LF	LINEAL FOOT	w/o	WITHOUT
•	FOUND IRON PIPE, SIZE AND	LP	LOW POINT	W WBD	WEST OR WATER WALL BACK DRAIN
	TAGGED AS NOTED			WWF	WELDED WIRE FABRIC
lacktriangle	FOUND MONUMENT, SIZED AND STAMPED, AS NOTED			XFMR	TRANSFORMER
(TREE SYMBOL AND DRIP LINE			YD, YDS Z	YARD, YARDS DITCH SIDE SLOPE
Yand .	5 5 6				





LANDMARK HOTELS, INC
1520 RAILROAD AVE., ST. HELENA, CA 94574 2019


MARCH 1,

HYATT PLACE HOTEL
HOTEL USE PERMIT
LEGEND AND ABBREVIATIONS
3750 N. Laughlin Rd., Santa Rosa, CA 95403
APN: 059-370-033

JOB#17052 SHEET

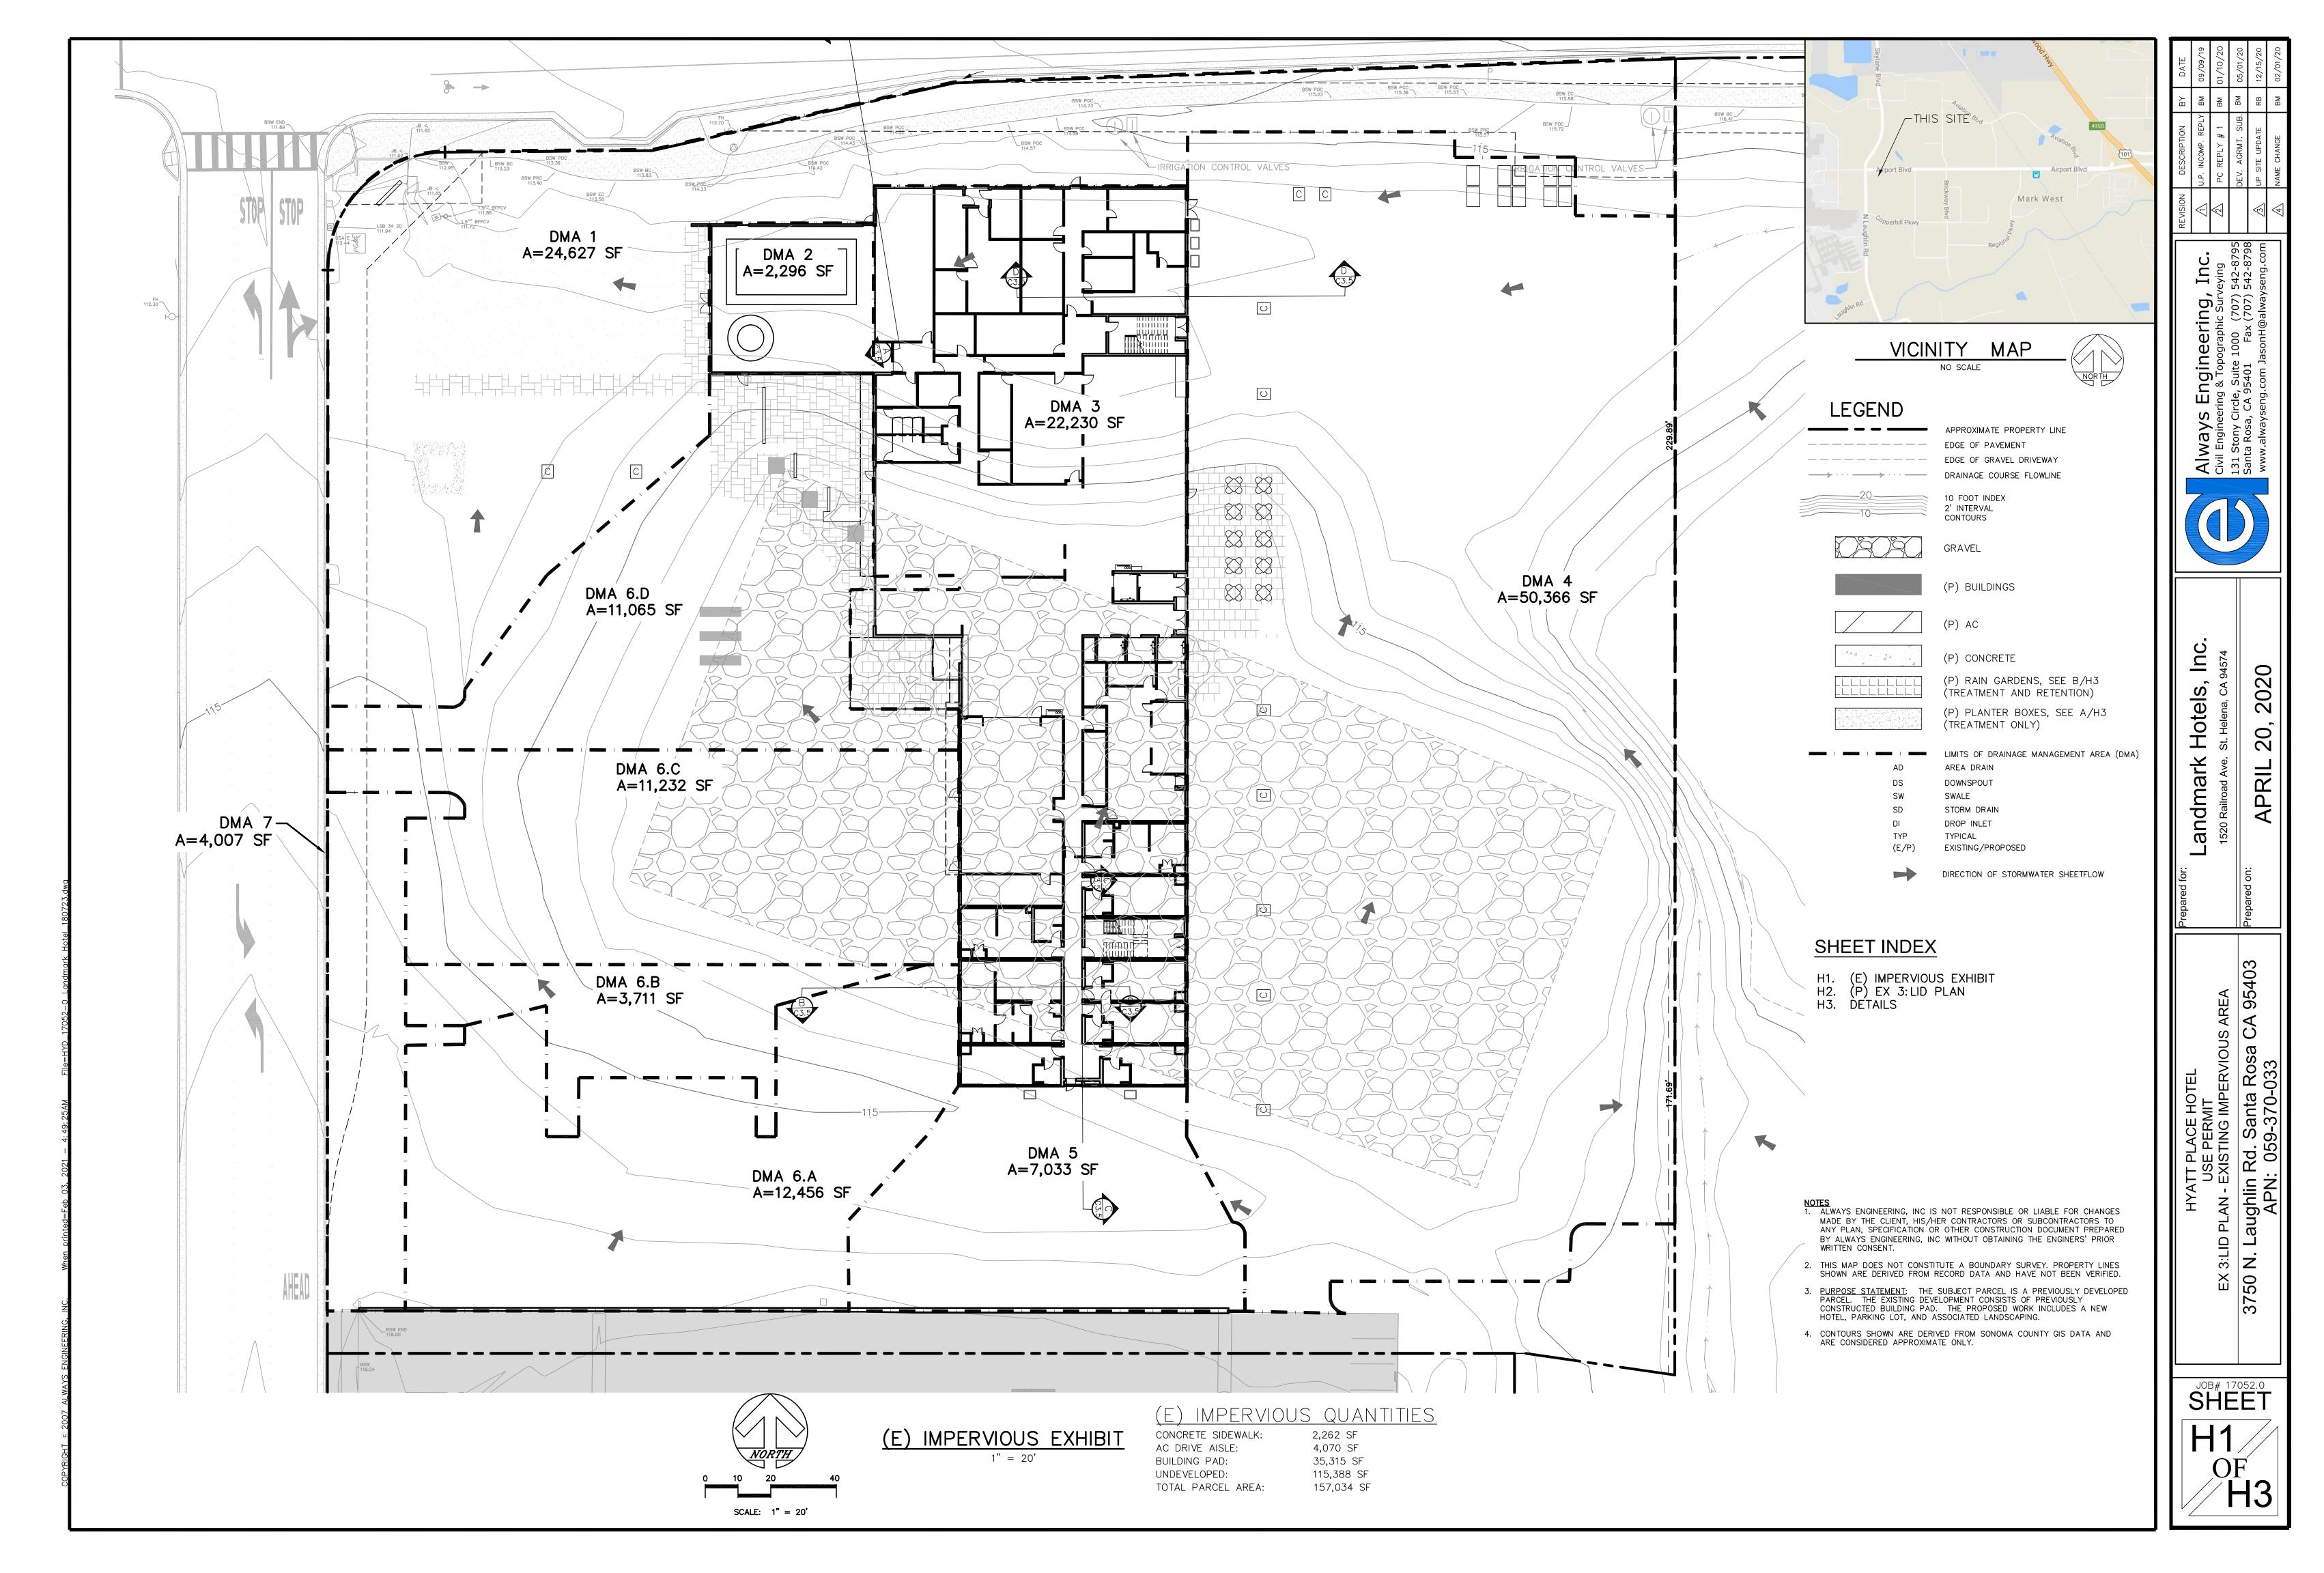

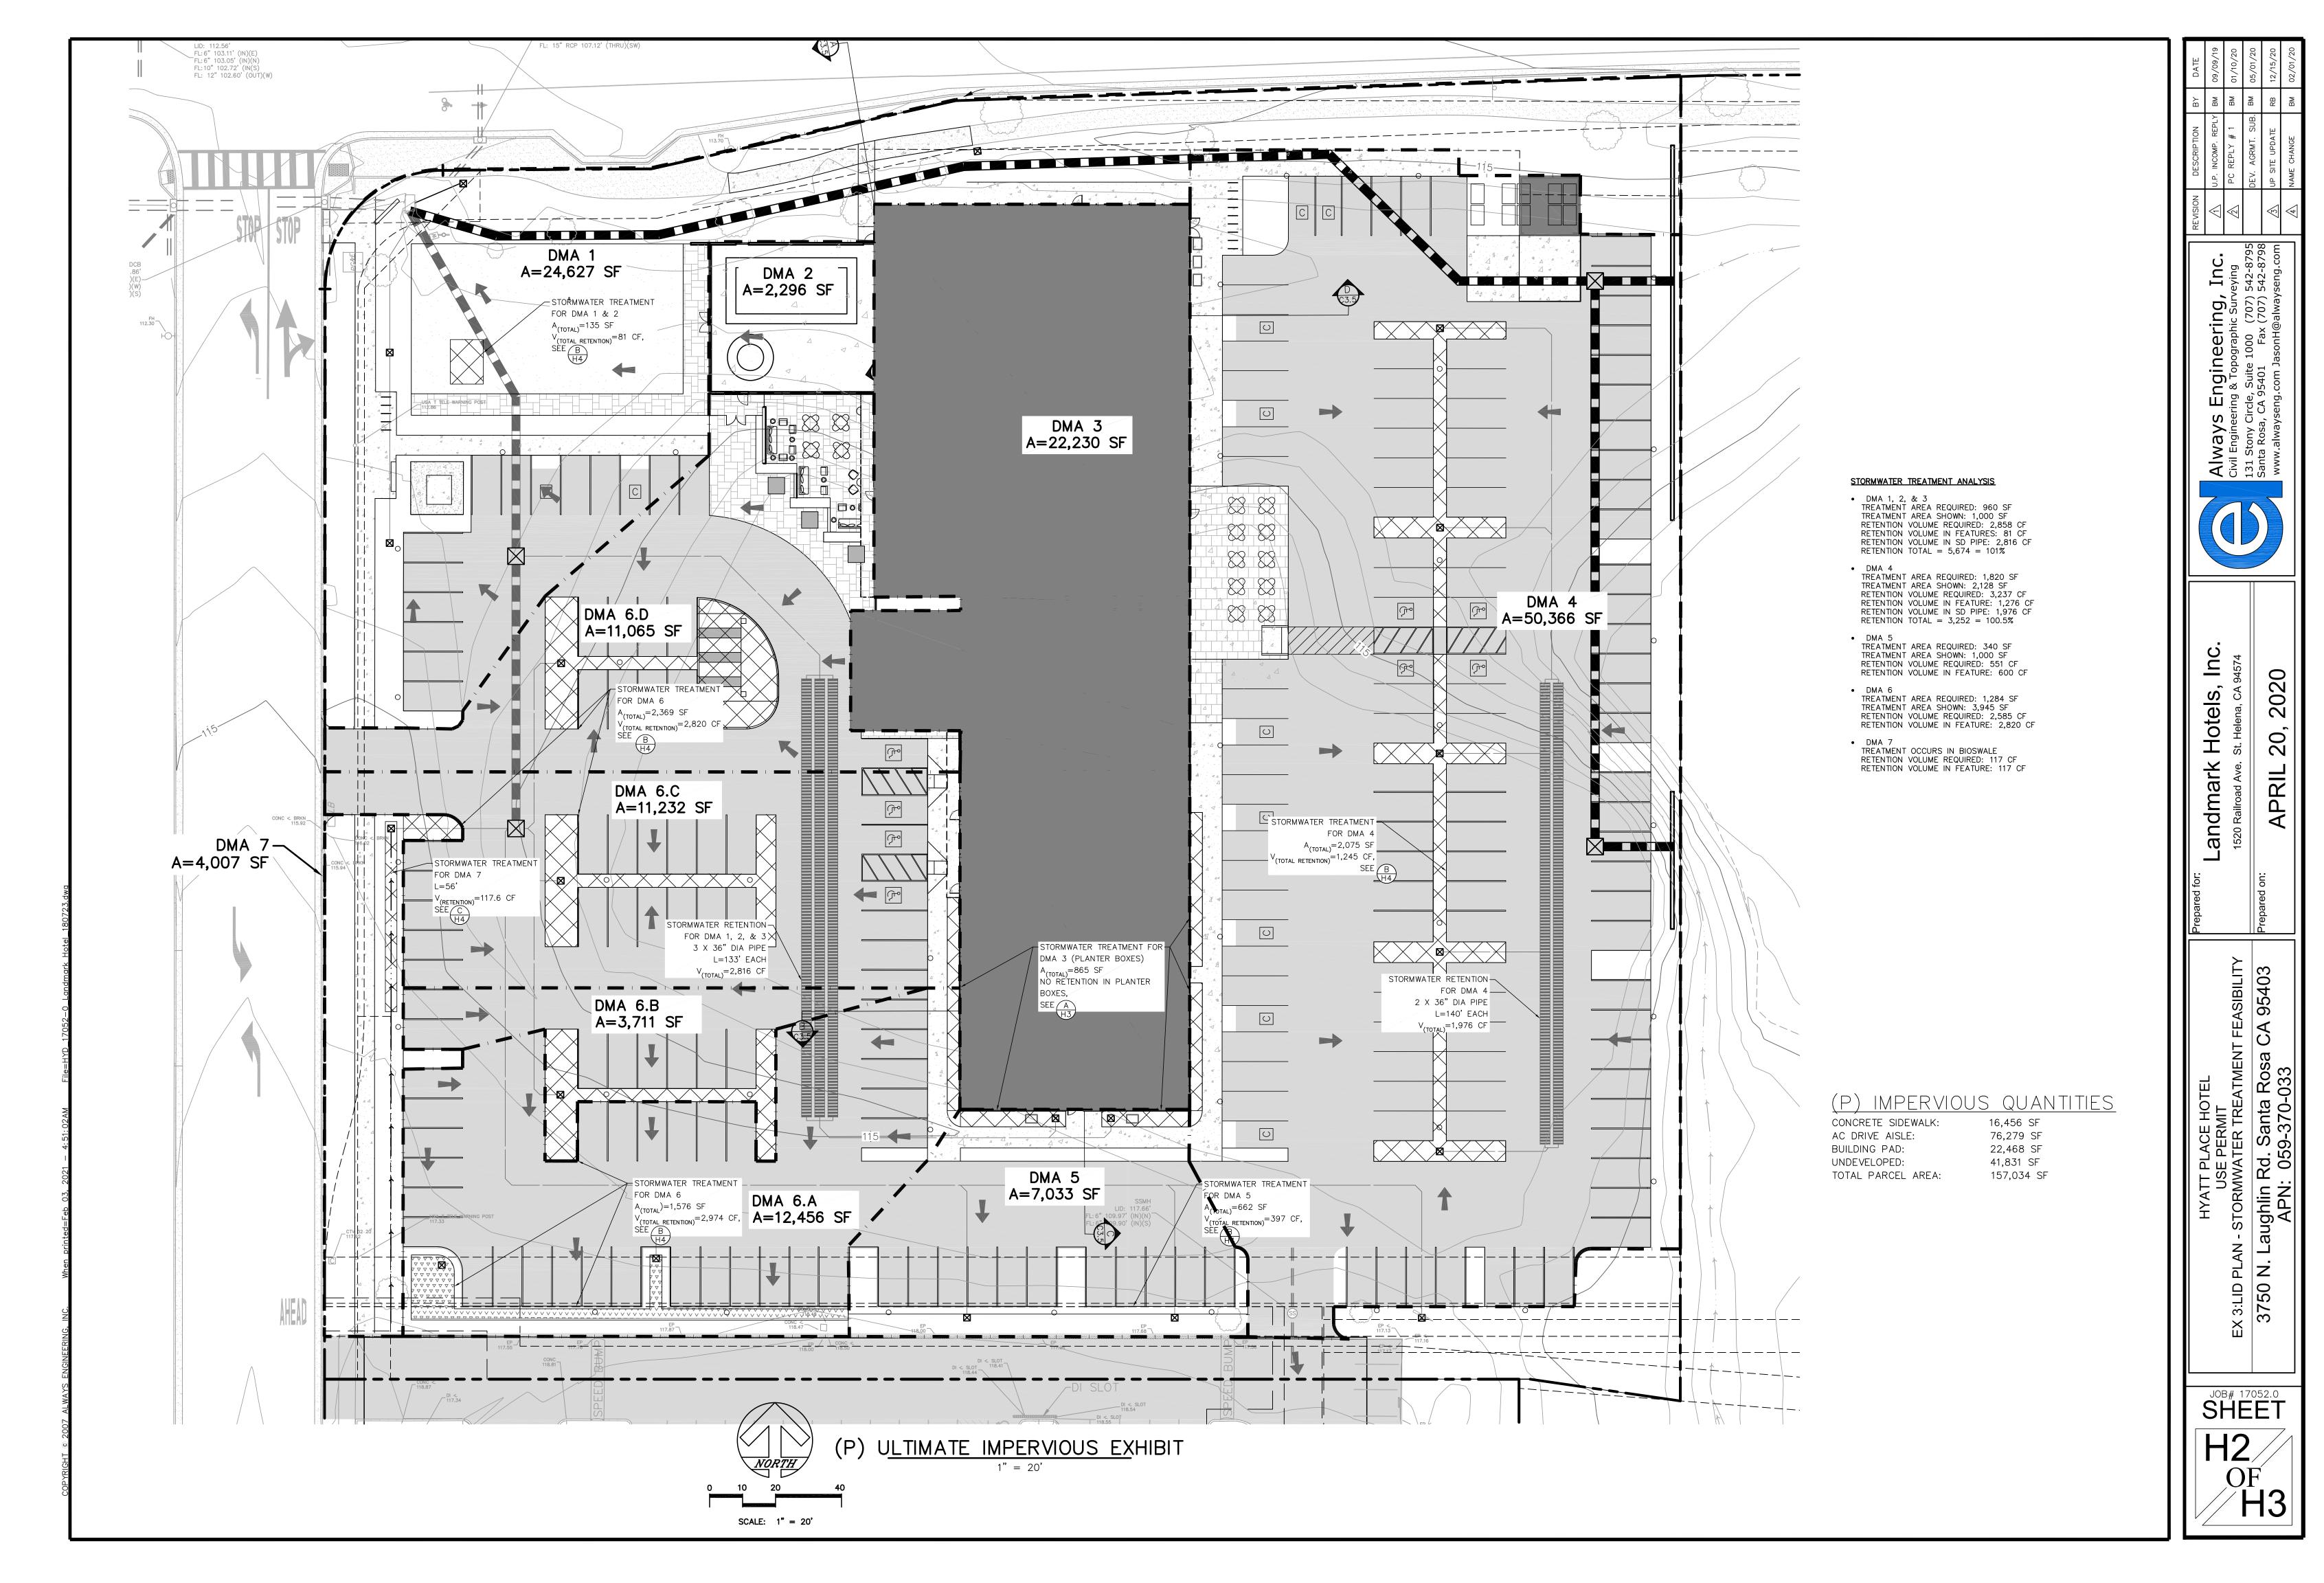

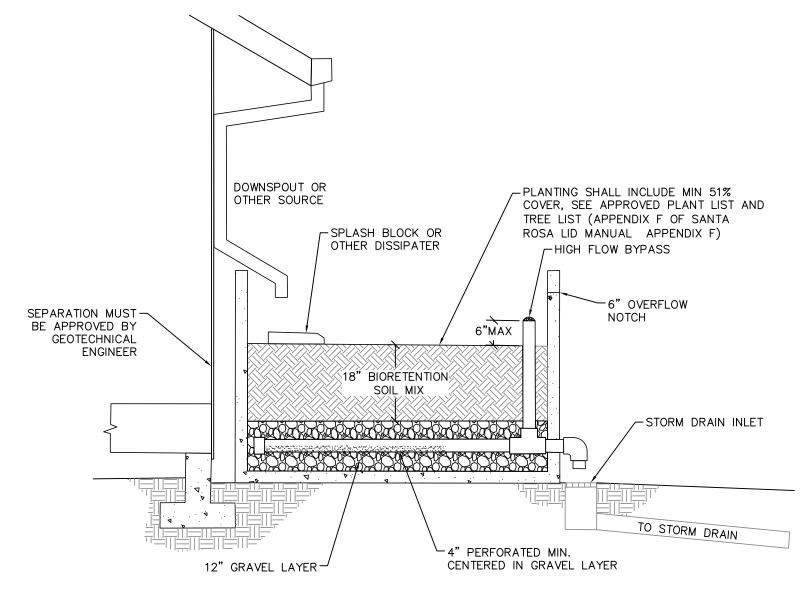


FLOW THROUGH PLANTER INSPECTION AND MAINTENANCE REQUIREMENT

SEE MAINTENANCE PLAN PROVIDED WITH THE FINAL SUBMITTAL. THE MAINTENANCE PLAN INCLUDES RECOMMENDED MAINTENANCE PRACTICES, IDENTIFIES THE PARTIES RESPONSIBLE FOR MAINTENANCE AND UPKEEP, SPECIFIES THE FUNDING SOURCE FOR ONGOING MAINTENANCE WITH PROVISIONS FOR FULL REPLACEMENT WHEN NECESSARY AND PROVIDES SITE SPECIFIC INSPECTION CHECKLISTS.

AT A MINIMUM INSPECTION AND MAINTENANCE SHALL INCLUDE THE FOLLOWING:

- INSPECT TWICE ANNUALLY FOR PONDED WATER. IF PONDED WATER IS OBSERVED, THE PERFORATED PIPE SHALL BE CLEANED.
- IF PONDED WATER REMAINS, FURTHER GRADING AND REPLACEMENT MAY BE NECESSARY TO PREVENT MOSQUITO BREEDING.
- THE HIGH FLOW INLET SHOULD BE INSPECTED AND CLEANED AS NECESSARY TO REMOVE
- ANY OBSTRUCTIONS. • PESTICIDES AND FERTILIZERS SHALL NOT BE USED IN THE PLANTER AREA.
- PLANTS SHOULD BE PRUNED, WEEDS PULLED AND DEAD PLANTS REPLACED AS NEEDED. CHECK DOWNSPOUT SPLASH BLOCKS FOR PROPER LOCATION AND FILL/REGARD ANY
- EVALUATE MULCHING AROUND PLANTS. ADD/REPLACE AS NEEDED.



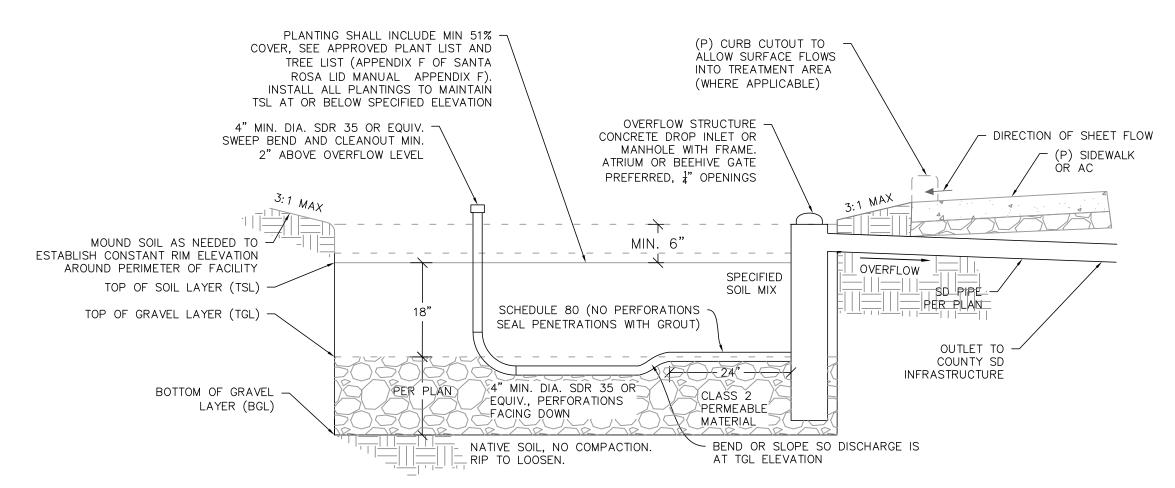


RAIN GARDEN INSPECTION AND MAINTENANCE REQUIREMENT

A MAINTENANCE PLAN SHALL BE PROVIDED WITH THE FINAL SWLID SUBMITTAL. THE MAINTENANCE PLAN SHALL INCLUDE RECOMMENDED MAINTENANCE PRACTICES, STATE THE PARTIES RESPONSIBLE FOR MAINTENANCE AND UPKEEP, SPECIFY THE FUNDING SOURCE FOR ONGOING MAINTENANCE WITH PROVISIONS FOR FULL REPLACEMENT WHEN NECESSARY AND PROVIDE SITE SPECIFIC INSPECTION CHECKLIST. AT A MINIMUM MAINTENANCE SHALL INCLUDE THE FOLLOWING:

- DRY STREET SWEEPING UPON COMPLETION OF CONSTRUCTION
- DRY STREET SWEEPING ANNUALLY, AND -WHEN WATER IS OBSERVED FLOWING IN THE GUTTER DURING A LOW INTENSITY STORM. -ALGAE IS OBSERVED IN THE GUTTER. -SEDIMENT/DEBRIS COVERS 1/3 OF THE GUTTER WIDTH OR MORE.
- INSPECT TWICE ANNUALLY FOR SEDIMENTATION AND TRASH ACCUMULATION IN THE
- GUTTER. OBSTRUCTIONS AND TRASH SHALL BE REMOVED AND PROPERLY DISPOSED OF. • INSPECT TWICE DURING THE RAINY SEASON FOR PONDED WATER.
- PESTICIDES AND FERTILIZERS SHALL NOT BE USED IN THE BIORETENTION AREA. PLANTS SHOULD BE PRUNED, WEEDS PULLED AND DEAD PLANTS REPLACED AS NEEDED.

BIORETENTION FACILITY (RAIN GARDEN) CROSS-SECTION

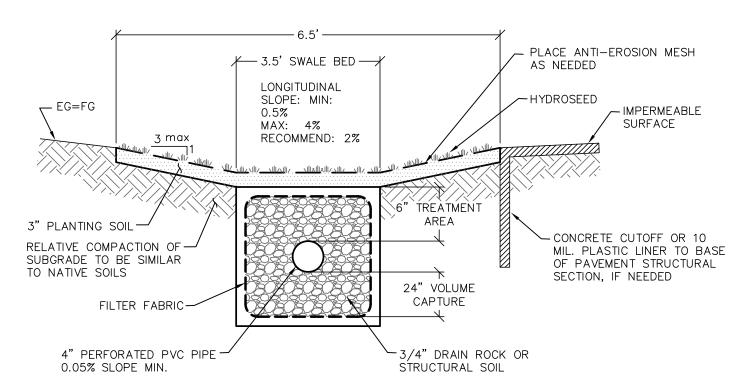

USE MAX. 4" DEPTH FOR SWALE CAPACITY CALCULATIONS
 ALL SURFACE WATER MUST DRAIN WITHIN 72 HOURS TO PREVENT MOSQUITO BREEDING

MAINTENANCE:
ROUTINE MAINTENANCE IS REQUIRED. BEFORE A PLANTED SWALE IS DENSELY VEGETATED, IT IS
ROUTINE MAINTENANCE IS REQUIRED. BEFORE A PLANTED SWALE IS DENSELY VEGETATED, IT IS EXTREMELY VULNERABLE TO EROSION AND MUST BE PROTECTED WITH STRAW MATTING AND OTHER EROSION CONTROL MATERIALS. MAINTENANCE OF A DENSE, HEALTHY VEGETATED COVER CONSISTS OF PERIODIC MOWING (KEEP GRASS 2-4 INCHES HIGH), WEED CONTROL, RESEEDING OF BARE AREAS, AND CLEARING OF DEBRIS AND ACCUMULATED SEDIMENT. THE SWALES SHOULD BE REGULARLY INSPECTED FOR POOLS OF WATER, FORMATION OF GULLIES, AND FOR UNIFORMITY IN CROSS SECTION WIDTH AND LONGITUDINAL SLOPE. WHEN THE UNIFORMITY IS COMPROMISED IT SHOULD BE CORRECTED QUICKLY.

PLANT NATIVE PERENNIAL GRASSES OR SIMILAR IN THE 4' BOTTOM 'SWALE BED.' VEGETATION AND PERIMETER TREES AND OR SHRUBS IN THE SWALE SHOULD BE ESTABLISHED BEFORE THE FIRST WINTER STORMS, SO PLANT ACCORDINGLY. ONCE SATURATED, SWALES FUNCTION AS CONVEYANCE STRUCTURES CARRYING RUNOFF TO A RAIN GARDEN, WETLAND, INFILTRATION AREA, OR OTHER SAFE LOCATION. SWALES ARE NOT RECOMMENDED FOR AREAS THAT RECEIVE LARGE AMOUNTS OF SEDIMENT THAT CAN PREMATURELY FILL THE SWALE AND IMPEDE ITS FUNCTIONALITY.



BIOINFILTRATION SWALE

NOT TO SCALE

Engineering, ring & Topographic Survercle, Suite 1000 (707) 5 CA 95401 Fax (707) 5

Always Civil Engine 131 Stony (Santa Rosa



Hotels, lmark


0

0

an.

Laughlin Rd. Santa Rosa APN: 059-370-033

HYATT PLACE HOTEL USE PERMIT EX 3:LID PLAN - NOTES & DETAILS

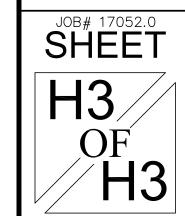




















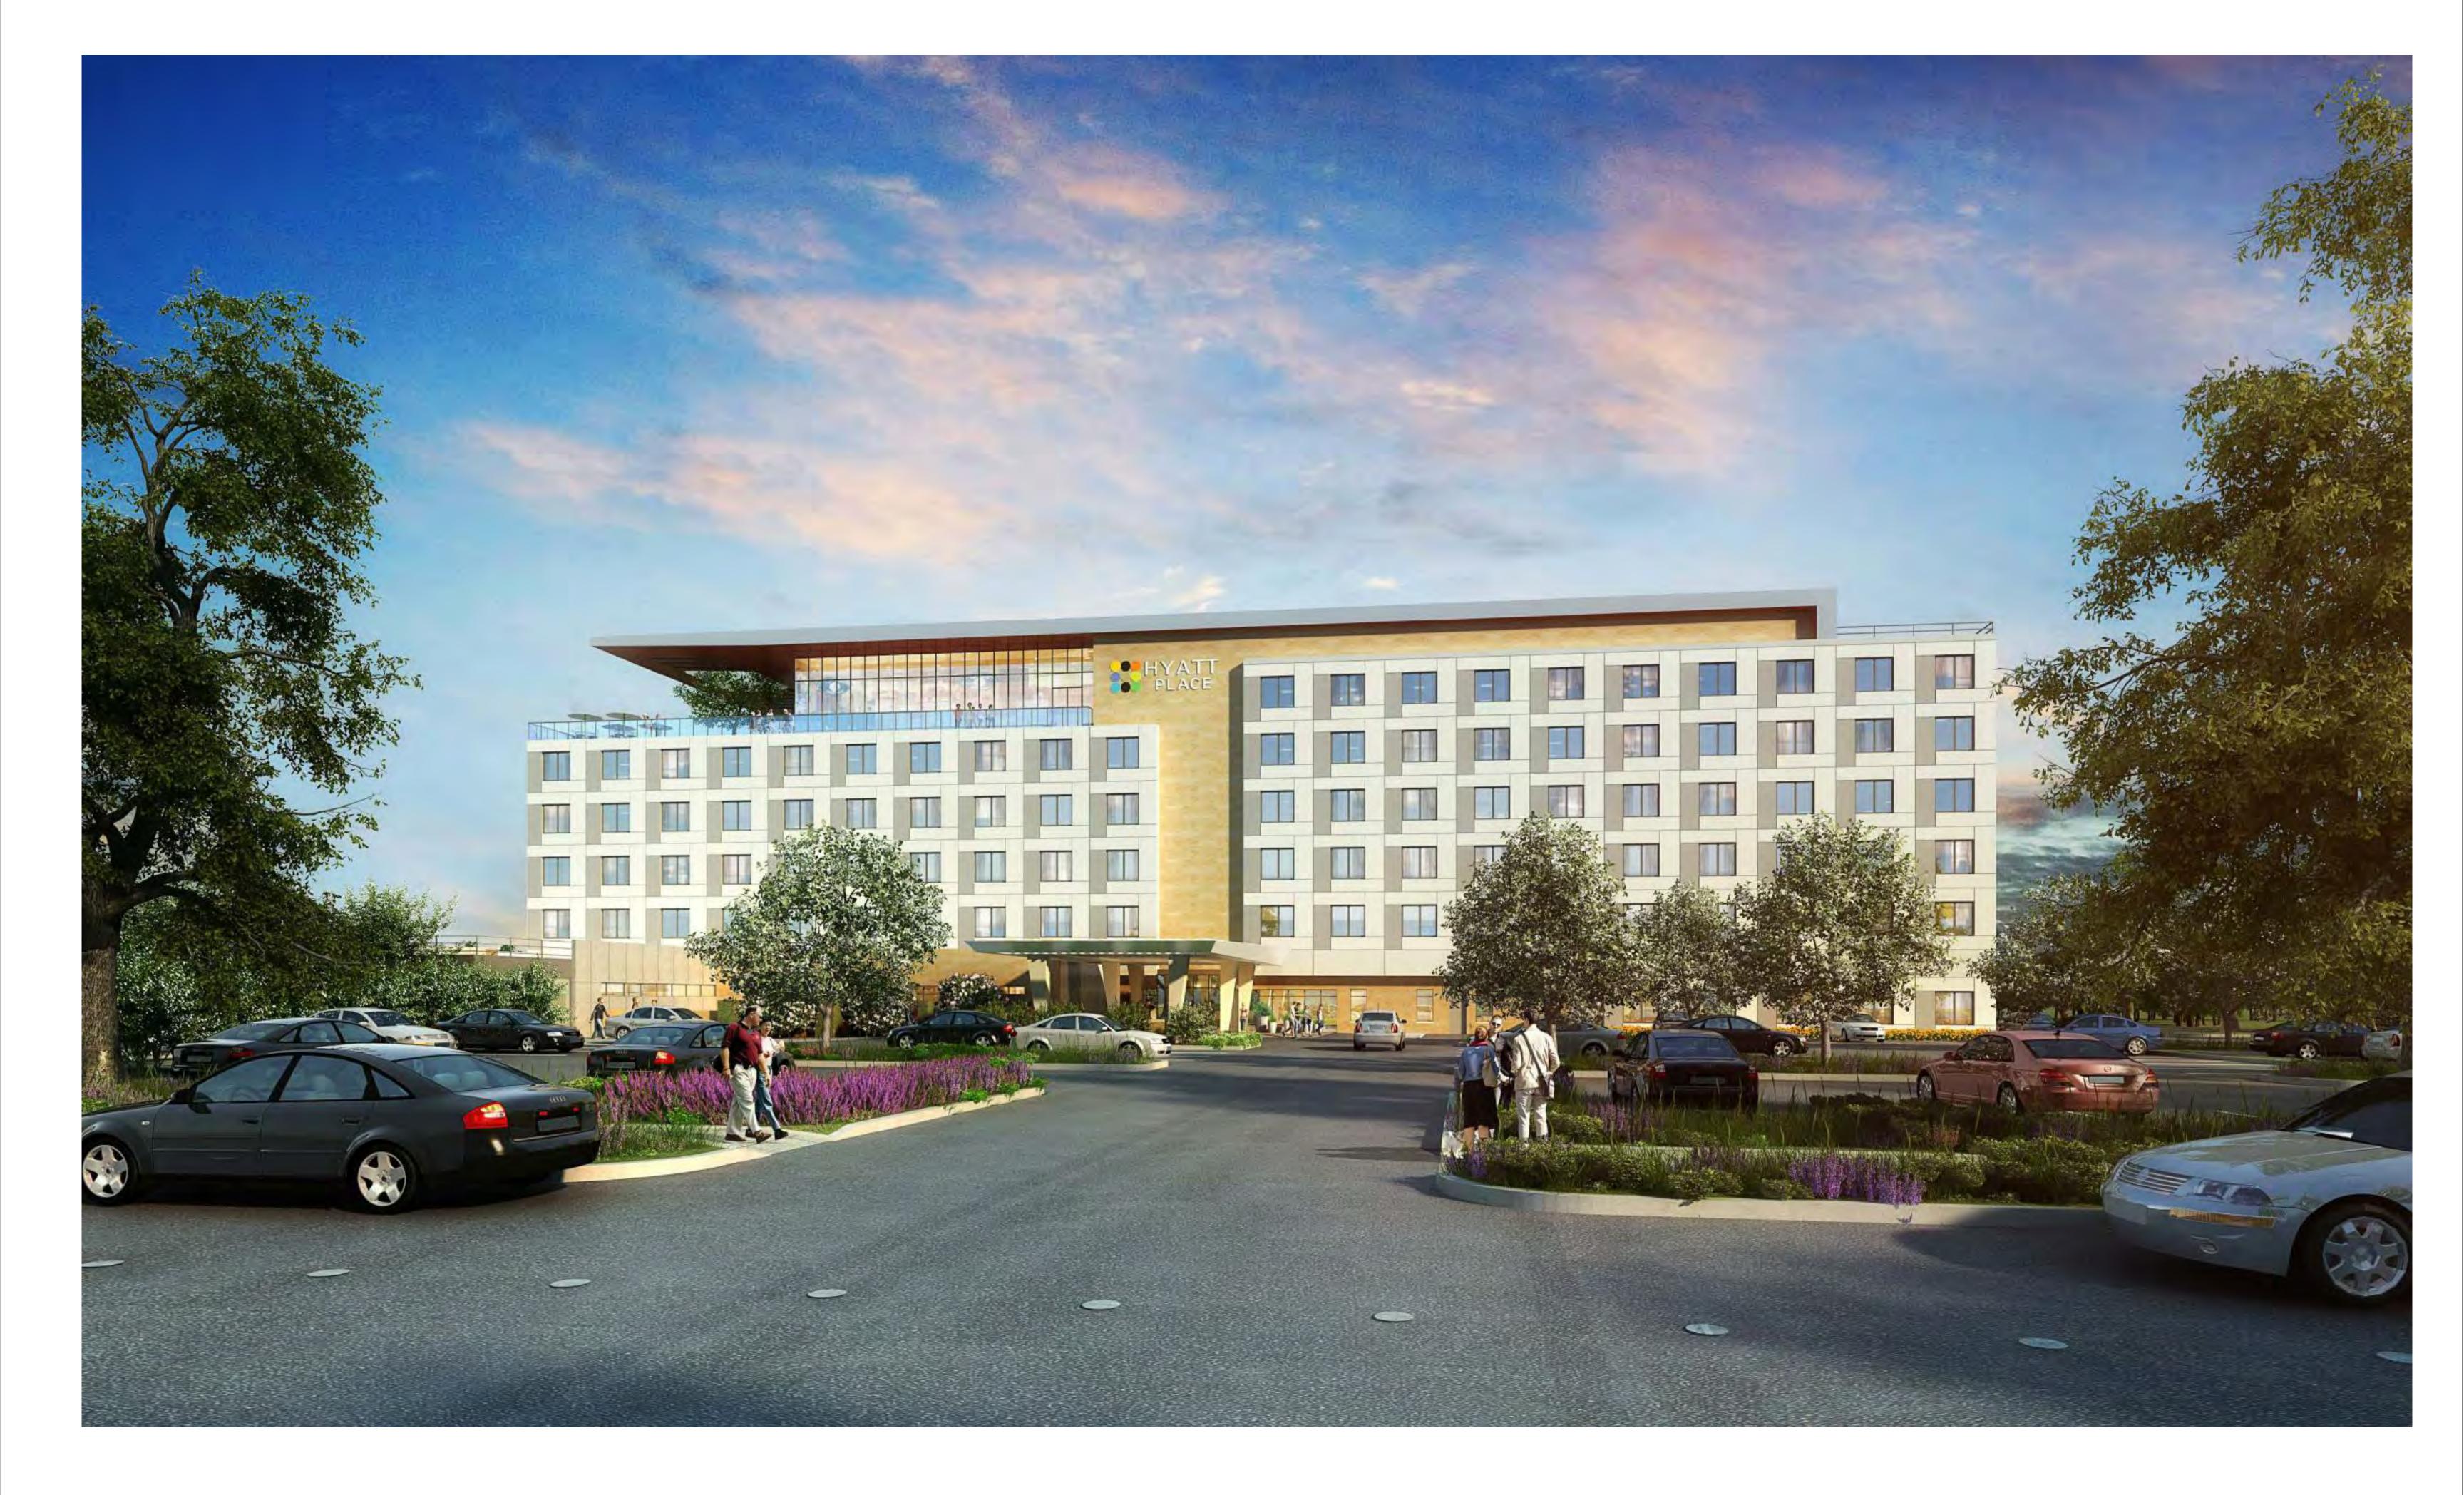














DETAIL VIEW OF PORTE COCHERE



DETAIL VIEW OF PORTE COCHERE





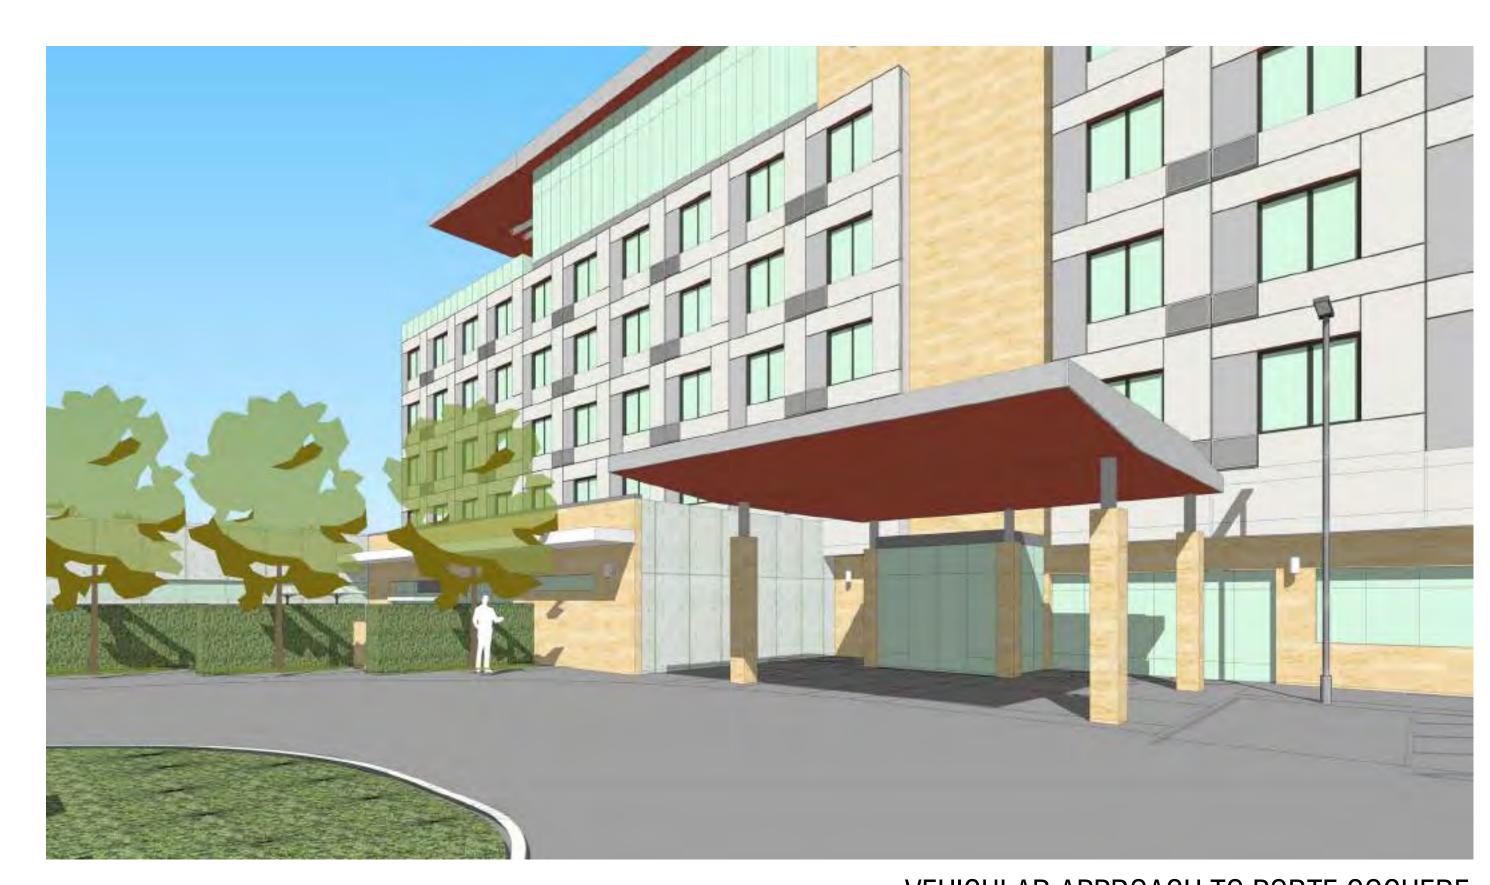

VEHICULAR APPROACH TO PORTE COCHERE



VIEW OF ROOFTOP OUTDOOR DECK



INDOOR POOL AREA




VIEW OF EAST FACING ENTRANCE



VIEW UNDERNEITH ROOFTOP PROJECTION





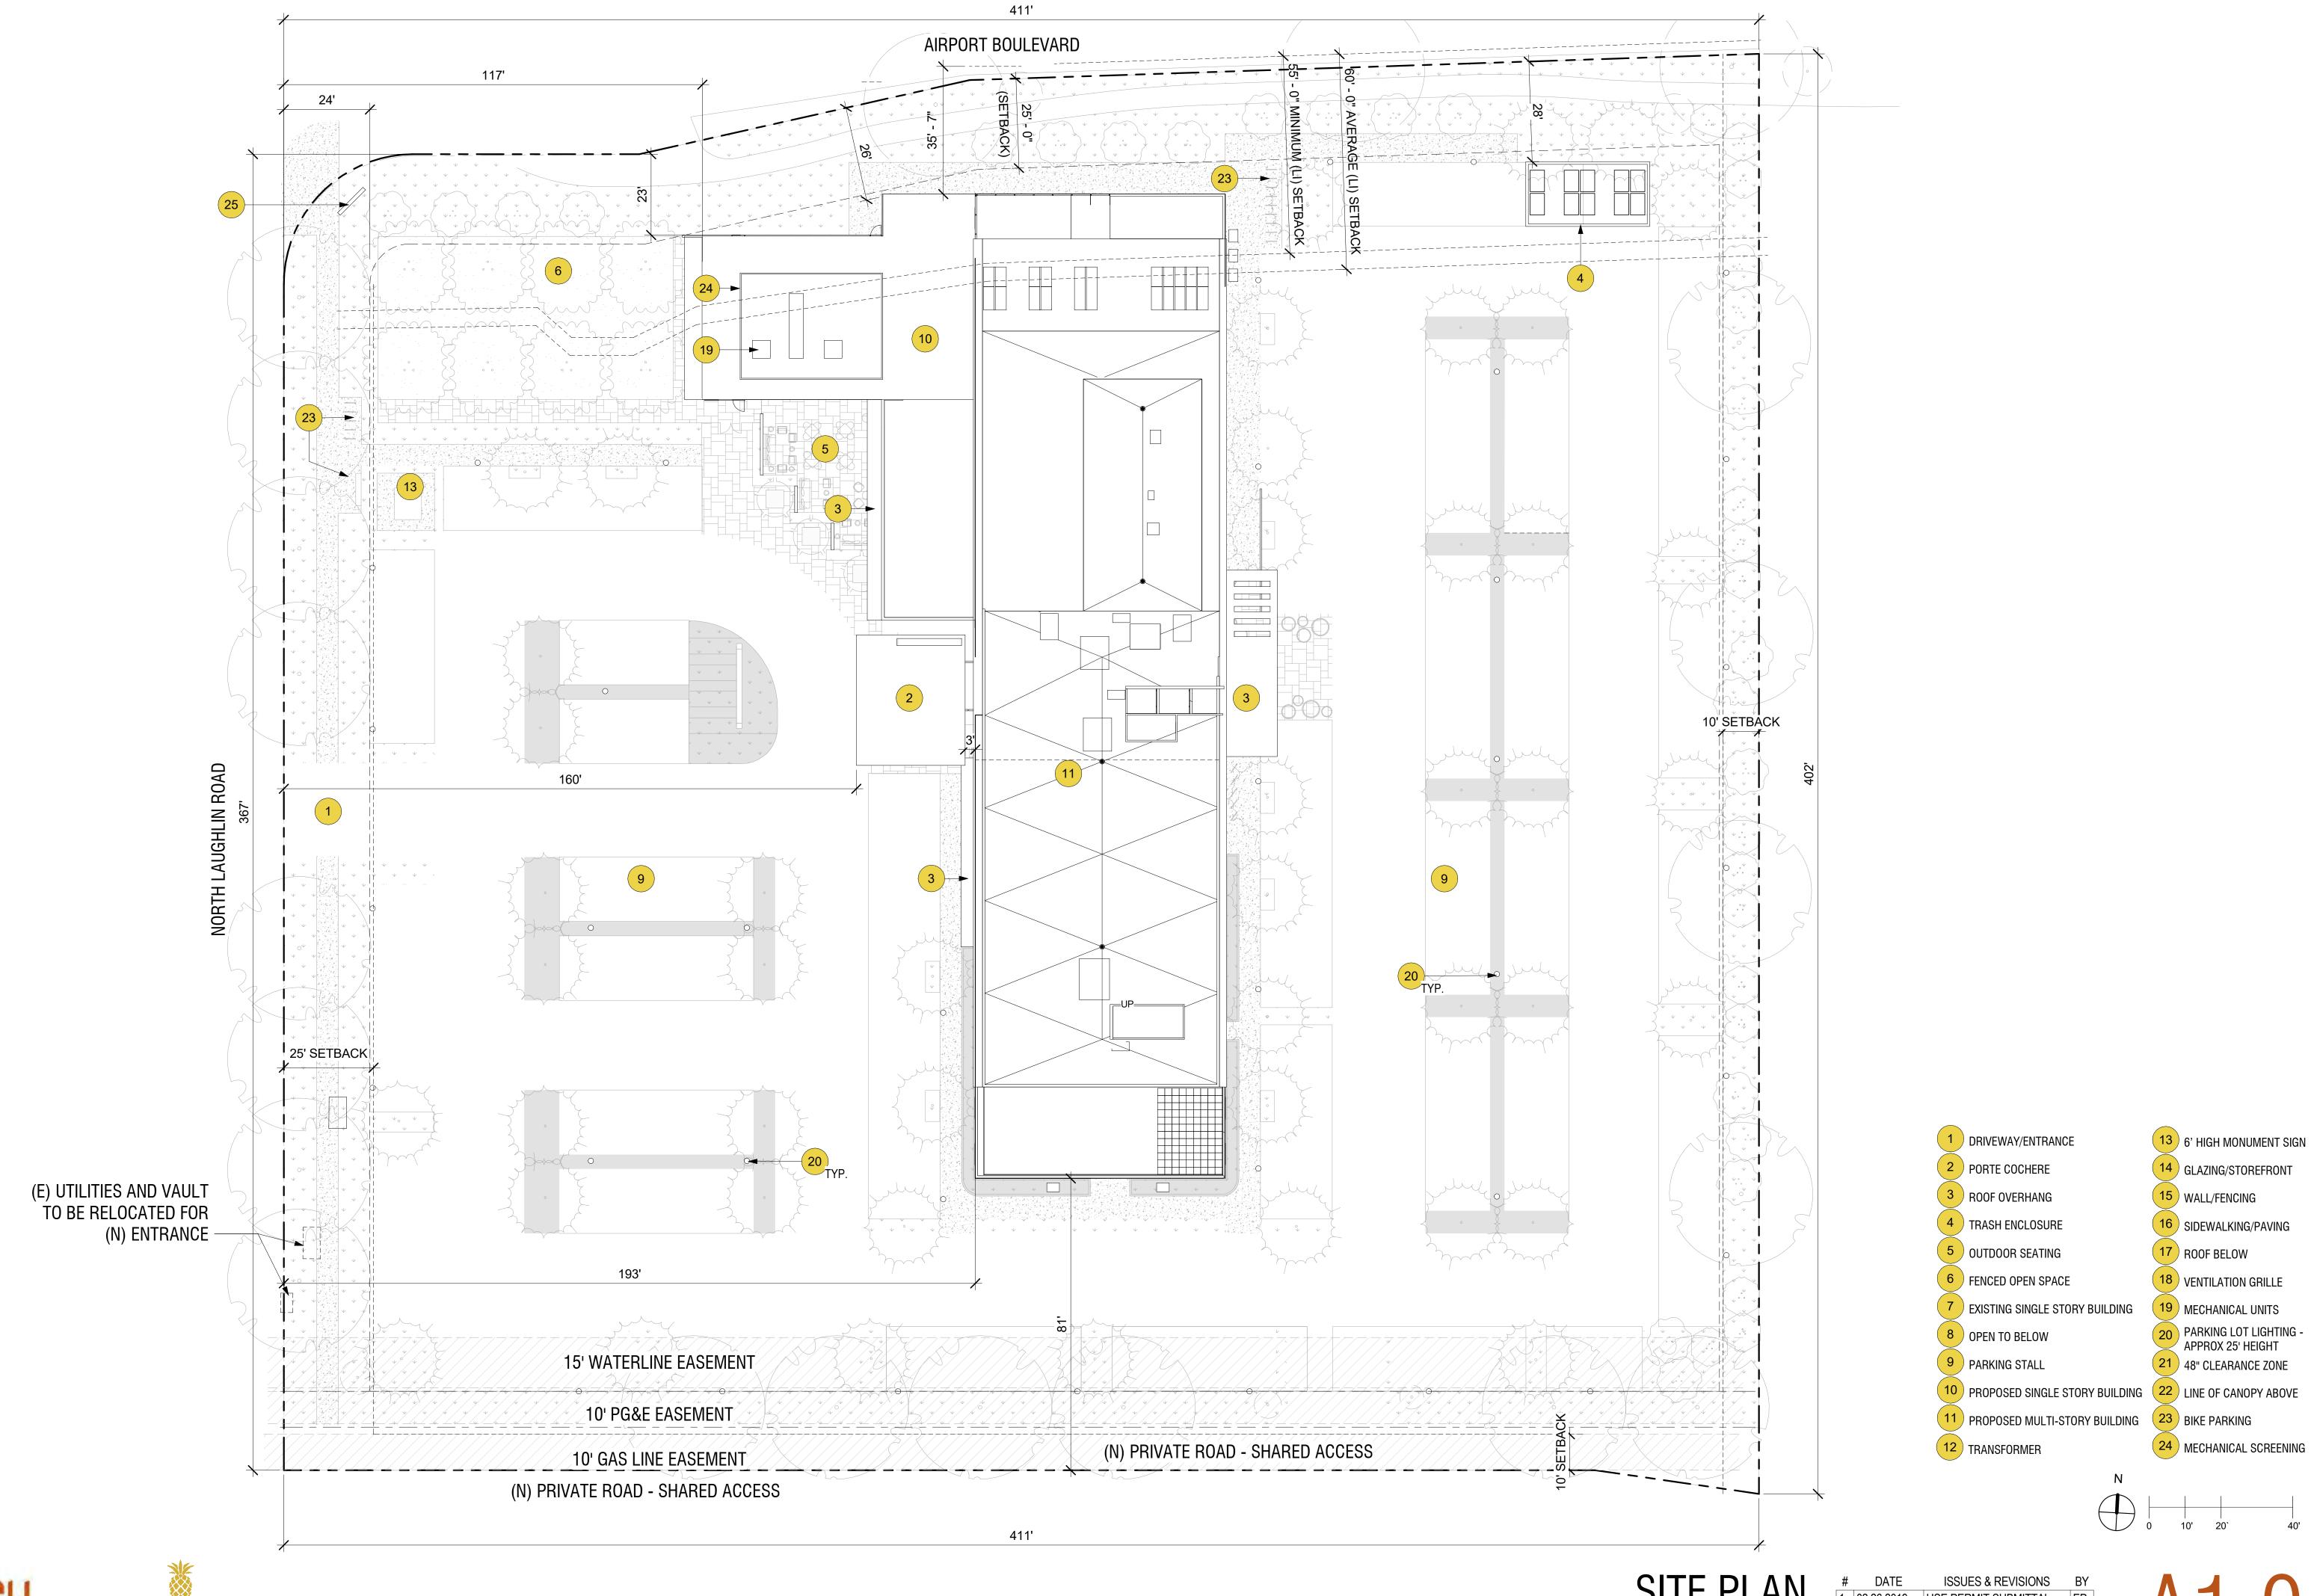






SITE PLAN

HYATT PLACE HOTEL

DATE ISSUES & REVISIONS BY
1 02.26.2019 USE PERMIT SUBMITTAL EP
2 06.3.2019 USE PERMIT RESUBMITTAL EP
3 02.01.2021 USE PERMIT RESUBMITTAL EP

A1.0

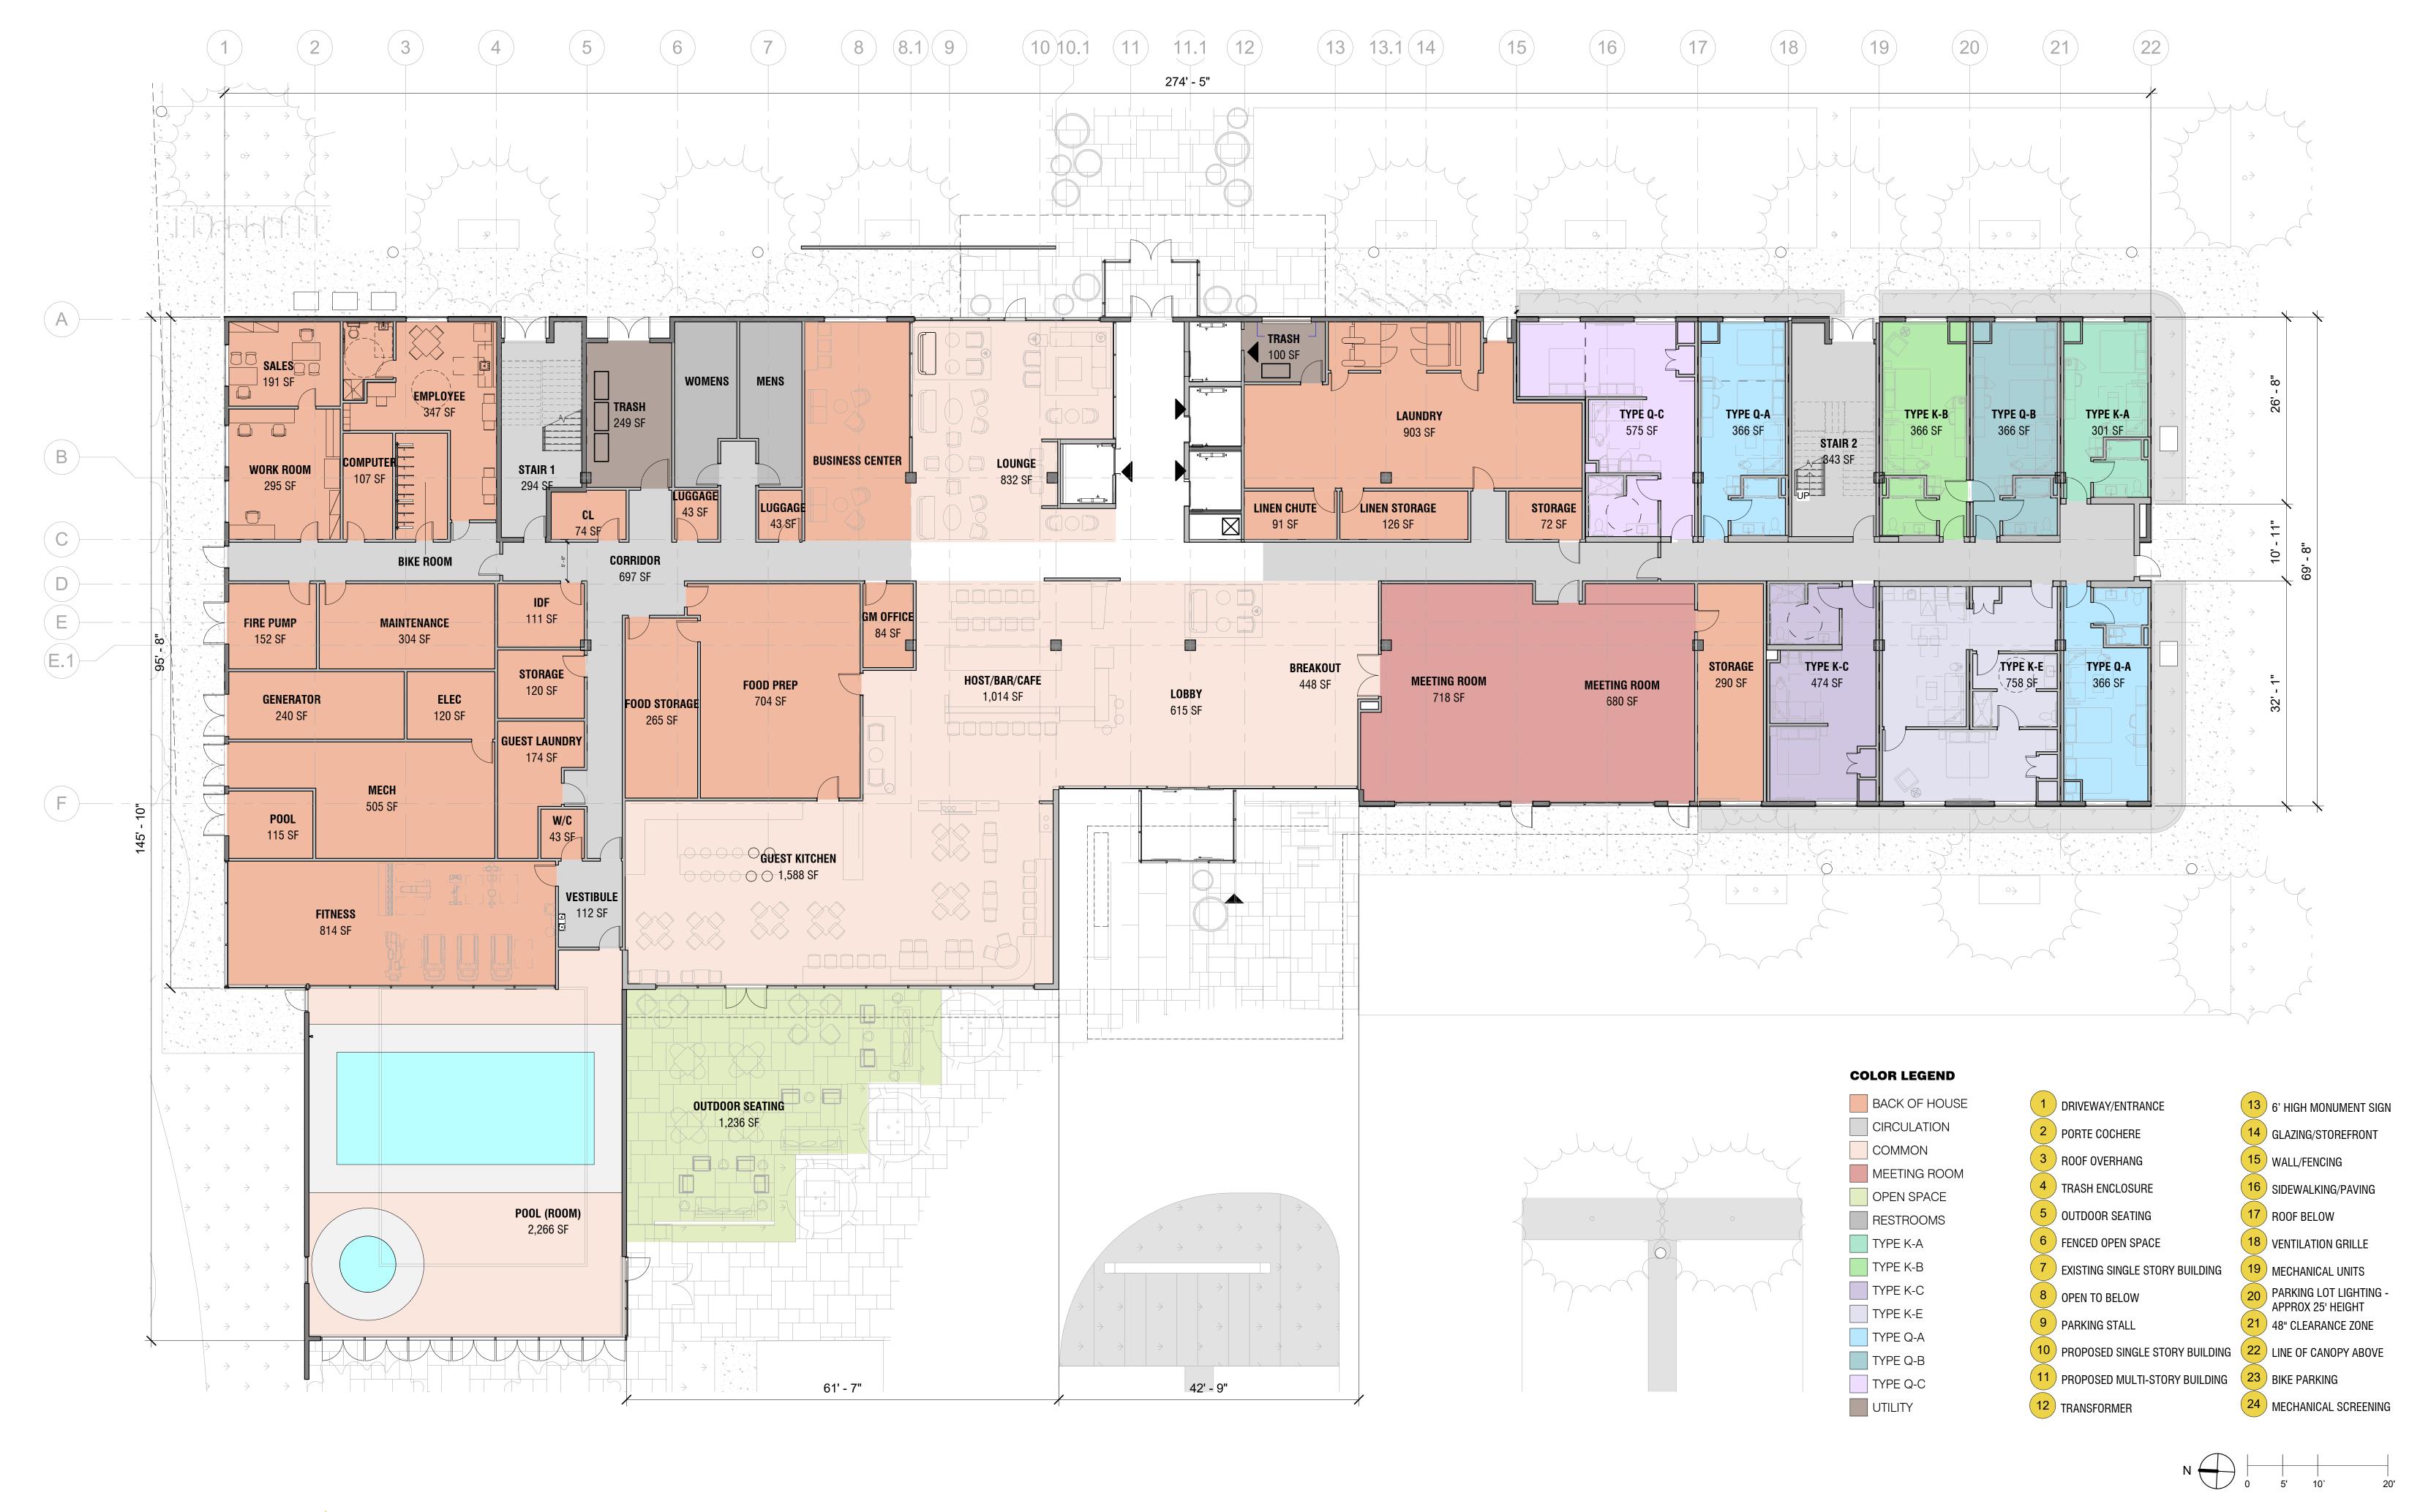





LEVEL 1
HYATT PLACE HOTEL

DATE ISSUES & REVISIONS BY

1 02.26.2019 USE PERMIT SUBMITTAL EP

2 06.3.2019 USE PERMIT RESUBMITTAL EP

3 02.01.2021 USE PERMIT RESUBMITTAL EP

A1.1








LEVEL 2 HYATT PLACE HOTEL

DATE ISSUES & REVISIONS BY
1 02.26.2019 USE PERMIT SUBMITTAL EP
2 06.3.2019 USE PERMIT RESUBMITTAL EP
3 02.01.2021 USE PERMIT RESUBMITTAL EP




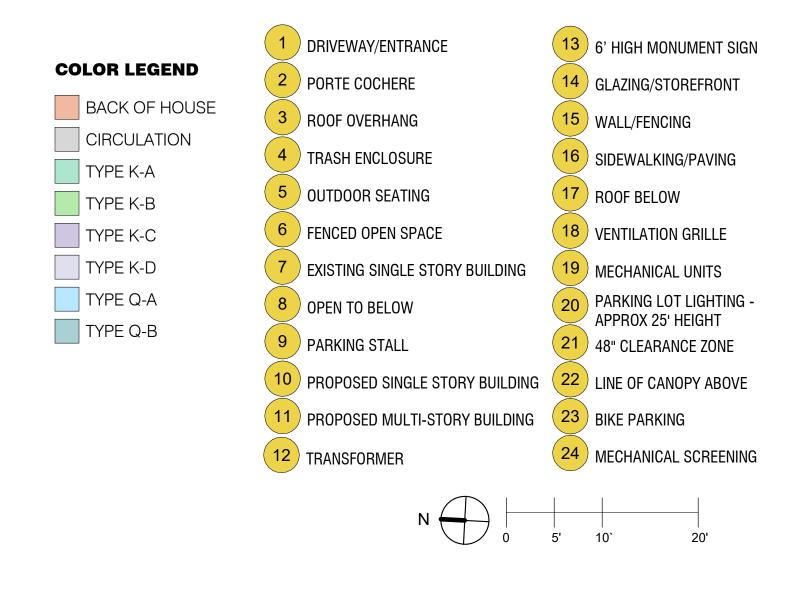








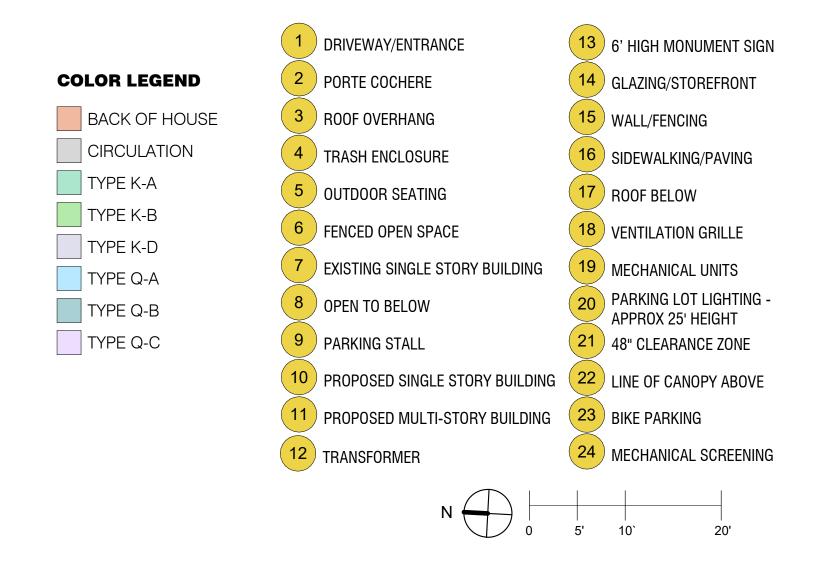








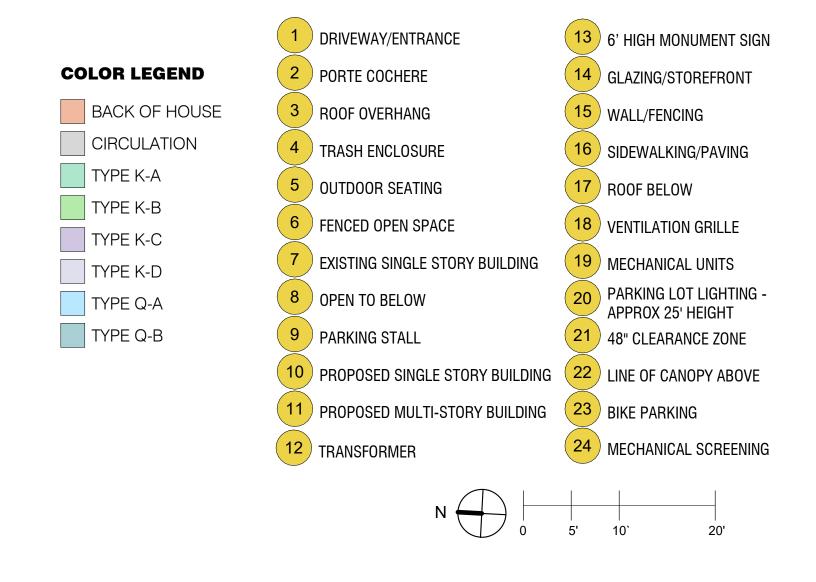









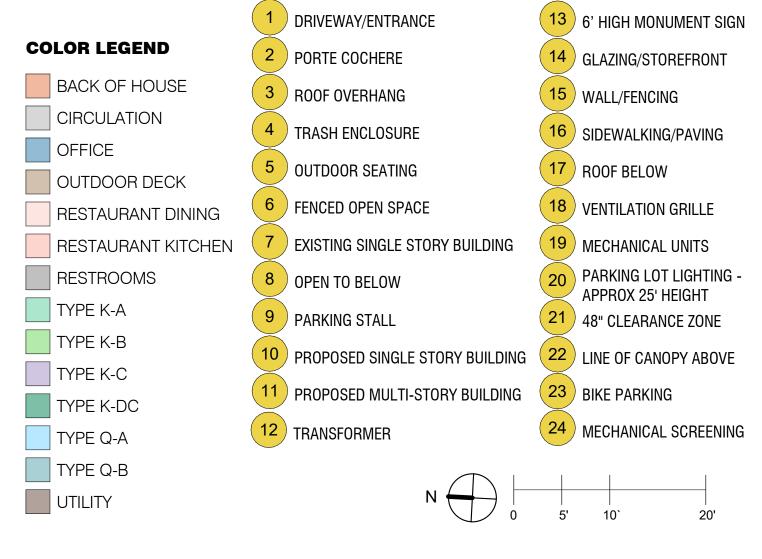






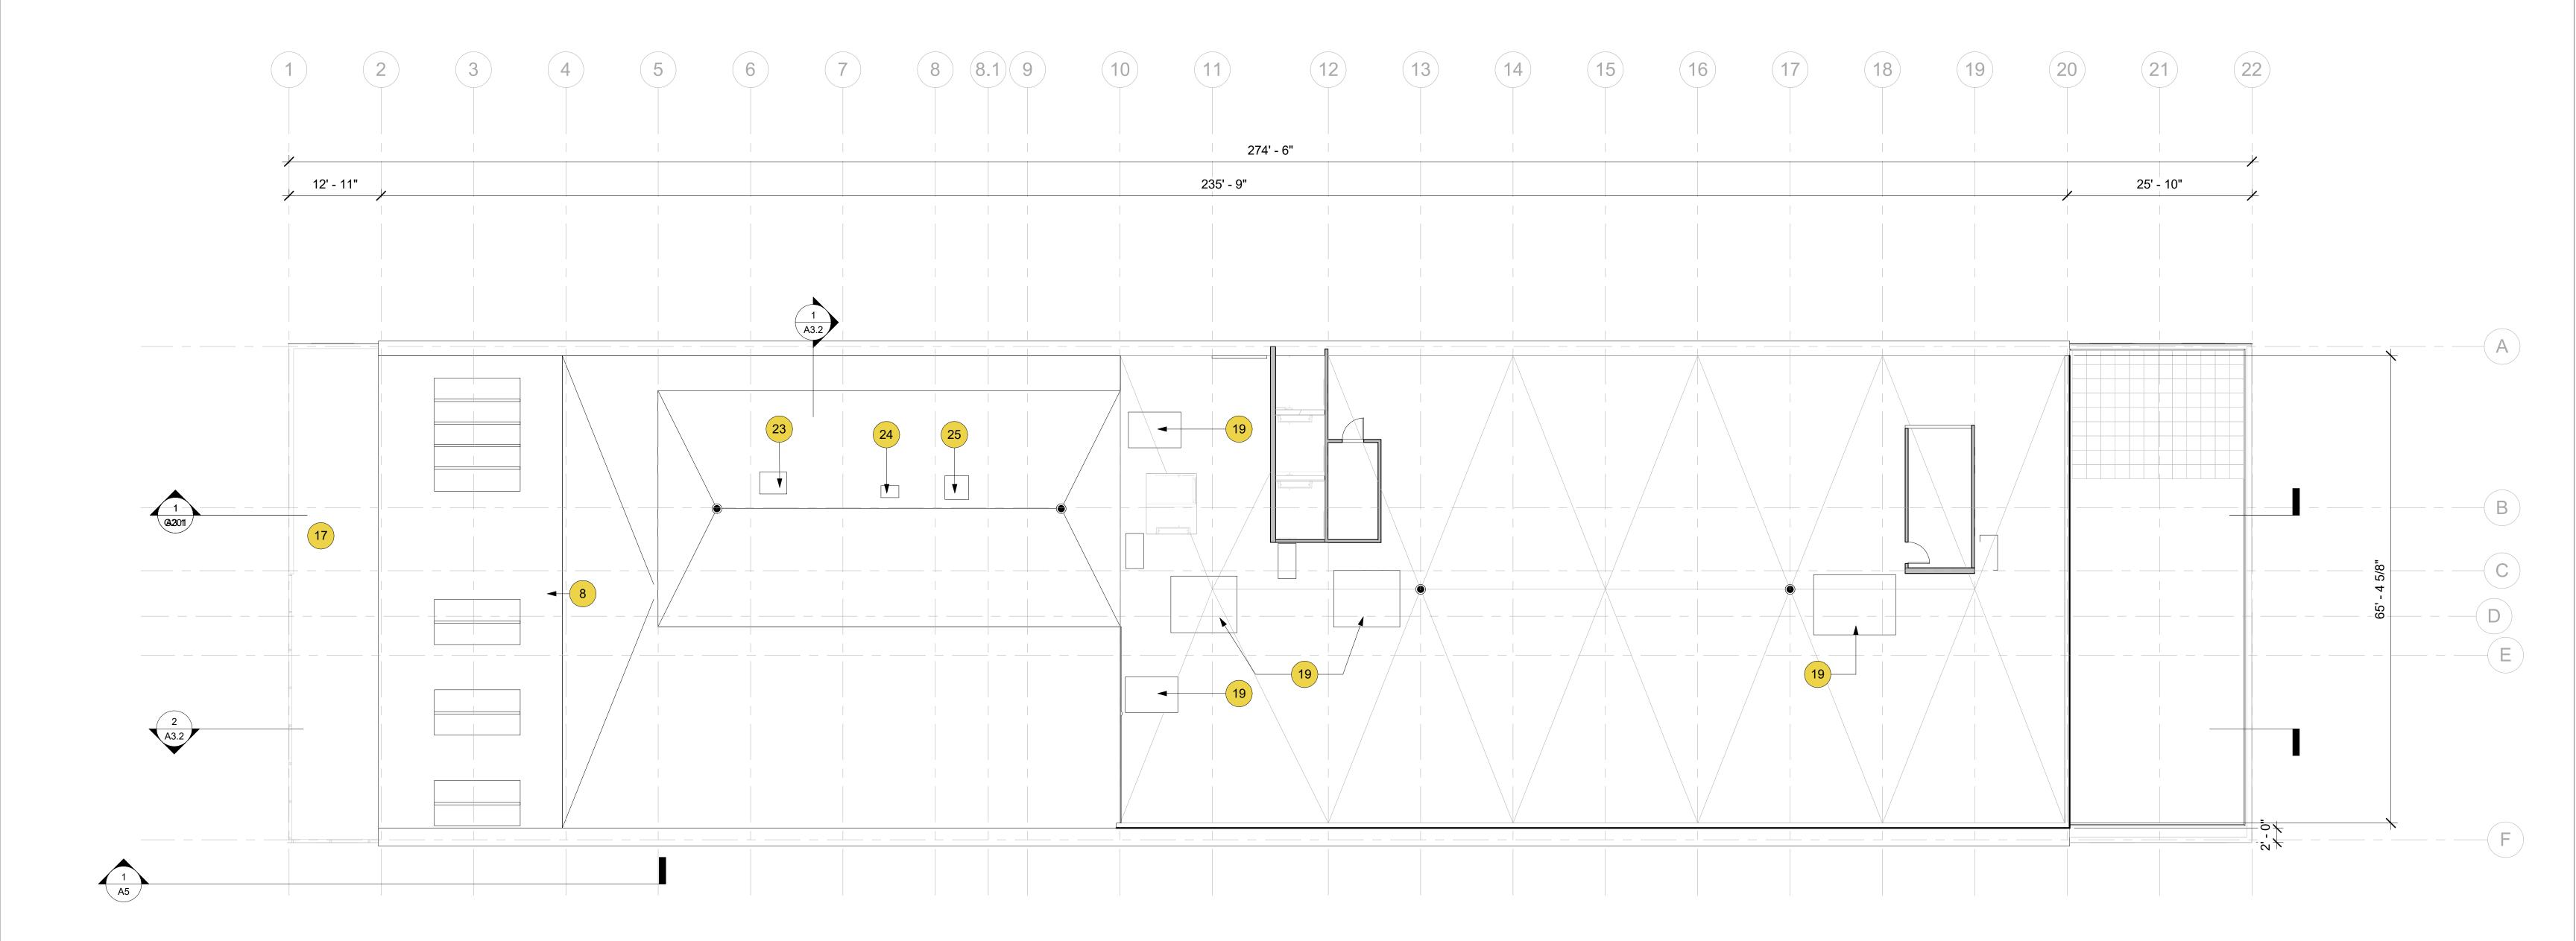

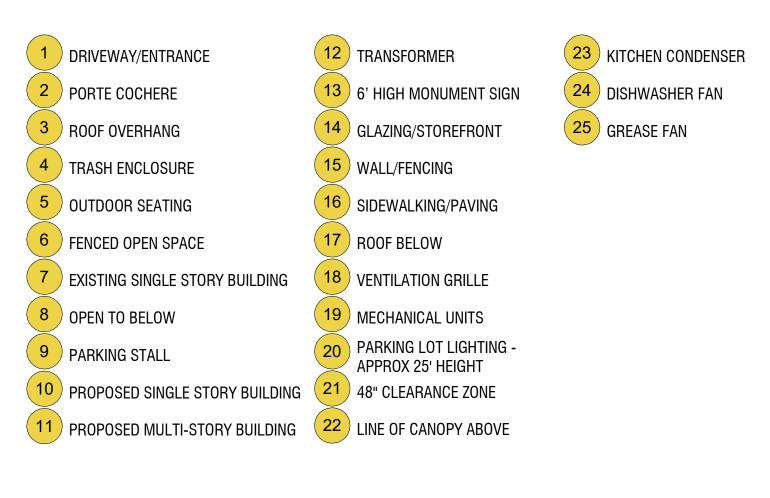

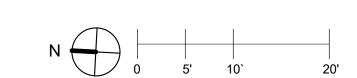







DATE ISSUES & REVISIONS BY
1 02.26.2019 USE PERMIT SUBMITTAL EP
2 06.3.2019 USE PERMIT RESUBMITTAL EP
3 02.01.2021 USE PERMIT RESUBMITTAL EP





TEL 510.836.5400 LINE TOWNEY ARCH COM

HYATT PLACE HOTEL

AIRPORT BOULEVARD AND NORTH LAUGHLIN ROAD SANTA ROSA, CA 95403

OWNER

OWNER OF PROPERTY 999 Main Street, Suite 100 City, CA 94402-1722 Phone: 650.353.5627

ARCHITECT

LOWNEY ARCHITECTURE 360 17th Street, Suite 200 Oakland, CA 94612 Phone: 510.836.5400

STRUCTURAL

STRUCTURAL ENGINEERING, INC. One Post Street, Suite 1050 San Francisco, CA 94104 Phone: 415.781.1505

CIVIL ENGINEERING

EARTH MOVER CIVIL ENGINEERS 4670 Willow Road, Suite 250 Pleasanton, CA 94588 Phone: 925.396.7751

MEI

MECHANICAL ENGINEERING LLC 98 Battery Street, Suite 502 San Francisco, CA 94111 Phone: 415.432.8100


PLANTS & BUSHES, INC.

PLANTS & BUSHES, INC. 2765 Prince Street Berkeley, CA 94705 Phone: 510.547.7748

STAMP



#	DATE	ISSUES & REVISIONS	B,
3	02.01.2021	USE PERMIT RESUB	EF

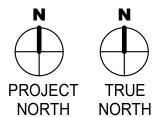

DRAWN BY:
PROJECT NUMB

PROJECT NUMBER:
SHEET ISSUE DATE:
SHEET TITLE:

ENLARGED LOBBY PLAN


00-000

08/05/19

SHEET NUMBER

A1.8

ALL DRAWINGS AND WRITTEN MATERIAL APPEARING HEREIN CONSTITUTE ORIGINAL AND UNPUBLISHED WORK OF THE ARCHITECT AND MAY NOT BE DUPLICATED, USED OR DISCLOSED WITHOUT WRITTEN CONSENT OF THE ARCHITECT

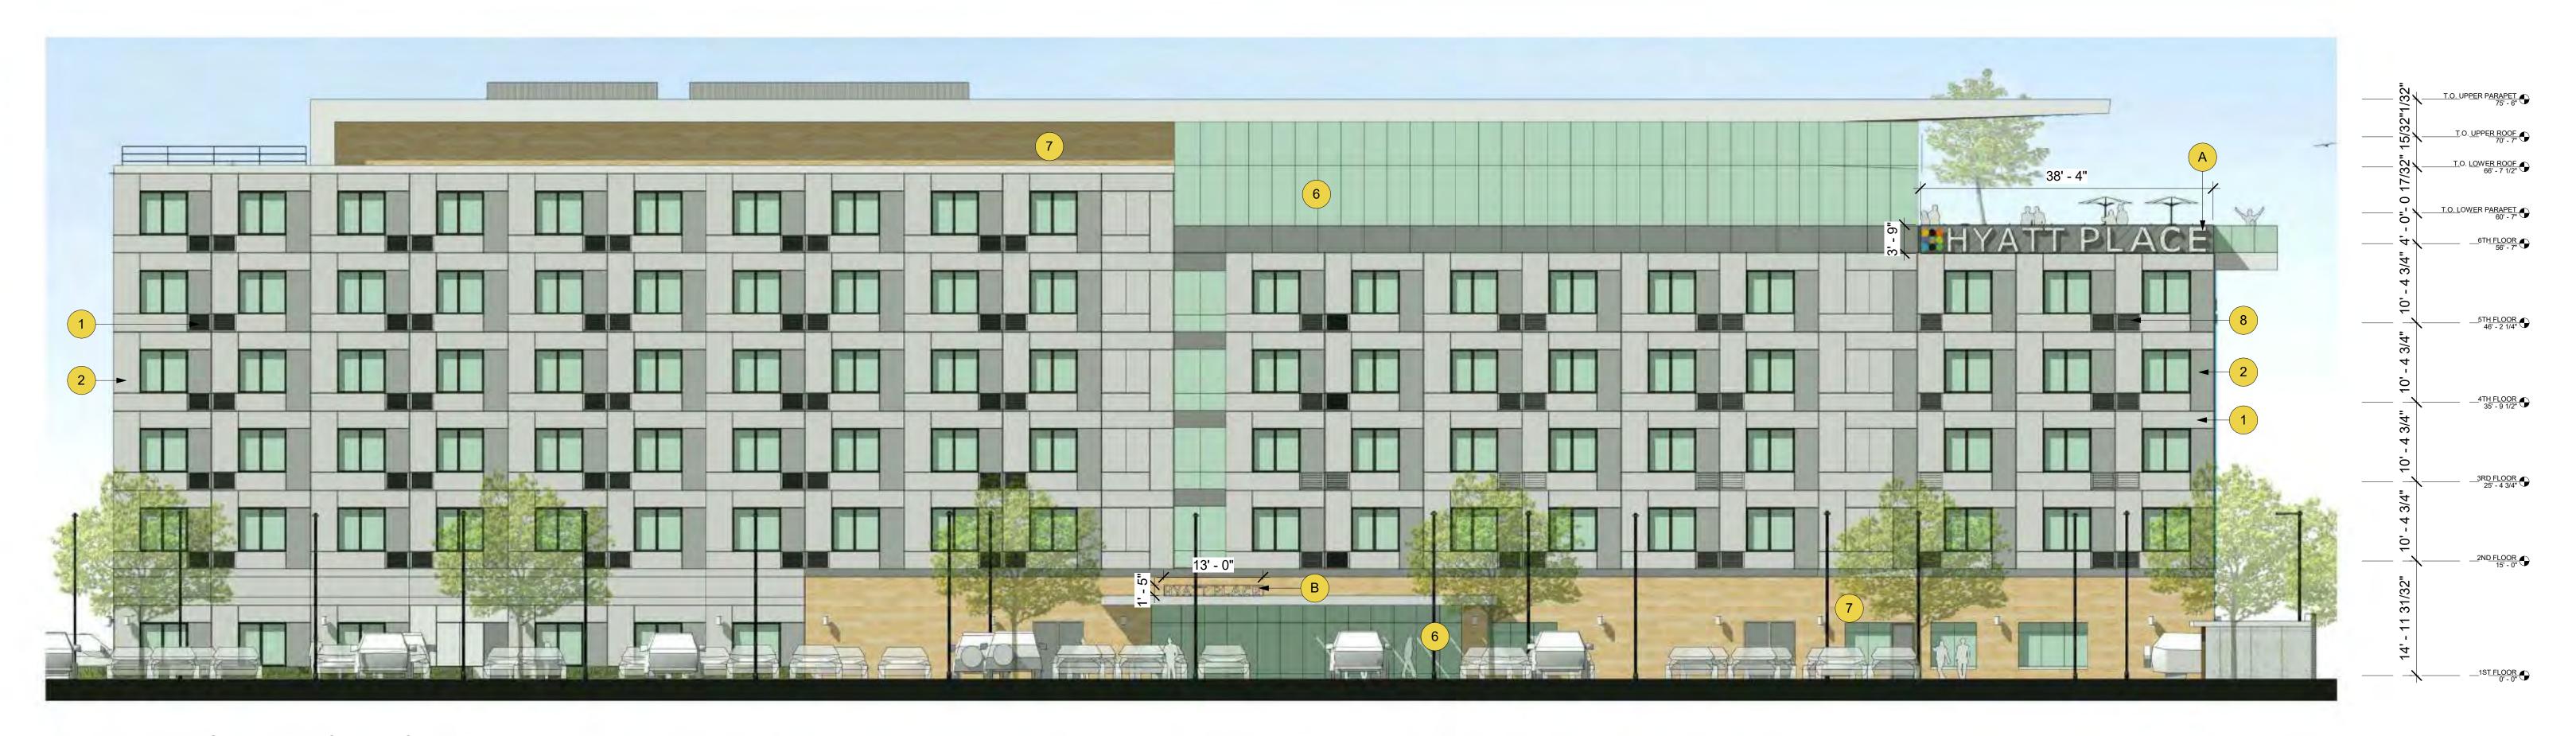

EXTERIOR ELEVATION - EAST



EXTERIOR ELEVATION - NORTH (FACING AIRPORT BOULEVARD)







EXTERIOR ELEVATION - WEST (FACING NORTH LAUGHLIN ROAD)



1 STUCCO - LIGHT
A SIGNAGE A: WALL MOUNTED, 143 SF

2 STUCCO - DARK
B SIGNAGE B: ROOF MOUNTED, 18 SF

3 STUCCO - LIGHT 2
C SIGNAGE C: WALL MOUNTED, 123 SF

4 STEEL PANEL
D SIGNAGE D: WALL MOUNTED, 114 SF

5 EXPOSED CONCRETE PANELS
E SIGNAGE E: WALL MOUNTED, 26 SF

6 GLAZING/STOREFRONT
F SIGNAGE F: WALL MOUNTED, 42 SF

7 TILE/STONE OR PANELLING
G SIGNAGE G: WALL MOUNTED, 146 SF

EXTERIOR ELEVATION - SOUTH






EXTERIOR ELEVATIONS


HYATT PLACE HOTEL

DATE ISSUES & REVISIONS BY
1 02.26.2019 USE PERMIT SUBMITTAL EP
2 06.3.2019 USE PERMIT RESUBMITTAL EP





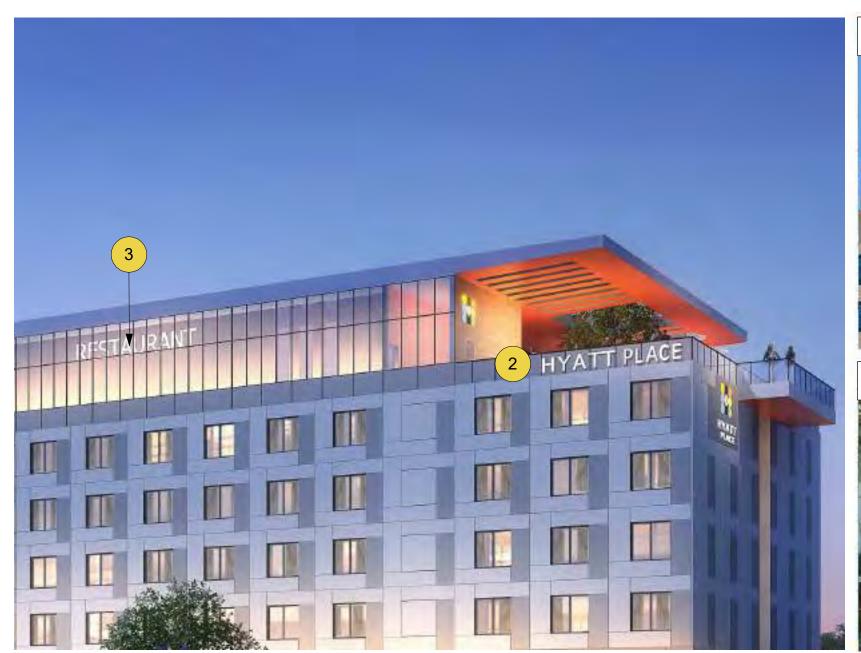

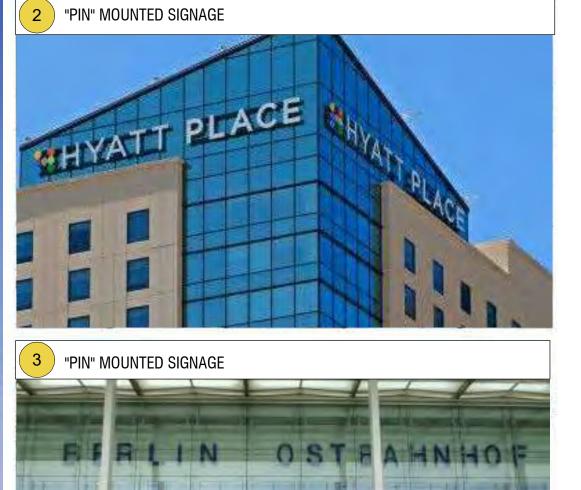






















NORTH - SOUTH SECTION, FACING EAST 1" = 10'-0"







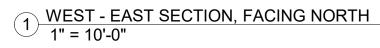




NORTH - SOUTH SECTION, FACING WEST
1" = 10'-0"








2 06.3.2019 USE PERMIT RESUBMITTAL EP 3 02.01.2021 USE PERMIT RESUBMITTAL EP

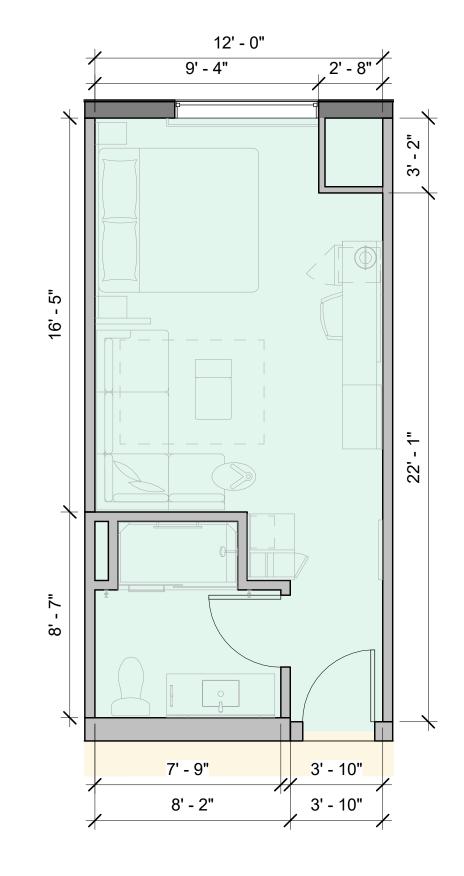


NET AREA: 292 SF GROSS AREA: 335 SF

1 TYPE K-A ENLARGED PLAN 1/4" = 1'-0"

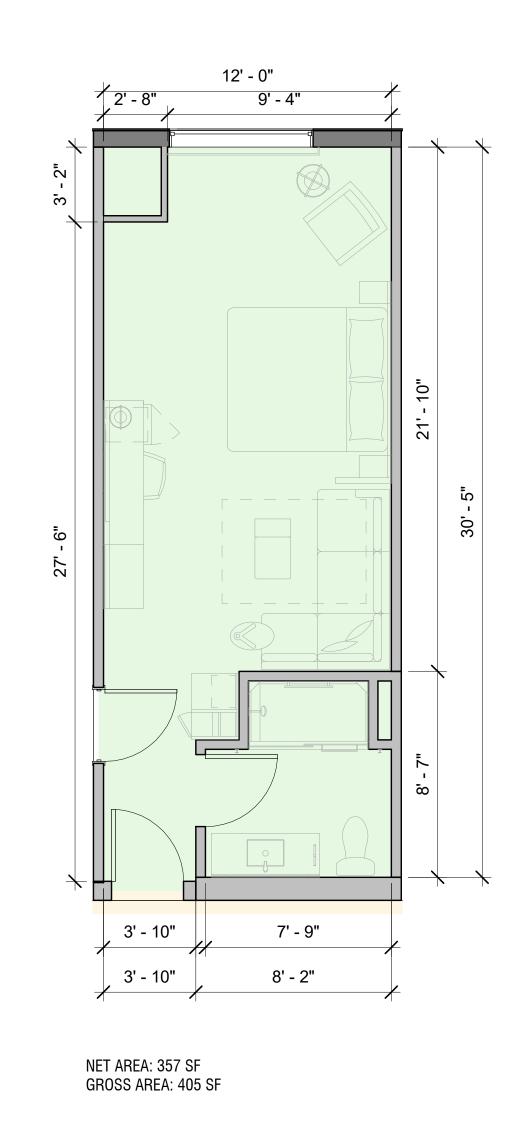


2 TYPE K-B ENLARGED PLAN 1/4" = 1'-0"

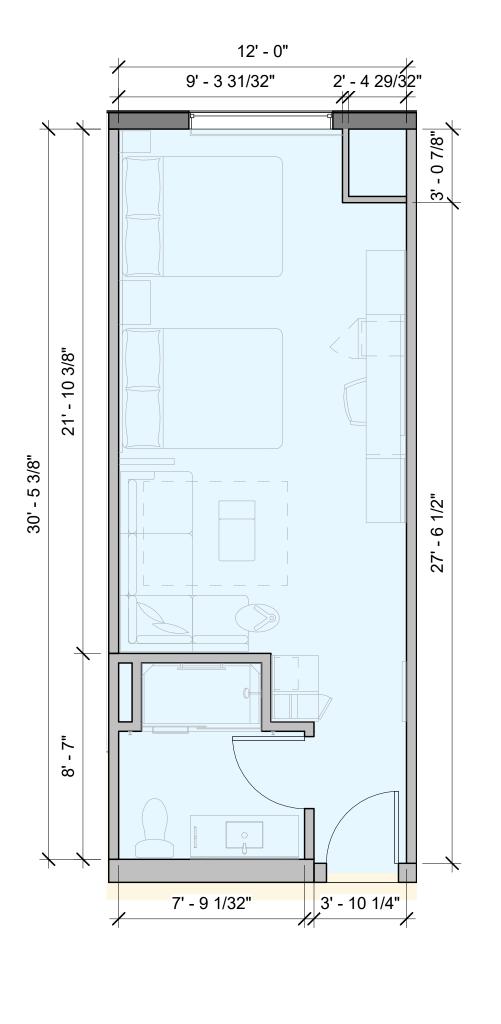

NET AREA: 357 SF GROSS AREA: 405 SF

5 TYPE Q-A ENLARGED PLAN 1/4" = 1'-0"

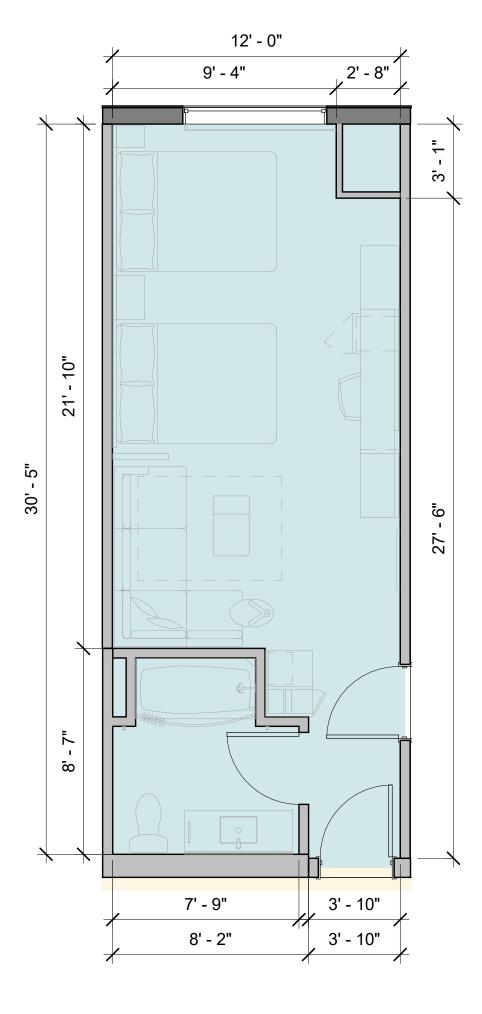

NET AREA: 357 SF GROSS AREA: 406 SF


6 TYPE Q-B ENLARGED PLAN 1/4" = 1'-0"









TYPE K-DC ENLARGED PLAN
1/4" = 1'-0"

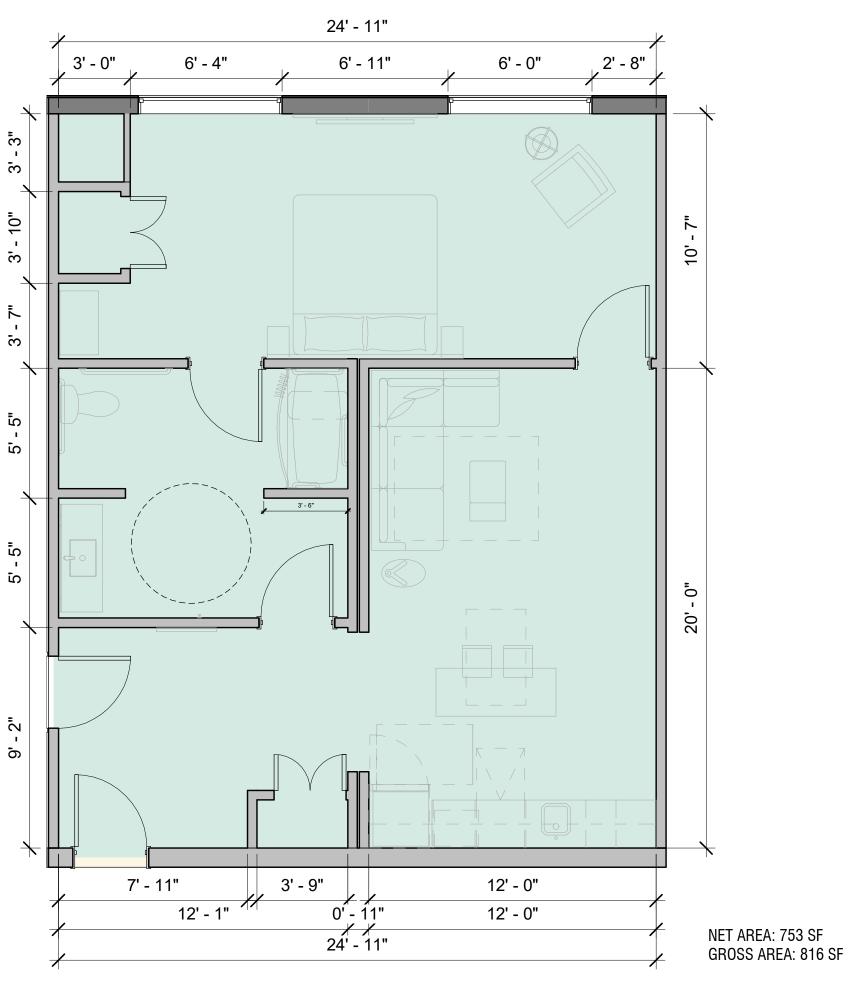


2 TYPE K-D ENLARGED PLAN 1/4" = 1'-0"

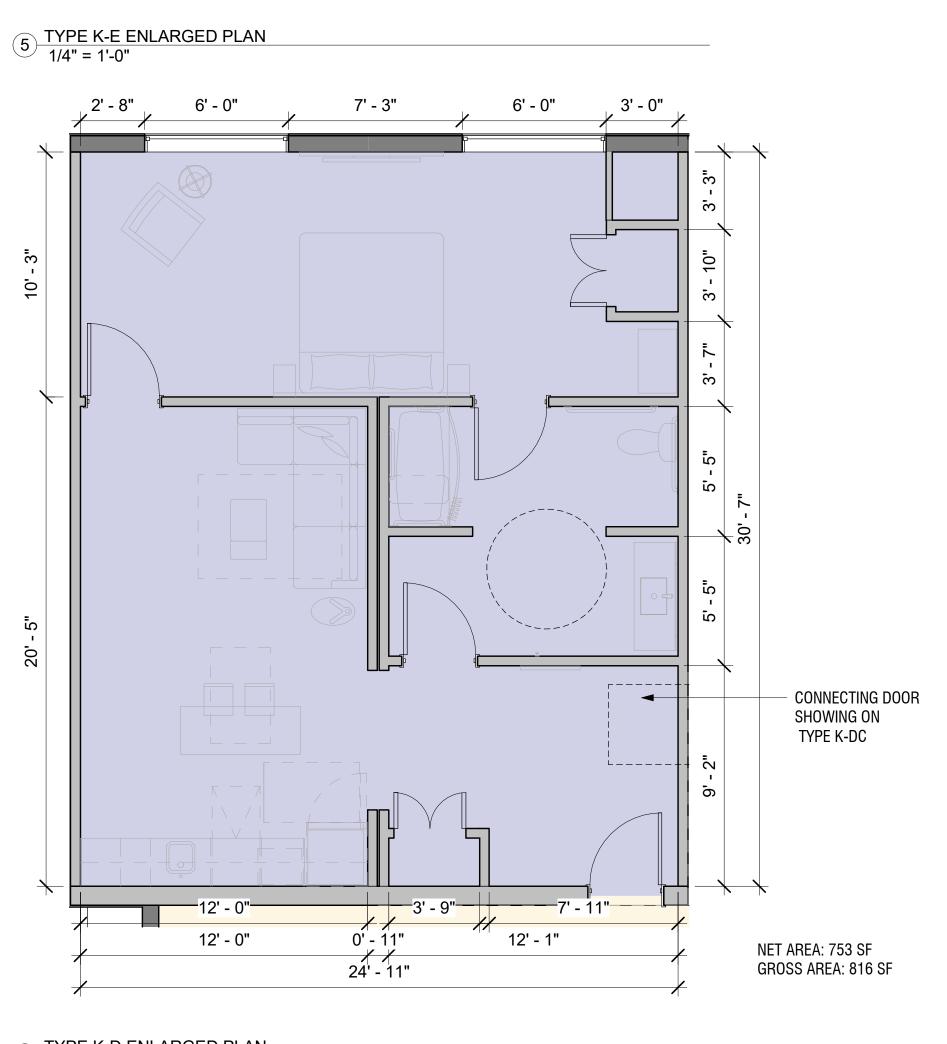

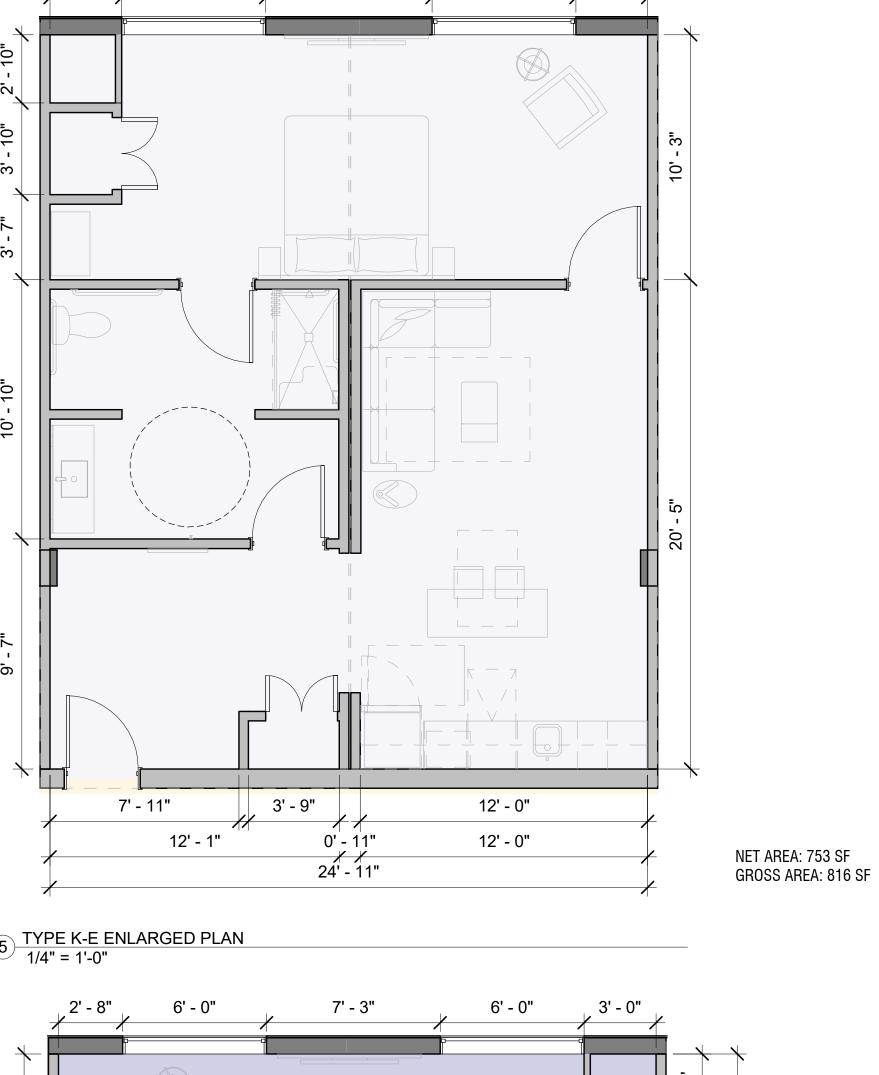


6' - 0"

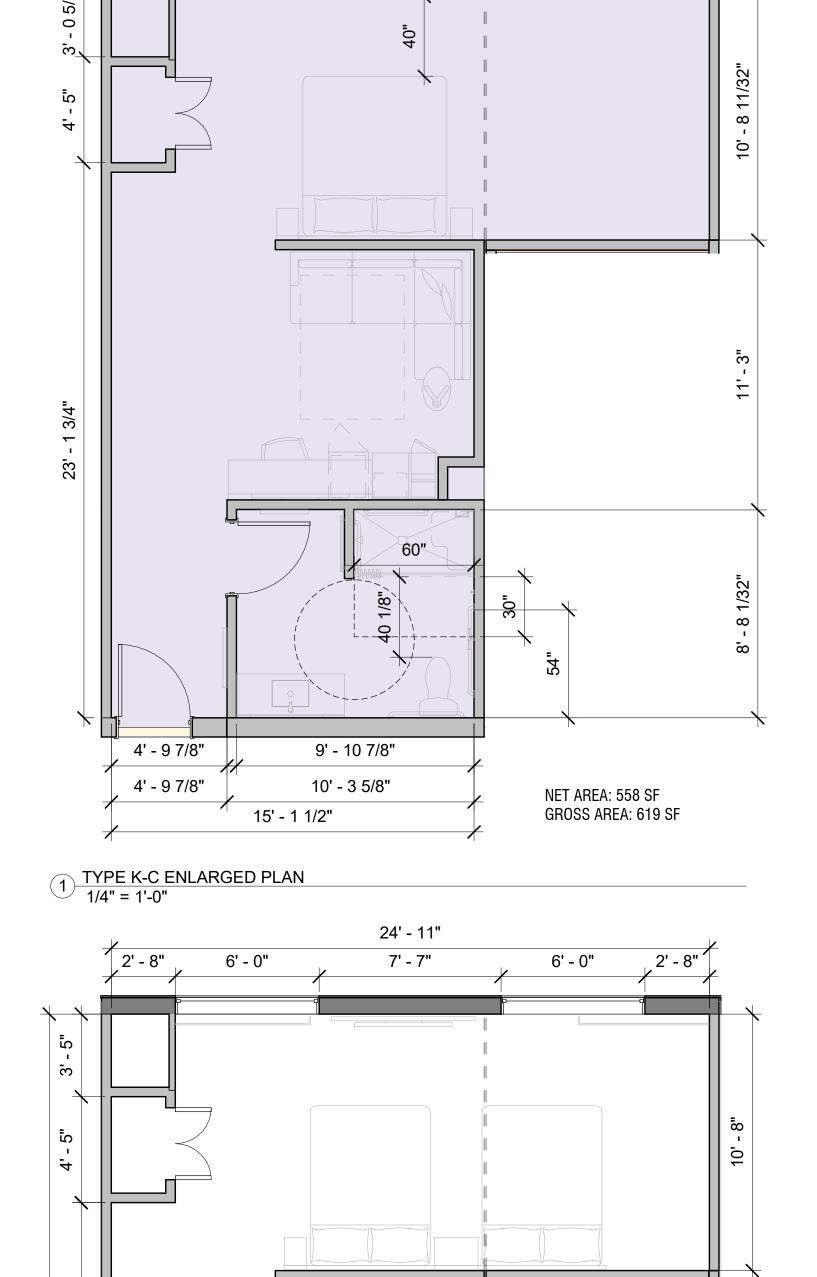

24' - 11 1/4"

7' - 7"

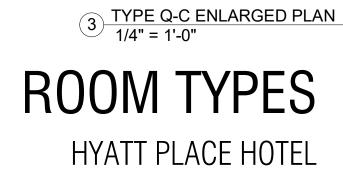

4' - 10"

4' - 10"

DATE ISSUES & REVISIONS BY
1 02.26.2019 USE PERMIT SUBMITTAL EP
2 06.3.2019 USE PERMIT RESUBMITTAL EP
3 02.01.2021 USE PERMIT RESUBMITTAL EP

NET AREA: 558 SF GROSS AREA: 619 SF


9' - 11"


10' - 4"

MATERIALS					
IMAGE	SYMBOL	DESCRIPTION	NOTES		
	P-1	PAVING 1 Stone pavers, mortar- set	Concrete base		
	P-2	PAVING 2 Concrete pavers, sand - set	Permeable joints over gravel base		
	P-3	PAVING 3 Gravel			
	P-4	PAVING 4 Concrete	Integral color		
	W-1	BIORETENTION PLANTER WALL	Concrete wall with stone cladding		
	A-1	PLANTER POTS	By Atelier Vierkant, www.ateliervierkant,com or equivalent		
	A-2	BIKE RACK	"Bola" model by Forms and Surfaces, www.formsandsurfaces.com, silver powder coat		
	A-3	BENCH	"Giada 2407" model by ID Metalco, https://idcreated.com		
	G-1	FENCE AND GATE	Galvanized and powder coated steel		





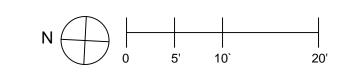

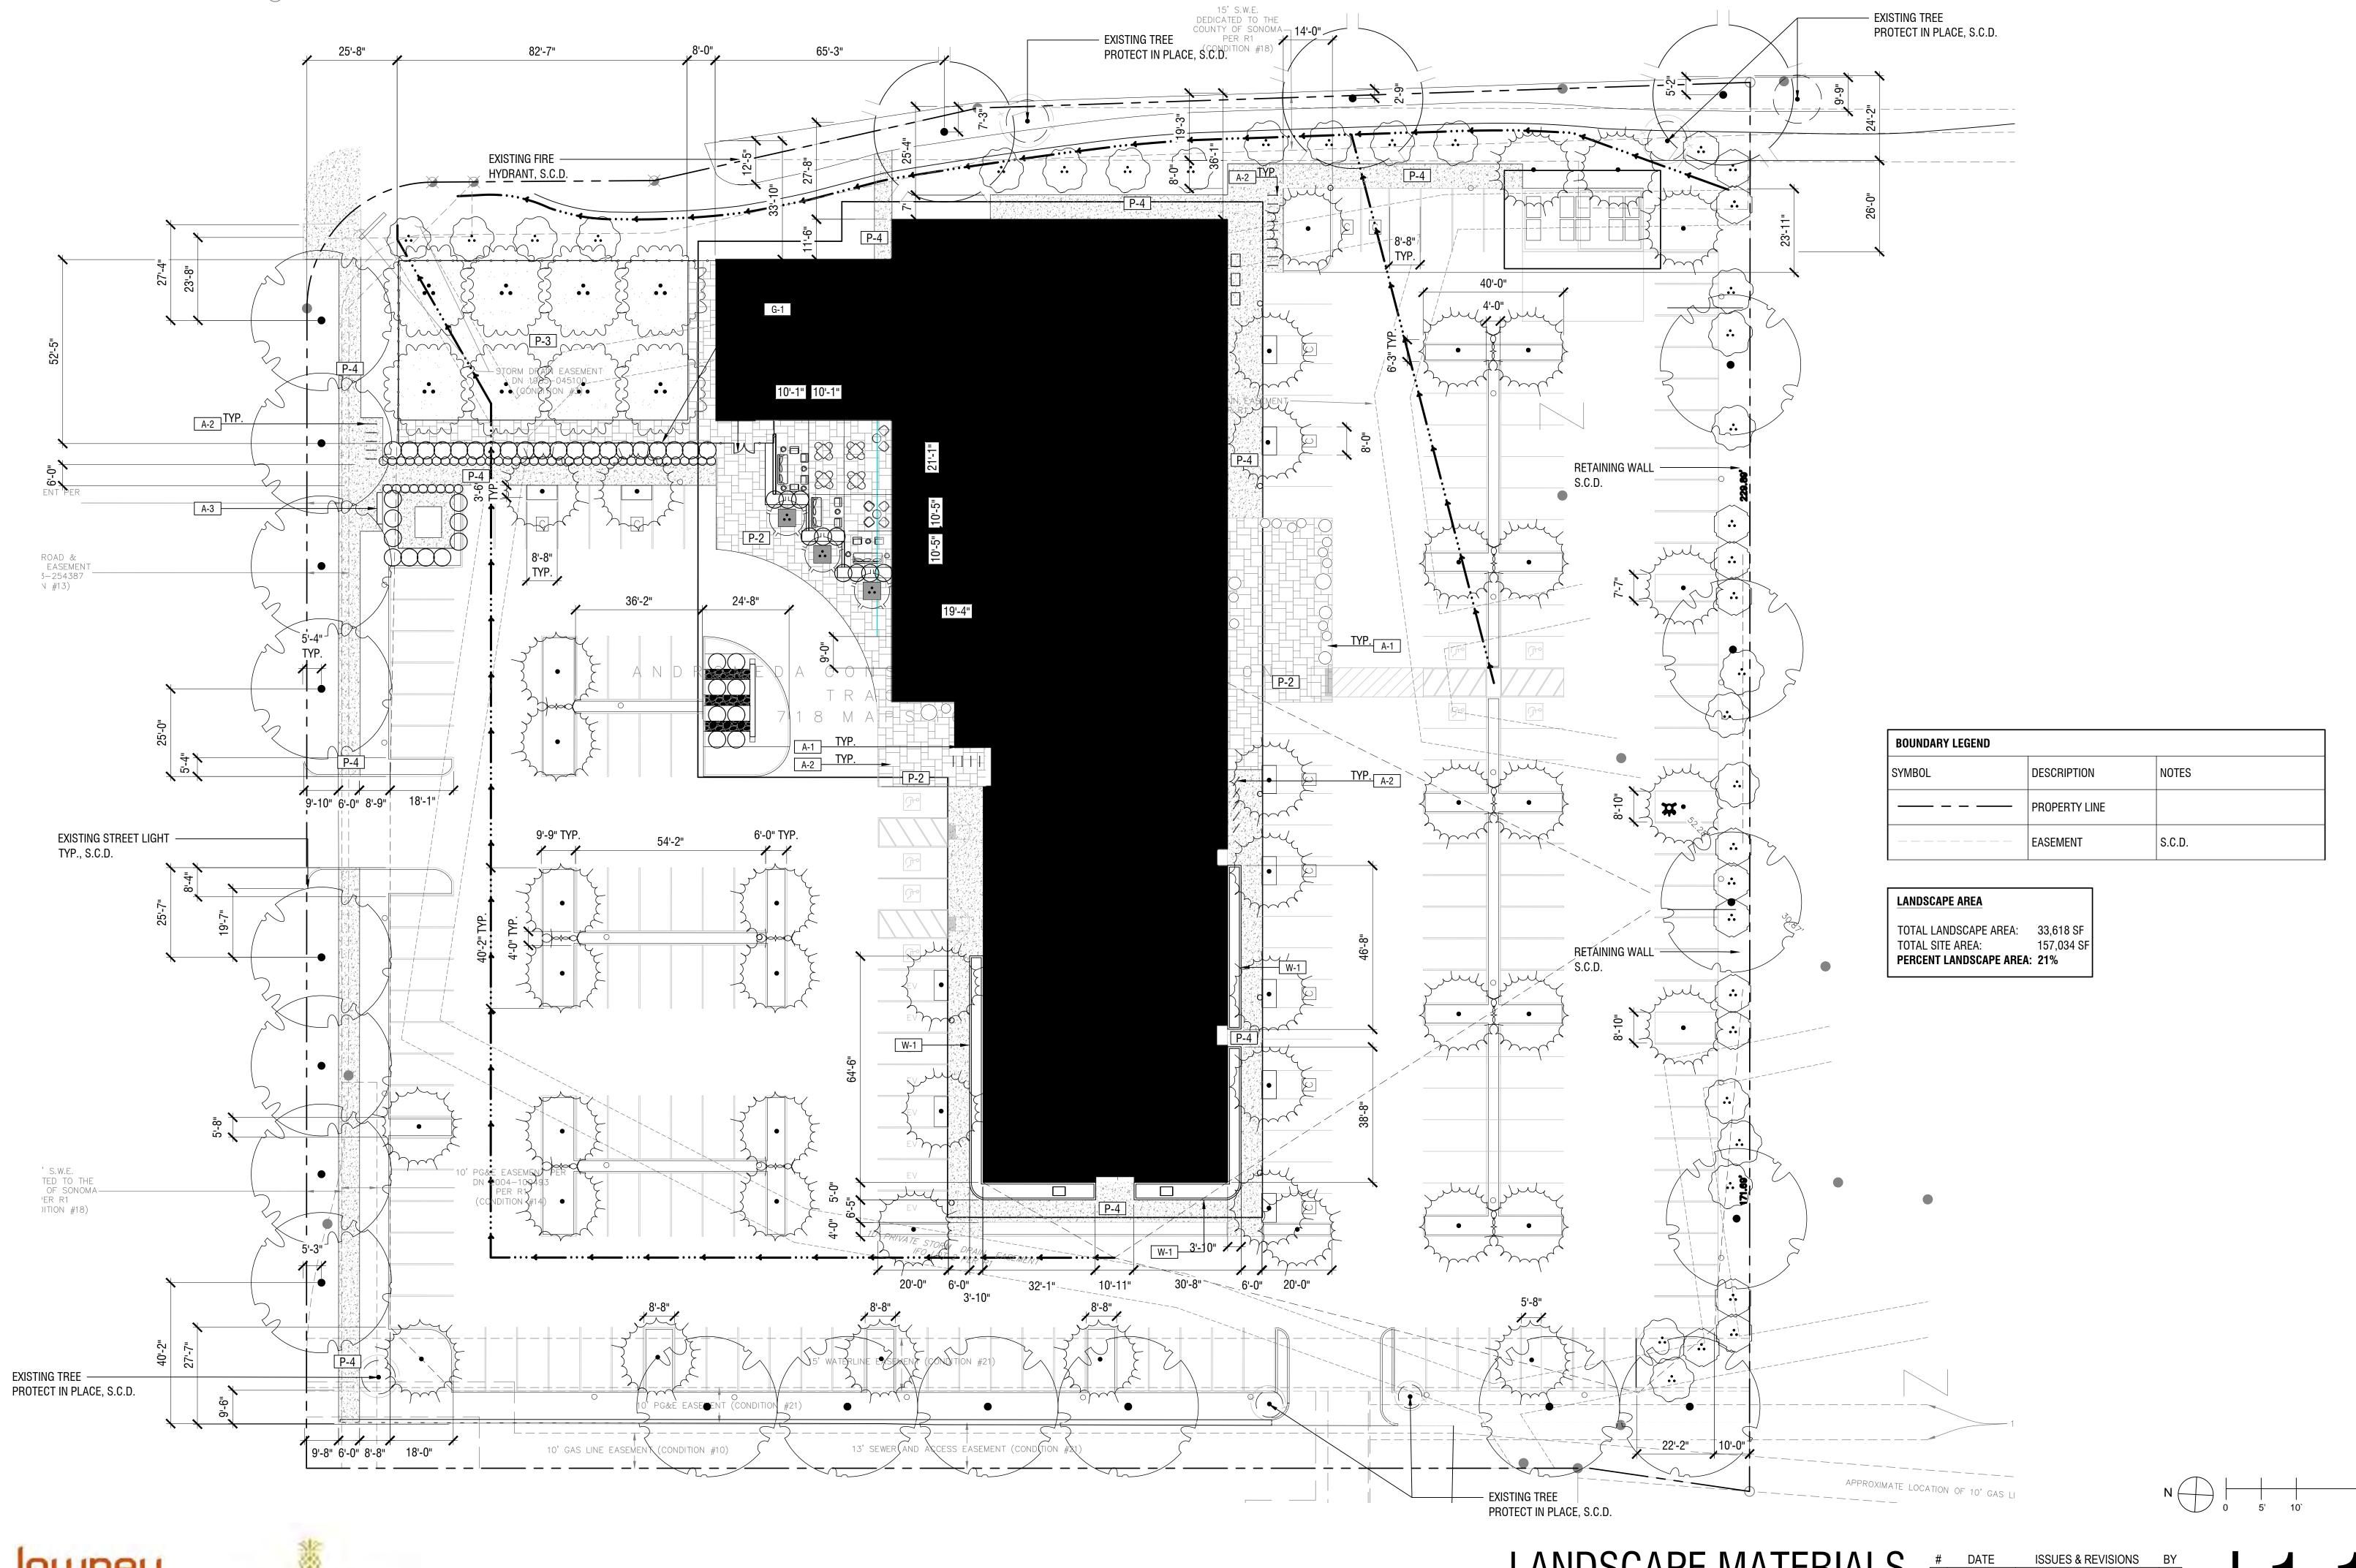







LANDSCAPE MATERIALS
HYATT PLACE HOTEL

#	DATE	ISSUES & REVISIONS	BY
1	02/26/2019	USE PERMIT SUBMITTAL	JI
2	05/14/2019	USE PERMIT RESUBMITTAL	JI
3	02/01/2021	USE PERMIT RESUBMITTAL	JI

TREES						
SYMBOL	IMAGE	BOTANICAL NAME / COMMON NAME	SIZE	TRUNK	WUCOLS	NOTES
		Arctostaphylos bakeri 'Louis Edmunds' / Louis Edmunds Manzanita	15 gal	Multi	Low	60-120' H X 20-25' W
July Company of the C		Chionanthus retusus / Chinese Fringe Tree	24" Box	Standard	Moderate	20-25' H X 15' W
·		Heteromeles arbutifolia/ Toyon	15 gal	Multi	Low	10-15' H x 10-20' W
€ ·• }		Olea europea 'Swan Hill' / Olive	24" Box	Multi	Very Low	40-45' H x 20-30' W
		Platanus racemosa / Western Sycamore	24" Box	Standard	Moderate	30-35' H X 18-20' W
		Existing tree, species varies				Protect in place

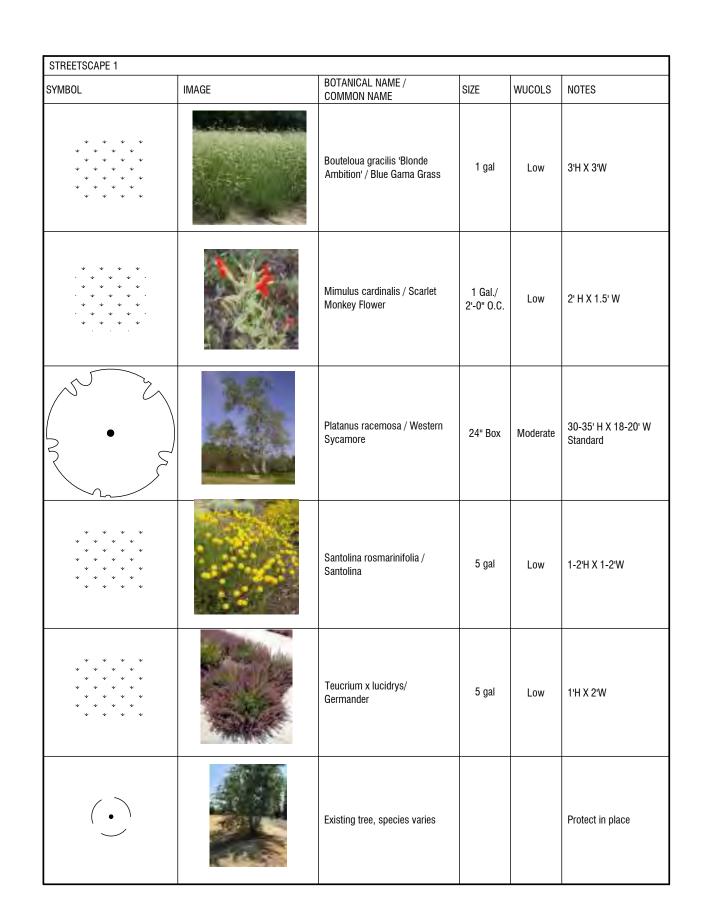

SYMBOL	IMAGE	BOTANICAL NAME / COMMON NAME	SIZE	WUCOLS	NOTES
		Calamagrostis x acutifolia 'Karl Foester' / Feather Reed Grass	5 Gal./ x'-0" O.C.	Moderate	2-3' H X W, 6' Flower
		Carex praegracilis / California field sedge	1 gal	Moderate	2-3' H X 2-3' W
3 · E	lla de	Chionanthus retusus / Chinese Fringe Tree	24" Box	Moderate	20-25' H X 15'W Standard
		Mimulus cardinalis / Scarlet Monkey Flower	1 Gal./ 2'-0" O.C.	Low	2' H X 1.5' W
		Santolina rosmarinifolia / Santolina	1 Gal. / x'-0" O.C.	Low	1' H x 3-4' W

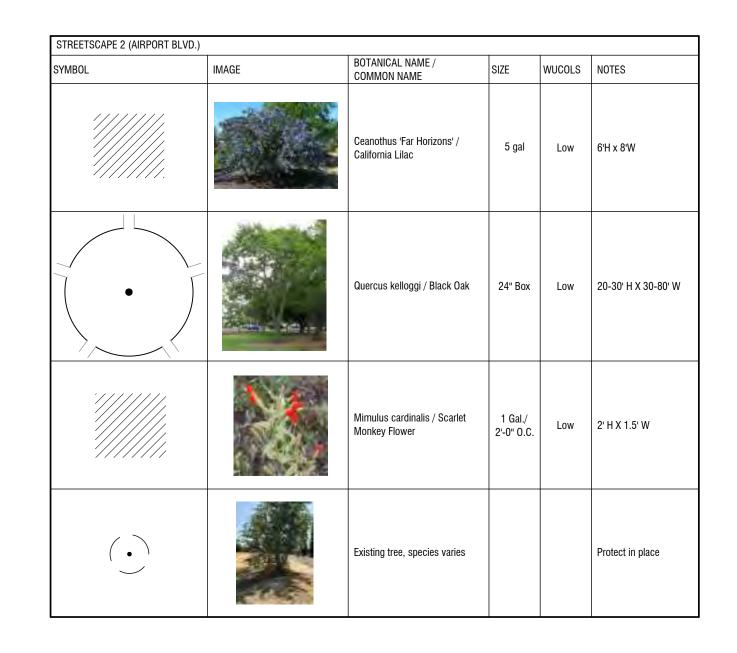

SYMBOL	IMAGE	BOTANICAL NAME / COMMON NAME	SIZE	WUCOLS	NOTES
000000000000000000000000000000000000000		Ceanothus 'Far Horizons'	5 gal	Low	6' H X 8 'W
000000 000000 0000000 0000000 0000000		Erigonum fasciculatum / California buckwheat	1 gal	Low	2-3' H X 4' W
· ·		Heteromeles arbutifolia/ Toyon	15 gal	Low	10-15' H X 10-20' W Multi-trunk


GREEN WALL SYMBOL	IMAGE	BOTANICAL NAME / COMMON NAME	SIZE	WUCOLS	NOTES
~~~~		Ficus pumlia repens	15 gal	Moderate	

SYMBOL	IMAGE	BOTANICAL NAME / COMMON NAME	SIZE	WUCOLS	NOTES
		Arctostaphylos bakeri 'Louis Edmunds' / Louis Edmunds Manzanita	15 gal	Low	60-120' H X 20-25' V Multi trunk
		Lavandula intermedia 'Provence' /Blue Lavandin	1 Gal. / 3'-0" O.C.	Low	1-2' H x 2-3' W
		Myrica californica / Pacific Wax Myrtle	1 Gal. / x'-0" O.C.	Low	1-2' H x 2-3' W
		Olea europea 'Swan Hill' / Olive	24" Box	Very Low	40-45' H x 20-30' W Multi trunk
		Rosmarinus officionalis 'Tuscan Blue' / Tuscan Blue Rosemary	1 Gal. / 3'-0" O.C.	Low	6' H X 2-4' W
		Thymus 'Silver Anniversary'	1 Gal. / 1'-0" O.C.	Low	1' H X 1' W

WETLAND FEATURE PLANTING	3				
SYMBOL	IMAGE	BOTANICAL NAME / COMMON NAME	SIZE	WUCOLS	NOTES
		Carex albula / Frosty Curls Sedge	5 Gal. / x'-0" O.C.	Moderate	2' H x 2' W
		Cornus sericea / Red Twig Dogwood	5 Gal./ x'-0" O.C.	High	7-9' H x 10' W
		Heuchera maxima / Island Alum Root	1 Gal. / x'-0" O.C.	Low	2' W X 2-3' H, flower





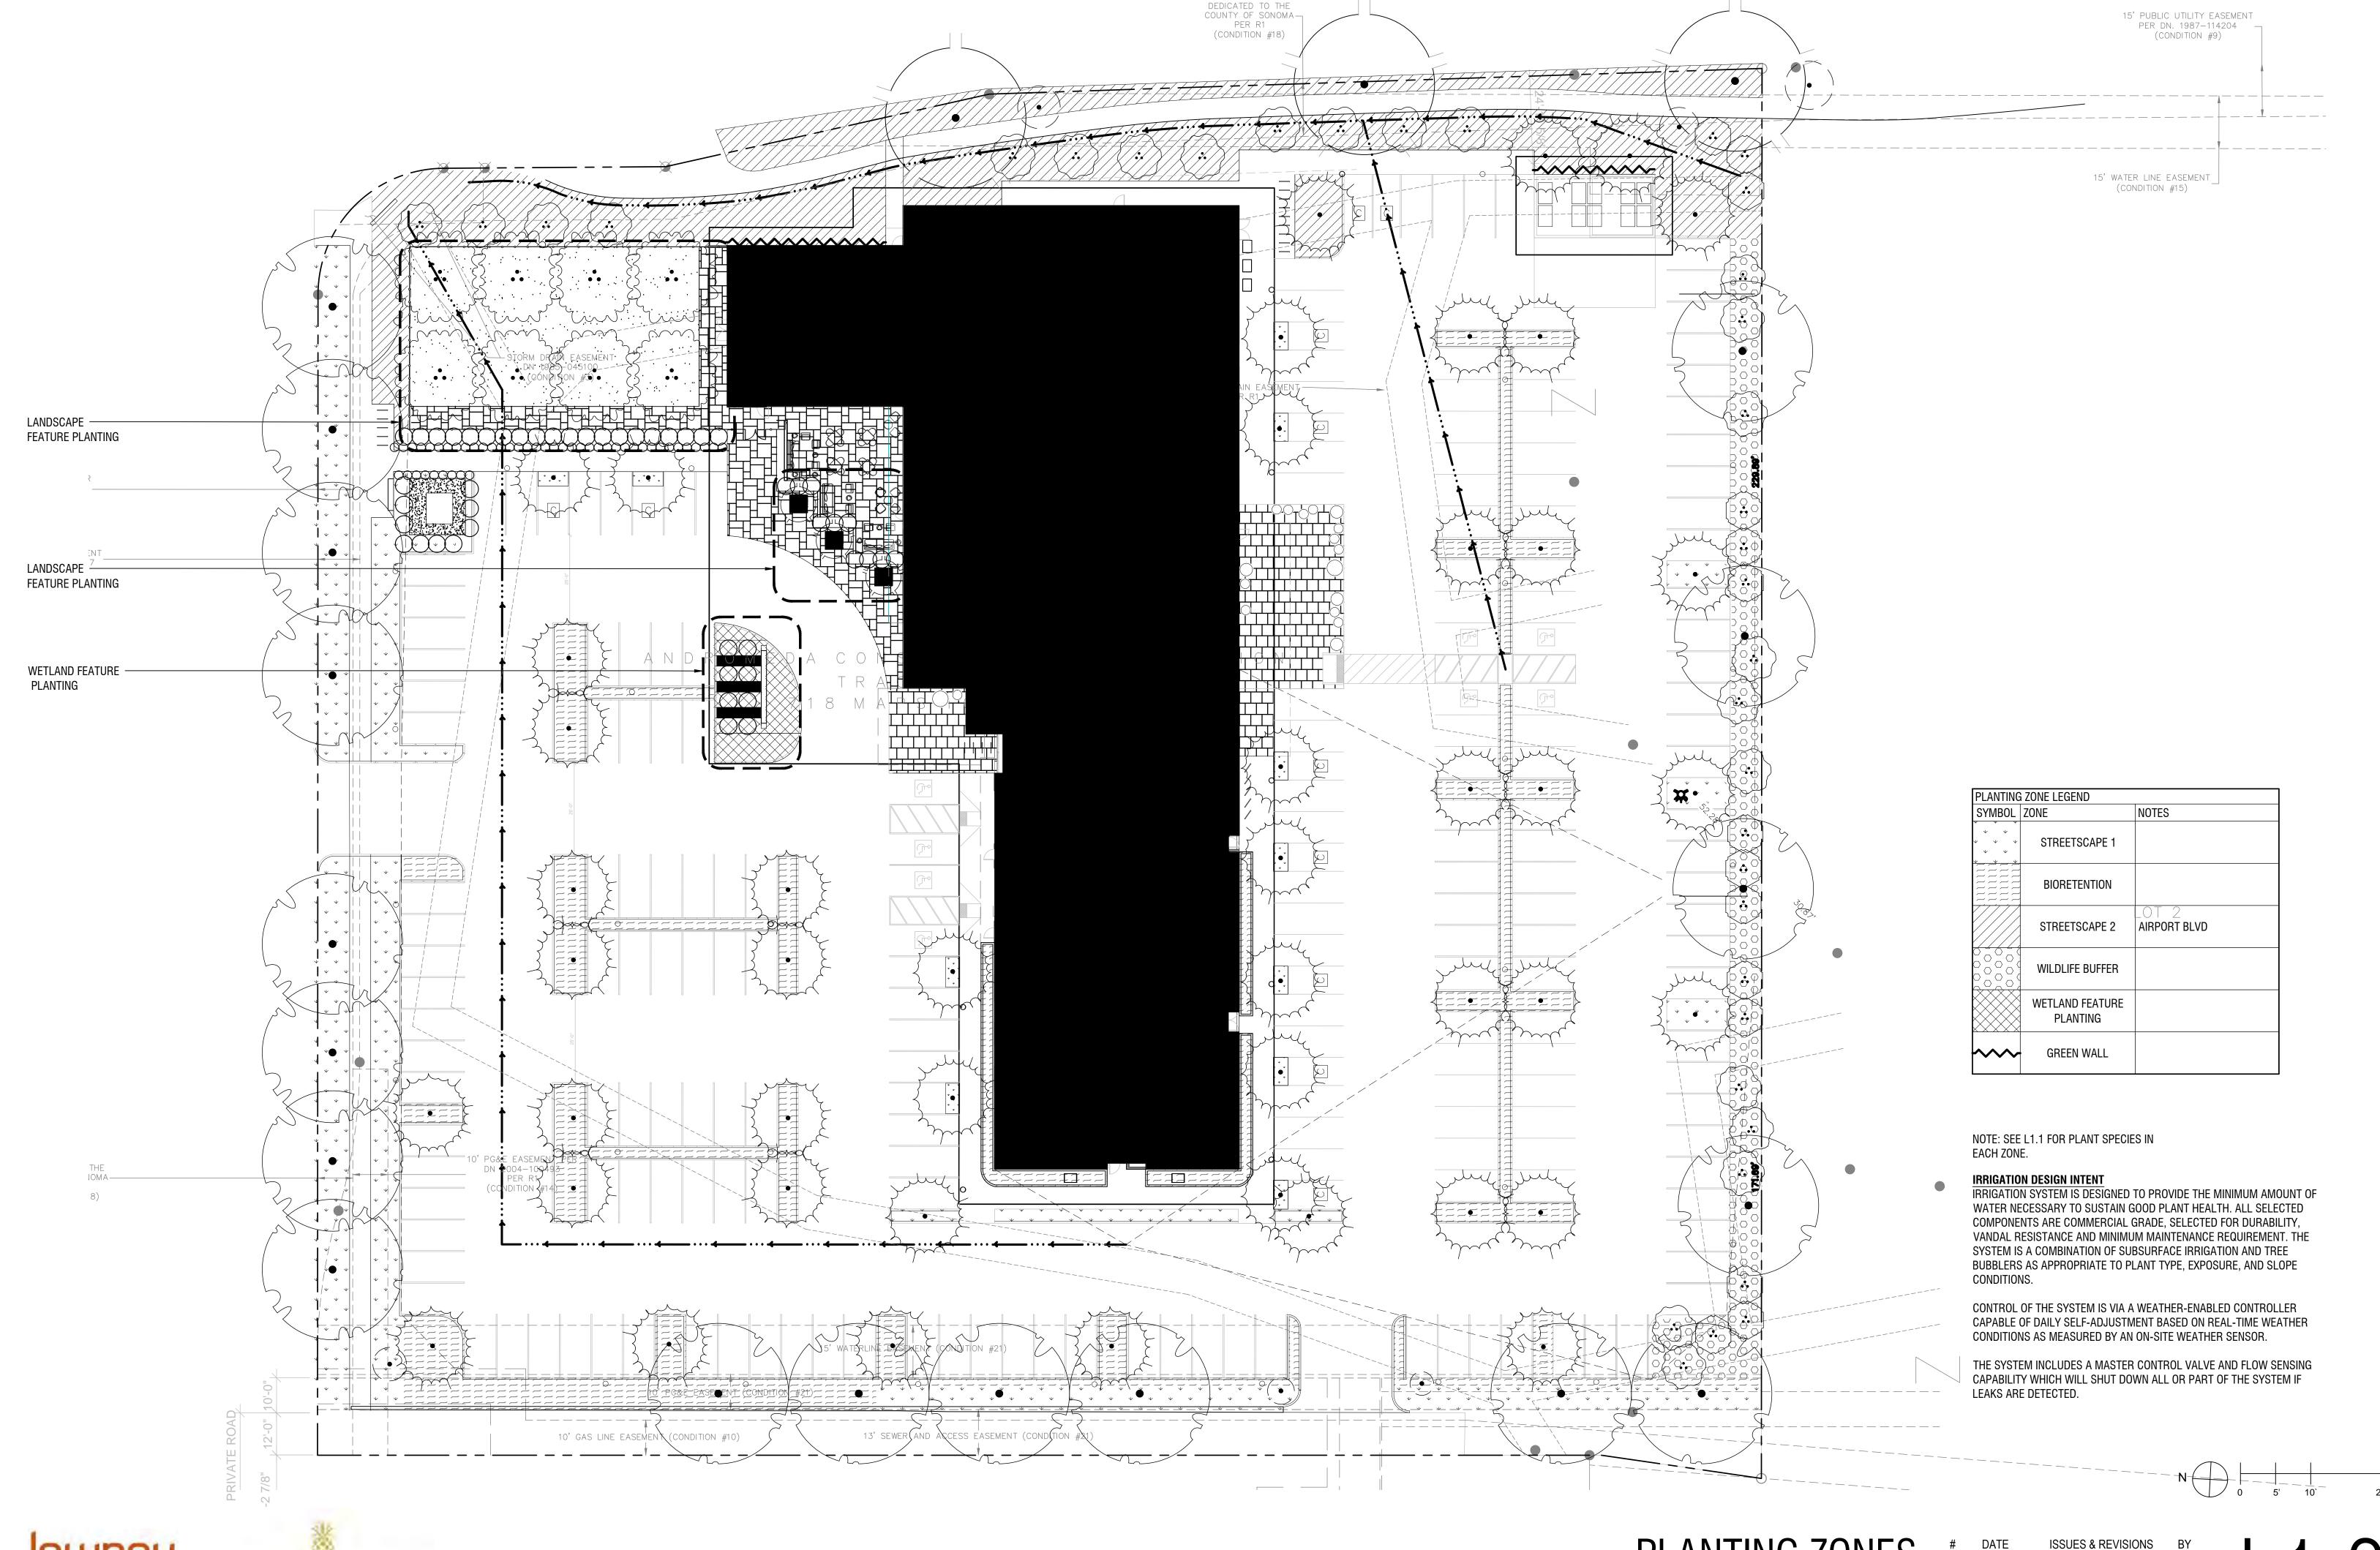






PLANTING ZONES

HYATT PLACE HOTEL

#	DATE	ISSUES & REVISIONS	BY
1	02/26/2019	USE PERMIT SUBMITTAL	JI
2	05/14/2019	USE PERMIT RESUBMITTAL	JI
3	02/01/2020	USE PERMIT RESUBMITTAL	JI

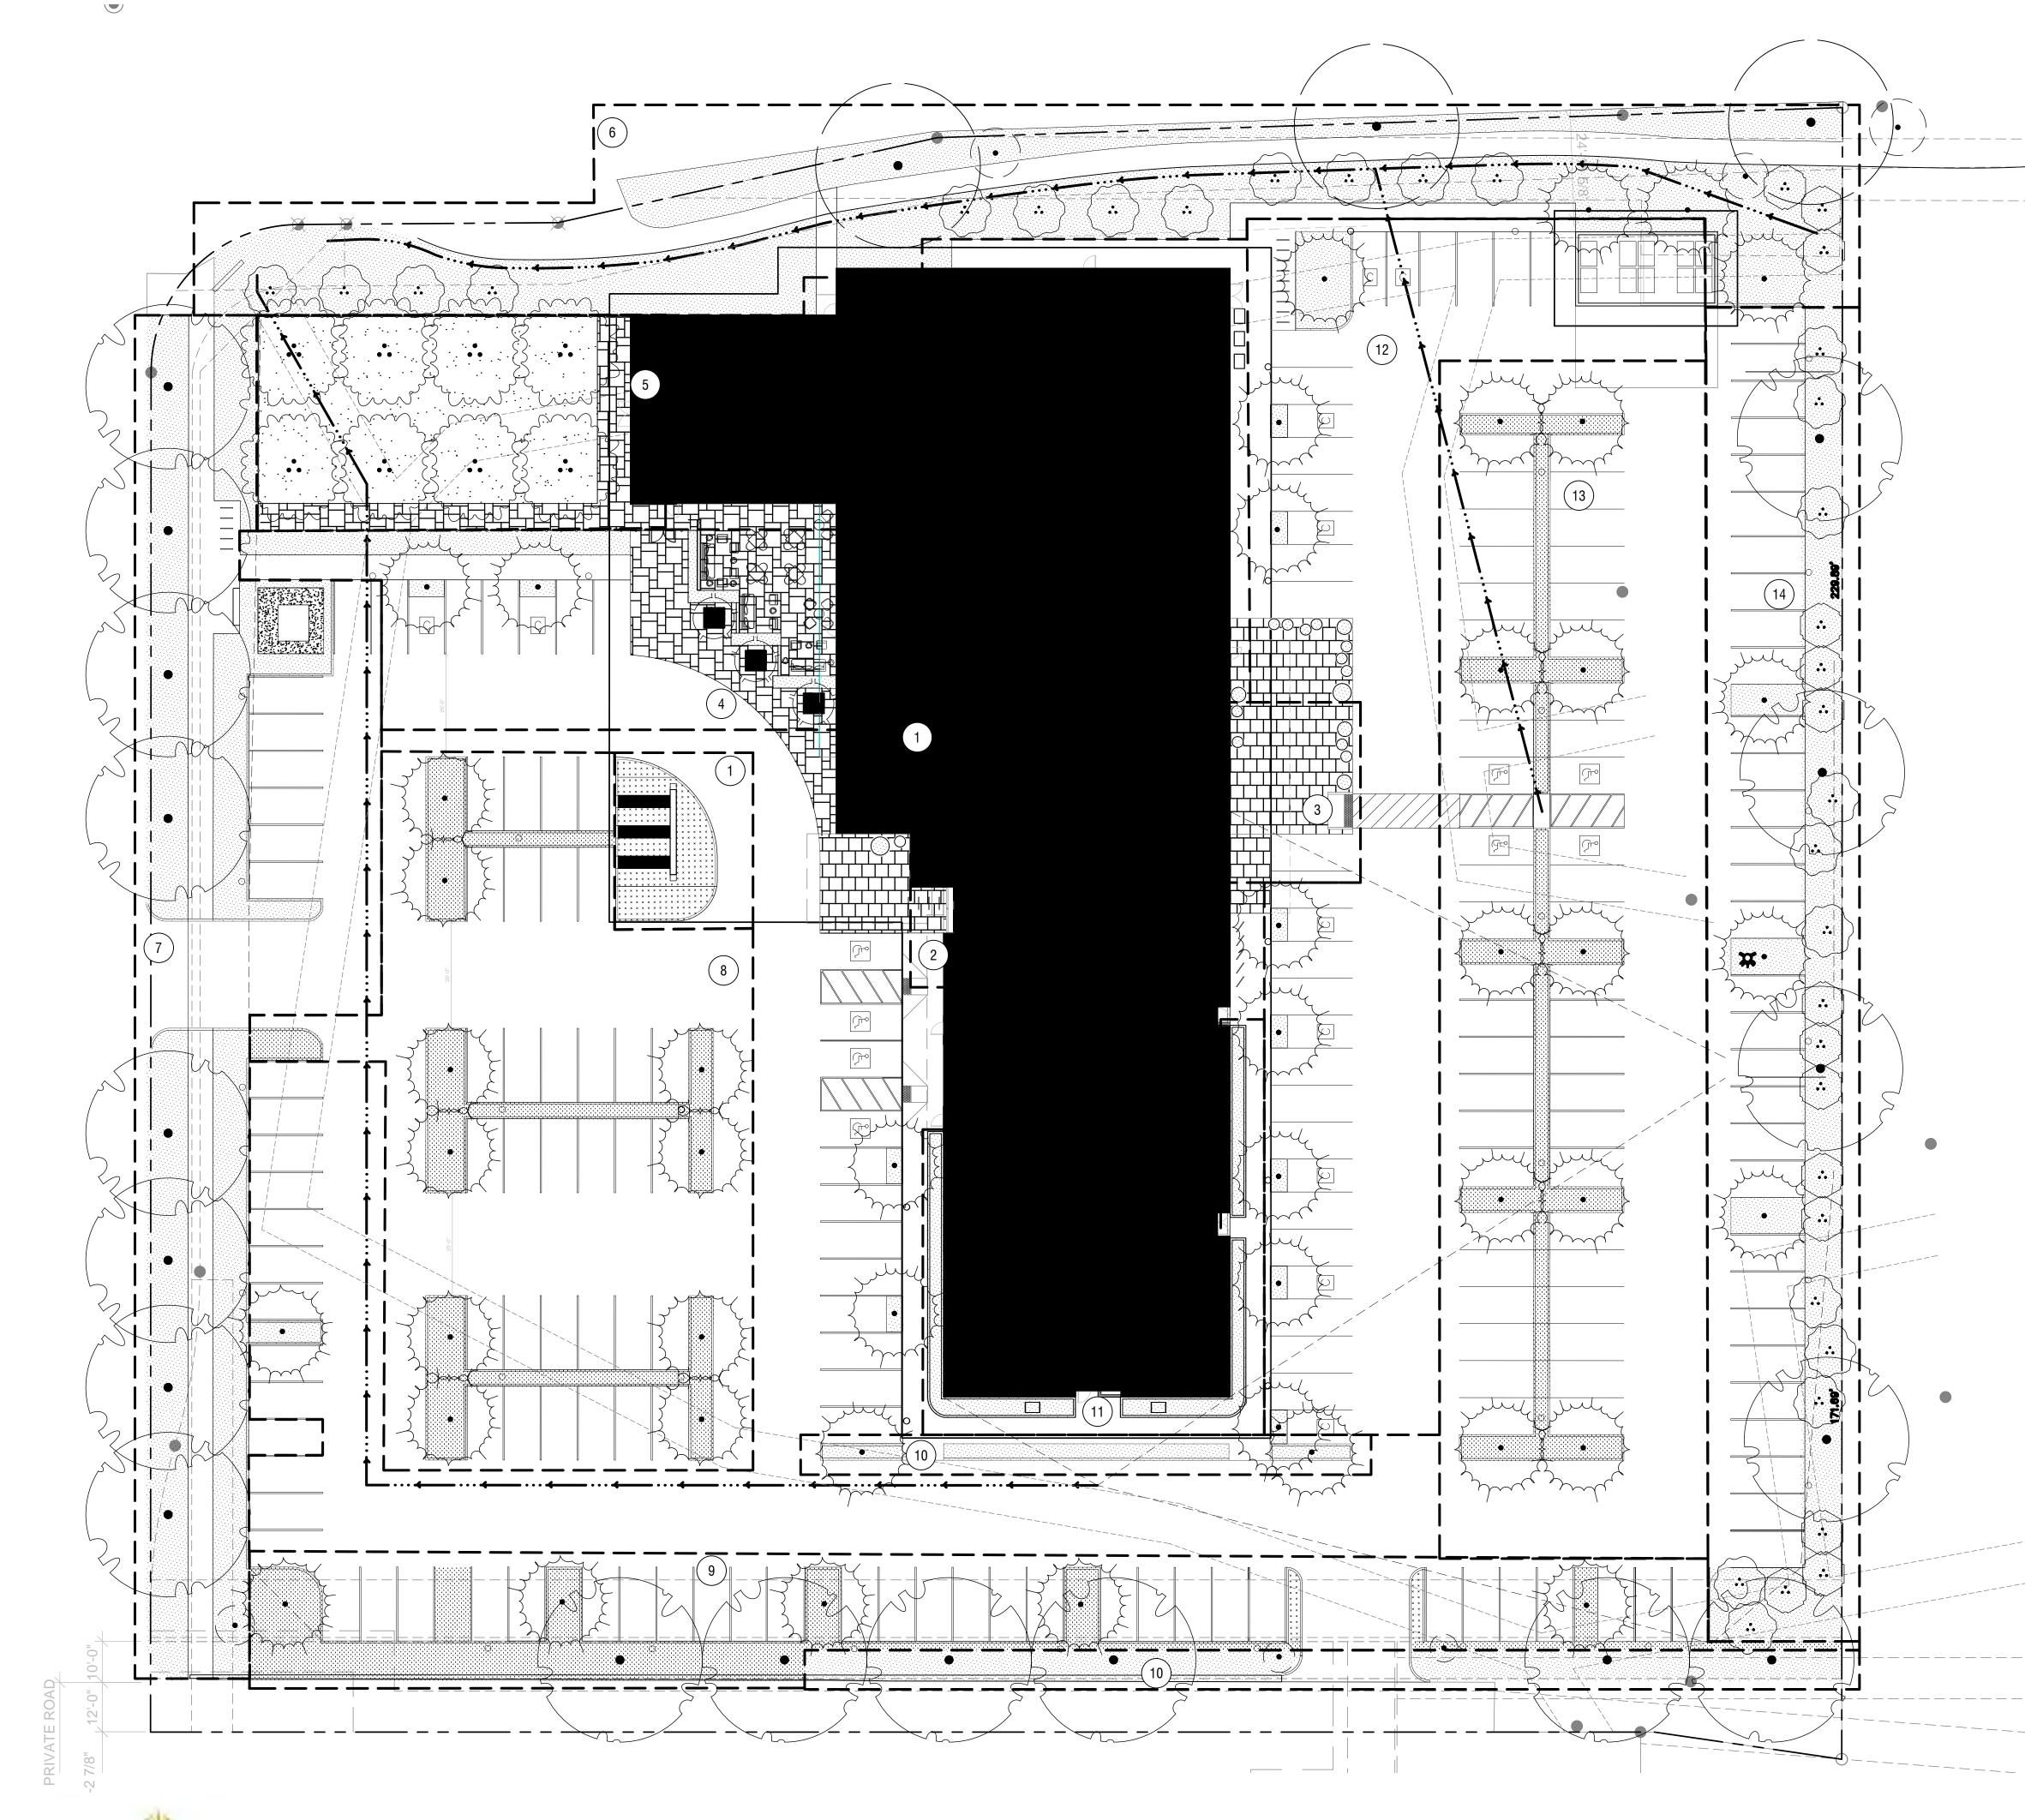

HYL	DROZOI	NE LEGEND				
NUM	IBER-	DESCRIPTION — —	EXPOSURE -	IRRIGATION TYPE	WATER USE	SQUARE FEET
	1	WETLAND FEATURE	WEST	DRIP	HIGH	848
	2	POTS	WEST	DRIP	LOW	83
	3	POTS	EAST	DRIP	LOW	117
	4	OUTDOOR SEATING	WEST	DRIP	LOW	888
	5	COURTYARD	WEST	DRIP	LOW	25
	6	STREET BUFFER	NORTH	DRIP	LOW	8257
	7	STREET BUFFER	WEST	DRIP	LOW	6052
	8	PARKING BIORETENTION	WEST	DRIP	MODERATE	2365
	9	PARKING BIORETENTION	SOUTH	DRIP	MODERATE	2940
1	10	PARKING	SOUTH	DRIP	LOW	2308
	11	BIORETENTION PLANTER	EAST, SOUTH, WEST	DRIP	LOW	896
1	12	PARKING	EAST	DRIP	LOW	890
1	13	PARKING BIORETENTION	EAST	DRIP	MODERATE	2107
1	14	PARKING WILDLIFE BUFFER	EAST	BUBBLERS	LOW	4098
		P00L				586
		HOT TUB				50

NATER USE LEGEND						
SYMBOL	WATER USAGE	SQUARE FEET				
	HIGH	848				
	MODERATE	7,408				
	LOW	29,914				

WELO COMPLIANCE MAWA = 387,468 GALLONS PER YEAR ETWU = 298,564 GALLONS PER YEAR

PROJECT MEETS THE WATER BUDGET


IRRIGATION DESIGN INTENT


IRRIGATION SYSTEM IS DESIGNED TO PROVIDE THE MINIMUM AMOUNT OF WATER NECESSARY TO SUSTAIN GOOD PLANT HEALTH. ALL SELECTED VANDAL RESISTANCE AND MINIMUM MAINTENANCE REQUIREMENT. THE SYSTEM IS A COMBINATION OF SUBSURFACE IRRIGATION AND TREE BUBBLERS AS APPROPRIATE TO PLANT TYPE, EXPOSURE, AND SLOPE CONDITIONS.

CONTROL OF THE SYSTEM IS VIA A WEATHER-ENABLED CONTROLLER CAPABLE OF DAILY SELF-ADJUSTMENT BASED ON REAL-TIME WEATHER CONDITIONS AS MEASURED BY AN ON-SITE WEATHER SENSOR.

THE SYSTEM INCLUDES A MASTER CONTROL VALVE AND FLOW SENSING CAPABILITY WHICH WILL SHUT DOWN ALL OR PART OF THE SYSTEM IF LEAKS ARE DETECTED.



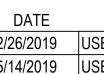

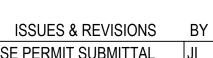





lowney